DRAWING LIST - ARCHITECTURAL MANUFACTURING											
SHEET NUMBER	SHEET NAME										
AM001	ARCHITECTURAL DRAWING LIST & GENERAL INFORMATION										
AM010	ASSEMBLY SCHEDULE, EQUIPMENT SCHEDULE, WINDOW & DOOR SCHEDULE										
AM101	OVERALL FLOOR PLAN										
AM500	BUILDING ENVELOPE DETAILS, MILLWORK ELEVATION										
AM501	BUILDING ENVELOPE DETAILS										
Crand total: E											

	DRAWING LIST - BKMs
SHEET NUMBER	SHEET NAME
BE-3011	WRB TEAR AND HOLE REPAIR
BE-3012	AIR BARRIER WRB INSTALLATION
FS-2803	SHEATHING MEMBRANE & WINDOW INSTALLATION PROCEDURE
FS-2805	WINDOW INSTALLATION PROCEDURE FOR MESA SIDING WITHOUT RAINSCREEN
FS-2808	SHEATHING MEMBRANE & DOOR INSTALLATION PROCEDURE
FS-2811	VENT INSTALLATION FLASHING DETAIL
FS-2813	EXTERIOR WALL WIRE PENETRATION SEAL UP
FS-2814	EXTERIOR WALL PIPE PENETRATION SEAL UP
FS-2816	EXTERIOR LIGHT INSTALLATION FOR MESA SIDING WITHOUT RAINSCREEN
FS-2829	EXTERIOR OUTLET INSTALLATION FOR MESA SIDING WITHOUT RAINSCREEN
FS-2835	VENT DETAIL FOR MESA SIDING WITHOUT RAINSCREEN
FS-2837	BARD FLASHING INSTALLATION OVER MESA SIDING WITHOUT RAINSCREEN
FS-2839	BARD JAMB & SECTION DETAIL FOR MESA SIDING WITHOUT RAINSCREEN
LS-3102	ATCO LABEL IN FASCIA LOCATIONS
SI-2723	FLOOR CORNER DETAILS FOR MESA SIDING WITHOUT RAINSCREEN
SI-2724	ROOF CORNER DETAIL FOR MESA SIDING WITHOUT RAINSCREEN
SI-2725	OUTSIDE CORNER DETAIL FOR MESA SIDING WITHOUT RAINSCREEN

OVERALL LIST - SERIAL NUMBERS												
UNIT NUMBER	SERIAL NUMBER	UNIT TYPE										
101	240256760											
101	240256761											
101	240256762											
101	240256763											
101	240256764											
101	240256765											
101	240256766											
101	240256767											
101	240256768											
101	240256769											

ARCHITECT	URAL ABBREVIATIONS		ARCHITECT
ABBREVIATION	DEFINITION		ABBREVIATION
ACC	ACCESSIBLE	m	
ACFL	ACCESS FLOOR	MATL	
AD	AREA DRAIN	MAX	
ADJ	ADJACENT	MECH	
4FF	ABOVE FINISHED FLOOR	MEZZ	
APPROX	APPROXIMATE	MIN	
ARCH	ARCHITECTURAL	MISC	
B/O	ВОТТОМ OF	mm	
BFC	BELOW FINISHED CEILING	N/A	
BLDG	BUILDING	NIC	
BSC	BELOW STRUCTURAL CEILING	No.	_
C/L	CENTRE LINE	NTS	-
C/W	COMPLETE WITH	O/C	_
CIP	CAST IN PLACE	O/H	_
CJ	CONTROL JOINT	OD OT	-
CLR	CLEARANCE	OPP	_
CMU		OWSJ	-
	COLUMN		-
COL	COLUMN	PLAM	-
CONC	CONCRETE	PSPI	_
CONT	CONTINUOUS	PSSI	_
DEG	DEGREES	PT	
DIA	DIAMETER	R	
OIM	DIMENSION	R/W	_
DL	DEAD LOAD	REINF	
DP	DEPTH	SF	
DWG	DRAWING	SIM	
EA	EACH	SOG	
EJ	EXPANSION JOINT	SPEC	
EL	ELEVATION	SQ	
ELEC	ELECTRICAL	SS	
ELEV	ELEVATOR	SSSI	
F/O	FACE OF	STC	
FD	FLOOR DRAIN	STD	
FE	FIRE EXTINGUISHER	STRUCT	
FIM	FREE ISSUE MATERIAL	SUSP	
FLR	FLOOR	T/O	
FT	FOOT/ FEET	TBD	
GA			-
	GAUGE	TOC TOF	_
GWB	GYPSUM WALL BOARD		_
GWG	GEORGIAN WIRE GLASS	TOS	_
GYP	GYPSUM	TYP	_
ID	INSIDE DIAMETER	U/G	
INFO	INFORMATION	U/S	
INSUL	INSULATION	UNO	
L	LENGTH	VERT	
LL	LIVE LOAD	W/C	_

DESIGN CRITERIA:
- 2020 NATIONAL BUILDING CODE OF CANADA, PART 9 - 2021 CANADIAN ELECTRICAL CODE - CLIMATE ZONE: 7 (ELECTRIC HEAT)

BUILDING HEAT LOSS/GAIN HEAT LOSS: -21°C HEAT GAIN: 34°C

ARROW INDICATES THE LOCATION OF THE ZERO END ON THE UNIT ORDINATE DIMENSIONS WILL START AT THIS POINT

SHIPPING DIRECTION: 🔼 ARROW INDICATES THE DIRECTION OF TRAVEL

EXAMPLE 1:		
0		ļ
ZERO END 🔷	BUILDING MODULE	
OR,		
EXAMPLE 2:		
0		<u>~</u>

BUILDING MODULE

©2025 ATCO STRUCTURES & LOGISTICS LTD. ALL RIGHTS RESERVED THESE DRAWINGS ALL RIGHTS RESERVED THESE DRAWINGS
CONTAIN CONFIDENTIAL INFORMATION AND ARE
THE PROPERTY OF ATCO STRUCTURES &
LOGISTICS LTD. THEY SHALL BE HELD IN
STRICTEST CONFIDENCE AND CANNOT BE
USED, COPIED, REPRODUCED DISCLOSED,
PUBLISHED, DISTRIBUTED OR OTHERWISE
EXPLOITED, IN ANY FORM OR MANNER, IN
WHOLE OR IN PART, FOR ANY REASON OTHER
THAN THE REASON FOR WHICH THEY WERE
PROVIDED TO YOU BY ATCO STRUCTURES &
LOGISTICS LTD. WITHOUT EXPRESSED LOGISTICS LTD., WITHOUT EXPRESSED WRITTEN CONSENT OF ATCO STRUCTURES &

FOR CONSTRUCTION

2025-08-13 ISSUED FOR CONSTRUCTION 2025-08-05 ISSUED FOR 90% REVIEW DATE DESCRIPTION

BY CHK/APR

DRAWING TITLE: 12x40 WHEELED OFFICE ARCHITECTURAL DRAWING LIST & **GENERAL INFORMATION** ONTARIO FLEET PROJECT NO: DRAWING NO: ATCO STRUCTURES

1127059

REV.#

AM001

1127059 - 12'x40' WHEELED OFFICE - ONTARIO FLEET ARCHITECTURAL MANUFACTURING



ATCO

24X36 SHEET - DO NOT PRINT TO OTHER SCALE.

INTERIOR

RSI = 2.11

ROOFS


EXTERIOR SIDE

3 1/2" FIBREGLASS BATT INSULATION - R12

POLY VAPOUR & AIR BARRIER - 6 MIL 1/4" VINYL COVERED LUAN PANEL

WOOD STUD - 2x4, 16" O/C

EXTERIOR RF01 EXTERIOR 47 MIL PVC ROOF MEMBRANE PLYWOOD SHEATHING, 1/2" SE - STANDARD
TAPERED WOOD JOIST - 2x8 to 2x10 7 1/4" to 9 1/4" FIBREGLASS BATT INTERIOR POLY VAPOUR & AIR BARRIER - 6 MIL 1/2" GWB RSI = 4.93

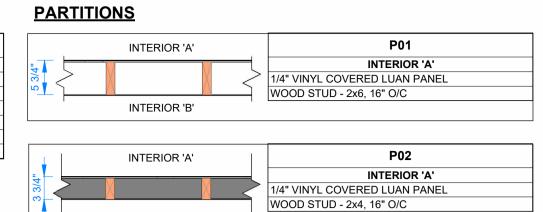

INTERIOR 'B'


FLOORS FL06 INTERIOR INTERIOR SIDE VINYL COMPOSITE TILE 12" x 12" PLYWOOD SHEATHING, 5/8" T&G SELECT R28 FIBREGLASS INSULATION
WOOD JOIST - 2x8
PLYWOOD SHEATHING 3/8" PT **EXTERIOR**

RSI = 4.93

	DOOR SCHEDULE - OVERALL																																								
										OR PANE	L PAI	RAMETER	s			FRAI	IE PAR	AMETERS		WARE		HARDWARE																			
							DIME	NSIO	NS	_				LITE	<u> </u>	-			KICKI	PLATE	-			∑																	
DOR AG		FUNCTION	SWING	PANEL TYPE	SILL HEIGHT	WIDTH	неіснт	ROUGH WIDTH	коисн неіснт	EXTERIO	R	INTERIOR		WIDTH	НЕІСНТ	FRAME TYPE	THROAT SIZE	FRAME COLOUR	WIDTH	НЕІСНТ	ELEC	FIRE RATING DOREX 9500FH53, KEYED ENTRY LEVER LOCKSET	DOREX 9500PR3 GRADE 1, PUSH PANIC	DOREX 9500TL70, PANIC CLASSROOM LEVER LOCKSET W	DOREX 9500TL10 GRADE 1PANIC PASSAGE LEVER LOCKSET DOREX 9500FH42, LEVER PRIVACY SET		FALCON D241P6F, DEAD BOLT	W14x17-2, ALUMINUM NEOPRENE	D-PULL, ALUMINUM 9", CW 4X16" PUSH PLATE	BALL BEARING HINGES, 4 1/2" X 4"	DOREX 1900AL GRADE 1 DOOR CLOSER	DOREX 1900 BFAL SURFACE	SURFACE MOUNTED DOOR CLOSER 7	DS1382 ADJUSTABLE DOOR I	DS136X36" ALUM NEOPRENE	T218 DOOR STOP, FLOOF	T233 DOOR STOP, WALL MOUNTED 36 HINGE PIN DOOR STOP	3560 - 25 1/2" HEAVY D	4" THRESHOLD 6" THRESHOLD	6" THERM BRK THRESHOLD	COMME
62C 2	2	Exterior	r RHR	HMI	0"	36"	84"	38"	85"	CHARCO		CHARCOA GREY	L Yes	10"		EXP REV	4 1/8"	CHARCOAL GREY	34 1/2"	12"	No	- No	No I	No N	lo No	Yes	Yes	Yes	No Ye	es 3	Yes	No N	o No	No	No	No N		Yes		1	

			AME METERS	EXP			PANEL METERS												
DOOR TAG	QTY	THROAT SIZE	FRAME TYPE	FRAME SIZE	SWING	DIMENSIONS												FUNCTION	COMMENTS
D162C	2	4 1/8"	EXP REV	MEDIUM	RHR	36"	84"	Exterior	COMMENT										
	2																		
85"	40	38" 36" 10'	6"																
		D162C HMI 36x84 10x18 LITE EXP REV																	

	WINDOW SCHEDULE - OVERALL															
	DIMENSIONS				ROUGH OPENING				GLAZING				WINDOW			
				HEAD	SILL					FINISH	JAMB		WINDOW	WINDOW	U-VALUE,	
WINDOW NO.	QTY	WIDTH	HEIGHT	HEIGHT	HEIGHT	TYPE	WIDTH	HEIGHT	MATERIAL	COLOUR	THICKNESS	DESCRIPTION	COLOUR	SHGC	(W/m²K)	COMMENTS
WS01	4	48"	36"	78"	42"	ARBOURVIEW SINGLE	49"	37"			4 1/8"	ARBOURVIEW SINGLE	WHITE	0.45	2	
						SLIDER						SLIDER				

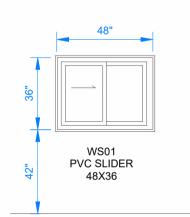

A - WINDOW LEGEND

1/4" = 1'-0"

	FURNISHING SCHEDULE													
TAG	QTY	DESCRIPTION	SCOPE											
FR-1	2	4 HOOK COAT HOOK BOARD. 5" x 24"	PSPI											
FR-2	1	24" x 48" CORKBOARD	PSPI											

ATCO


©2025 ATCO STRUCTURES & LOGISTICS LTD. ALL RIGHTS RESERVED THESE DRAWINGS ALL RIGHTS RESERVED THESE DRAWINGS
CONTAIN CONFIDENTIAL INFORMATION AND ARE
THE PROPERTY OF ATCO STRUCTURES &
LOGISTICS LTD. THEY SHALL BE HELD IN
STRICTEST CONFIDENCE AND CANNOT BE
USED, COPIED, REPRODUCED DISCLOSED,
PUBLISHED, DISTRIBUTED OR OTHERWISE
EXPLOITED, IN ANY FORM OR MANNER, IN
WHOLE OR IN PART, FOR ANY REASON OTHER
THAN THE REASON FOR WHICH THEY WERE
PROVIDED TO YOU BY ATCO STRUCTURES &
LOGISTICS LTD., WITHOUT EXPRESSED
WRITTEN CONSENT OF ATCO STRUCTURES & WRITTEN CONSENT OF ATCO STRUCTURES & LOGISTICS LTD.

24X36 SHEET - DO NOT PRINT TO OTHER SCALE.

FOR CONSTRUCTION

					PROJECT:
					CLIENT:
0	2025-08-13	ISSUED FOR CONSTRUCTION	DK	CM	
Α	2025-08-05	ISSUED FOR 90% REVIEW	DK		
REV.	DATE	DESCRIPTION	BY	CHK/APR	


:		DRAWING TITLE:		
	12x40 WHEELED OFFICE ONTARIO FLEET	SCHEDULE,	HEDULE, EQUIPI , WINDOW & DOC CHEDULE	
		PROJECT NO:	DRAWING NO:	REV.#
	ATCO STRUCTURES	1127059	AM010	0

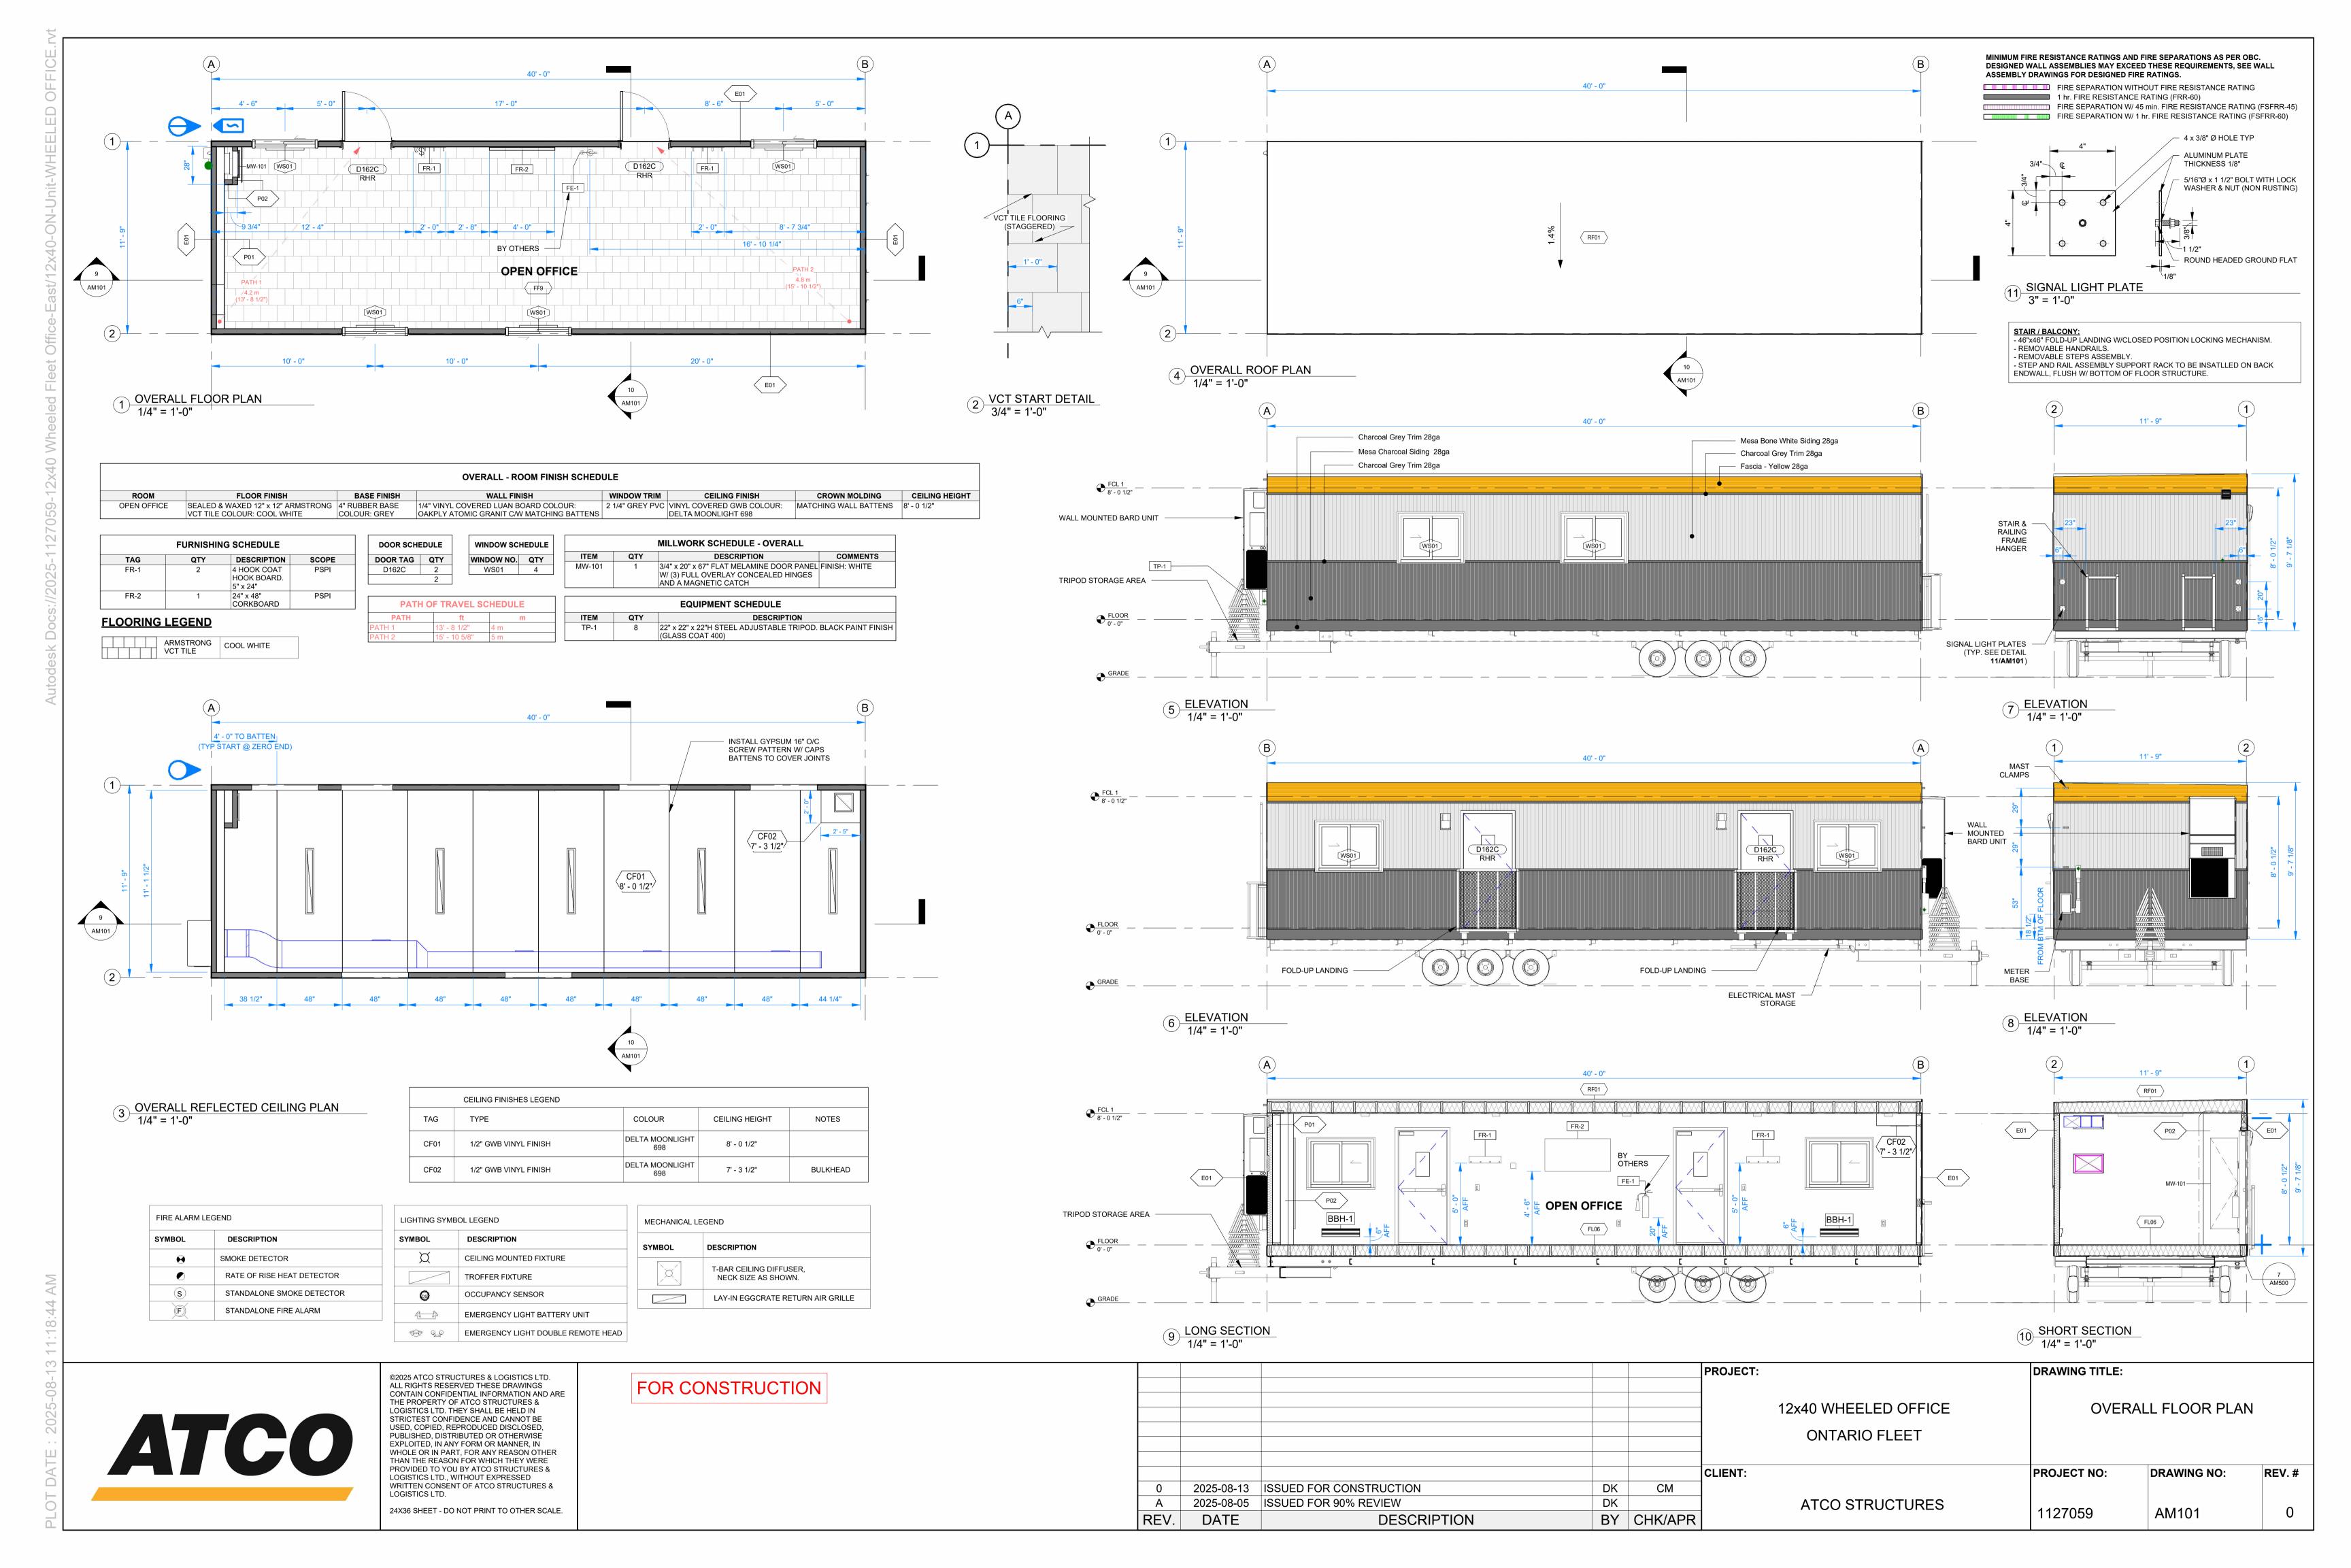








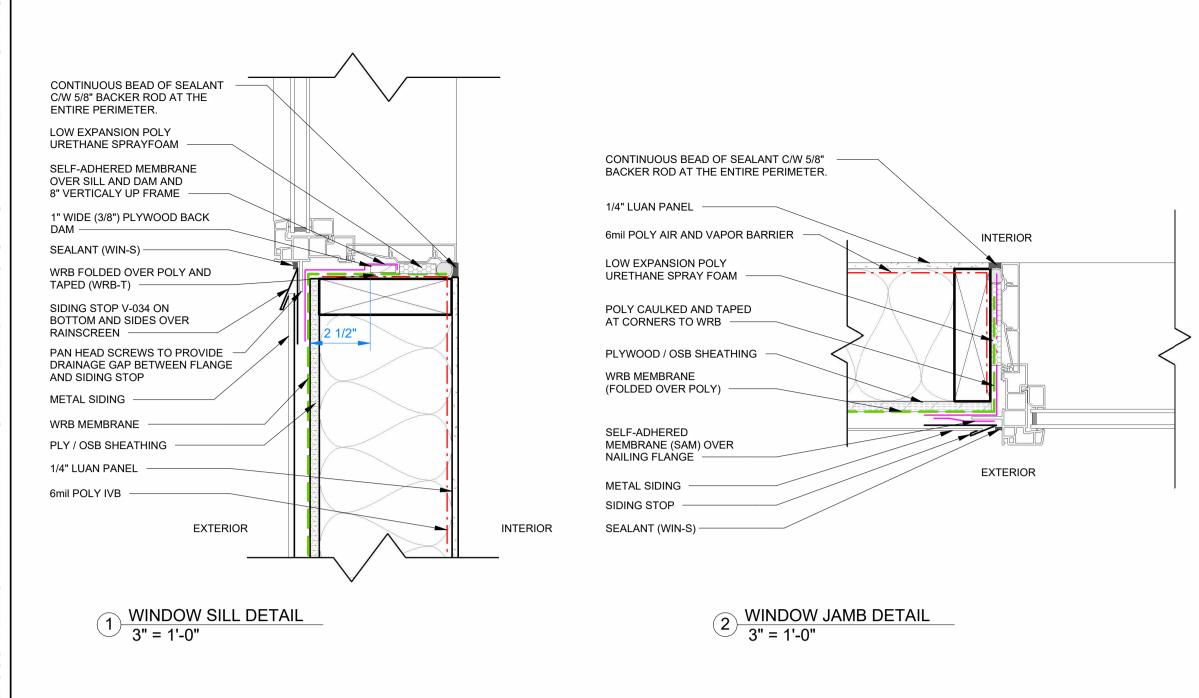

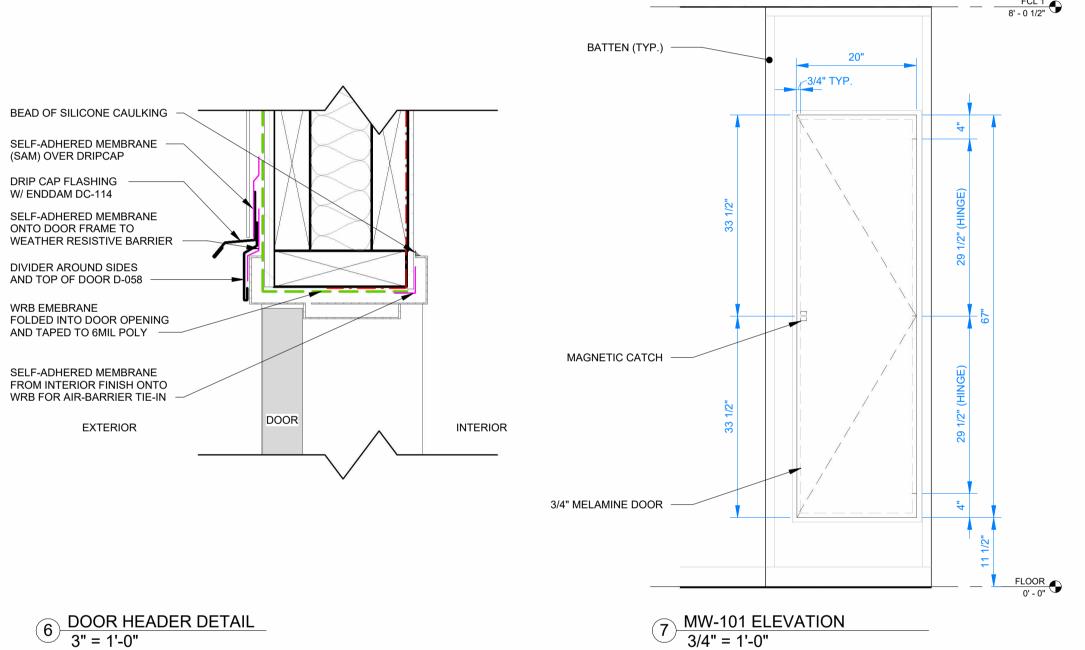

©2025 ATCO STRUCTURES & LOGISTICS LTD. ALL RIGHTS RESERVED THESE DRAWINGS


ALL RIGHTS RESERVED THESE DRAWINGS
CONTAIN CONFIDENTIAL INFORMATION AND ARE
THE PROPERTY OF ATCO STRUCTURES &
LOGISTICS LTD. THEY SHALL BE HELD IN
STRICTEST CONFIDENCE AND CANNOT BE
USED, COPIED, REPRODUCED DISCLOSED,
PUBLISHED, DISTRIBUTED OR OTHERWISE
EXPLOITED, IN ANY FORM OR MANNER, IN
WHOLE OR IN PART, FOR ANY REASON OTHER
THAN THE REASON FOR WHICH THEY WERE
PROVIDED TO YOU BY ATCO STRUCTURES &

PROVIDED TO YOU BY ATCO STRUCTURES &

24X36 SHEET - DO NOT PRINT TO OTHER SCALE.

LOGISTICS LTD., WITHOUT EXPRESSED WRITTEN CONSENT OF ATCO STRUCTURES &

LOGISTICS LTD.

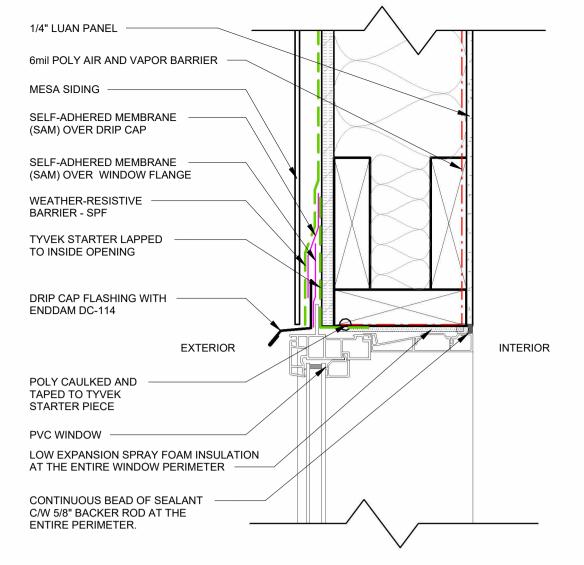

3" = 1'-0"

METAL THRESHOLD INTERIOR SELF-ADHERED MEMBRANE LAPPED ONTO METAL BACKDAM AND WRAP OVER DOOR SILL AND UP SIDES MIN 8" **EXTERIOR** DOOR EDGE CORNER, C-112 STARTER FLASHING SL-634 -EXTERIOR SHEATHING WEATHER RESISTIVE BARRIER

VINYL SHEET FLOORING

SEALANT (WIN-S)

SEAL JOINT BETWEEN THRESHOLD AND

BASE OF DOOR FRAME WITH AIR BARRIER

4 DOOR SILL DETAIL
3" = 1'-0"

DOOR

5 DOOR JAMB - EXP DETAIL
3" = 1'-0"

SELF-ADHERED MEMBRANE

FROM INTERIOR FINISH ONTO

WRB FOR AIR-BARRIER TIE-IN.

BEAD OF SILICON CAULKING

WRB MEMEBRANE

TO 6MIL POLY

SIDING STOP -

BARRIER -

SELF-ADHERED MEMBRANE

ONTO DOOR FRAME TO

DIVIDER AROUND SIDES

AND TOP OF DOOR, D-058

WEATHER RESISTIVE

FOLDED INTO DOOR

OPENING AND TAPED

INTERIOR

EXTERIOR

DOOR

WRB - WEATHER RESISTANT BARRIER SAM - SELF ADHERED MEMBRANE

ABBREVIATIONS:

AB - AIR BARRIER VB - VAPOUR BARRIER


						PROJEC
FOR CONSTRUCTION						
						CLIENT
	0	2025-08-13	ISSUED FOR CONSTRUCTION	DK	СМ	
	A	2025-08-05	ISSUED FOR 90% REVIEW	DK		

DRAWING TITLE: BUILDING ENVELOPE DETAILS, 12x40 WHEELED OFFICE MILLWORK ELEVATION ONTARIO FLEET PROJECT NO: DRAWING NO: REV.# NT: ATCO STRUCTURES 1127059 AM500 REV. DATE DESCRIPTION BY CHK/APR

6 DOOR HEADER DETAIL
3" = 1'-0"





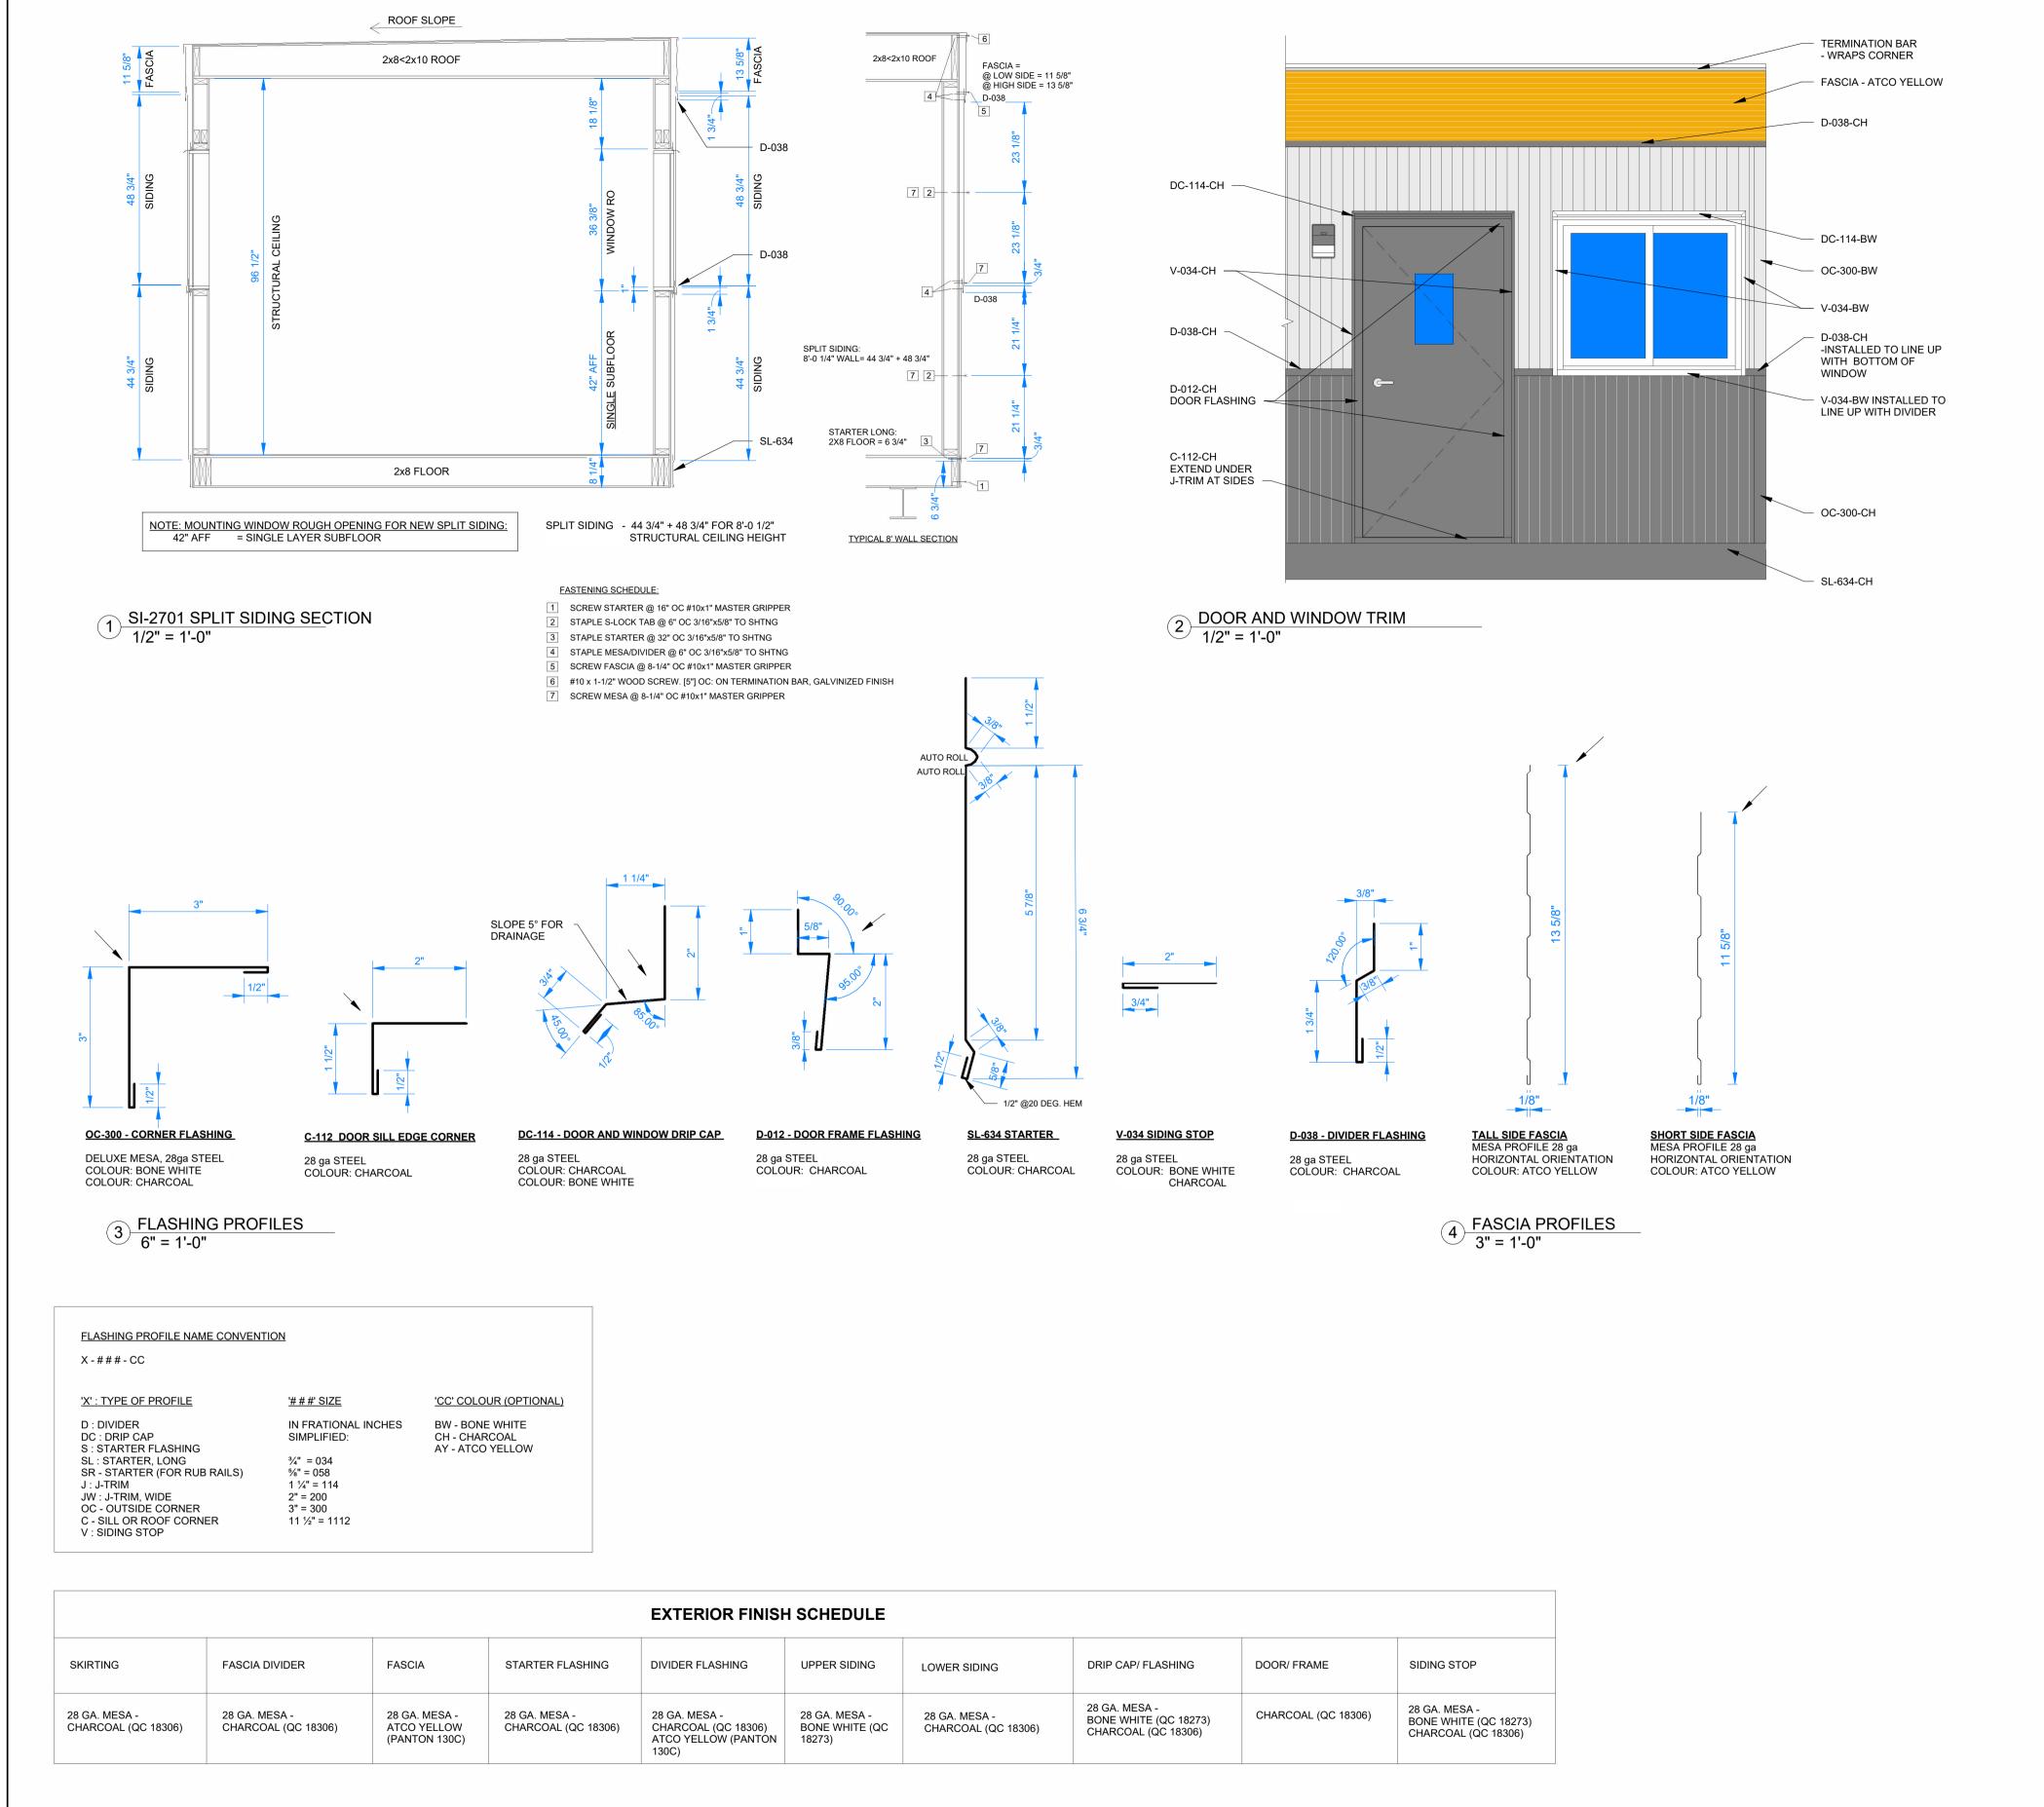

FOR CONSTRUCTION

ATCO

©2025 ATCO STRUCTURES & LOGISTICS LTD.
ALL RIGHTS RESERVED THESE DRAWINGS
CONTAIN CONFIDENTIAL INFORMATION AND ARE
THE PROPERTY OF ATCO STRUCTURES &
LOGISTICS LTD. THEY SHALL BE HELD IN
STRICTEST CONFIDENCE AND CANNOT BE
USED, COPIED, REPRODUCED DISCLOSED,
PUBLISHED, DISTRIBUTED OR OTHERWISE
EXPLOITED, IN ANY FORM OR MANNER, IN
WHOLE OR IN PART, FOR ANY REASON OTHER
THAN THE REASON FOR WHICH THEY WERE
PROVIDED TO YOU BY ATCO STRUCTURES &
LOGISTICS LTD., WITHOUT EXPRESSED
WRITTEN CONSENT OF ATCO STRUCTURES &
LOGISTICS LTD.

24X36 SHEET - DO NOT PRINT TO OTHER SCALE.

	NVELOPE DETAILS
	WELOFE DETAILS
	DRAWING NO: REV. #
2	
2	AN4504
/ .	AIVIOUT
	DRAWIN AM50

DRAV	VING LIST - ELECTRICAL MANUFACTURING
UMBER	SHEET NAME
01	ELECTRICAL DRAWING LIST & GENERAL INFORMATION

OVERALL POWER & DATA PLAN - LEVEL 1

EM101

Grand total: 2

GENERAL ELECTRICAL NOTES:

1. ALL WIRE SHALL BE MIN OF #14 AWG, UNLESS OTHERWISE SPECIFIED.

2. ALL WIRING MUST CONFORM TO CEC 2024 (C22.1-24).

3. ALL ELECTRICAL DEVICES ARE TO BE WHITE IN COLOUR.

4. ALL DIMENSIONS ARE APPROXIMATE, UNLESS OTHERWISE SPECIFIED.

5. LOCATION OF ELECTRICAL DEVICES ARE APPROXIMATE, UNLESS OTHERWISE SPECIFIED. 6. ALL MOUNTING HEIGHTS ARE ABOVE FINISHED FLOOR (AFF), UNLESS OTHERWISE SPECIFIED.

7. ALL RECEPTACLE, SWITCH, AND JUNCTION BOX COVER PLATES SHALL BE LABELED WITH WHITE LABELS C/W BLACK LETTERING AND SHALL IDENTIFY THE PANEL NAME AND CIRCUIT BREAKER NUMBER. 8. ALL ELECTRICAL COMPONENTS SHALL CONFORM WITH CSA CERTIFICATIONS AND BEAR CSA LABELS.

9. WHERE DEVICE RELOCATION IS REQUIRED DUE TO CONFLICTS WITH OTHER DEVICES AND/OR EQUIPMENT, THE ELECTRICAL CONTRACTOR SHALL INSTALL THE DEVICES UP TO 1M/3 FEET FROM ORIGINAL LOCATION WITHOUT APPROVAL FROM THE ENGINEER. THE ELECTRICAL CONTRACTOR SHALL PROVIDE ALL REDLINE DRAWINGS TO ATCO ENGINEERING UPON

10. WHERE A DEVICE IS SPECIFIED WITH AN EXACT MODEL NUMBER AND AN ALTERNATE IS PROVIDED, ENGINEERING MUST BE NOTIFIED AND THE ALTERNATE DEVICES MUST BE APPROVED PRIOR TO INSTALLATION.

LIGHTING NOTES:

COMPLETION OF MANUFACTURING.

1. REFER TO LUMINAIRE SCHEDULE FOR LIGHT FIXTURE TYPES.

2. ALL WIRE SHALL BE #12 AWG FOR EMERGENCY REMOTE HEADS.

3. DISCONNECT LEADS OF THE EMERGENCY BATTERY PACKS FROM BATTERY TERMINALS PRIOR TO SHIPPING. ONCE ON SITE, RECONNECT LEADS, CHARGE FOR TWENTY-FOUR (24) HOURS THEN TEST ALL EMERGENCY/EXIT LIGHT BATTERIES FOR 30

1. TELEPHONE/DATA OUTLETS SHALL HAVE 3/4" EMT CONDUIT STUBBED UP TO ABOVE DROPPED CEILING COMPLETE WITH PLASTIC BUSHING AND PULL STRING. METALLIC DEVICE BOXES USED FOR TELEPHONE/DATA TO BE BONDED TO NEAREST RECEPTACLE.

2. ALL BASEBOARD HEATER THERMOSTAT WIRES SHALL BE LINE VOLTAGE WITH THE CORRECT AMPACITY FOR THE DEVICE

3. ALL THERMOSTAT AND HVAC CONTROL WIRING TO BE CONNECTED AS PER MANUFACTURING SPECIFICATIONS. 4. ALL ELECTRIC RESISTANCE SPACE HEATERS SHALL BE CONTROLLED BY INDEPENDENT THERMOSTATS LOCATED IN THE SPACE AS PER CAN/CSA-C828.

5. HEAT TRACE PROVISION IS AN EMT STUB DOWN FROM MAIN ELECTRICAL PANEL AND PROVISIONAL 30 MILLIAMP RATED GFCI BREAKER INSTALLED IN THE ELECTRICAL PANEL.

6. REFER TO MECHANICAL DRAWINGS FOR EXACT LOCATIONS AND MOUNTING HEIGHTS OF ALL MECHANICAL EQUIPMENT PRIOR TO INSTALLATION.

7. ALL ELECTRICAL MATERIAL AND INSTALLATIONS SHOWN AND/OF SPECIFIED SHALL BE INSTALLED AS PER THE MANUFACTURER'S RECOMMENDATIONS AND SHALL COMPLY IN STRICT ACCORDANCE WITH THE LATEST EDITION OF CSA STANDARDS AND THE CEC (C22.1-24).

PANELBOARD NOTES:

1. PANELBOARDS SHALL BE COMPLETE WITH PANEL SCHEDULES, ARC FLASH STICKERS.

2. MAIN SERVICE CONNECTION TO MAIN PANELBOARD TO BE COMPLETED ON SITE (BY OTHERS).

	LIGHTING SYMBOL LEGEND	
SYMBOL	DESCRIPTION	MOUNTING HEIGHT
\$	LIGHT SWITCH	48" AFF TO CENTRE , UNLESS OTHERWISE SPECIFIED
\otimes + \dagger	UNIVERSAL RUNNING MAN EXIT SIGN	84" AFF TO CENTRE , UNLESS OTHERWISE SPECIFIED
4 4	EMERGENCY LIGHT BATTERY UNIT	84" AFF TO TOP , UNLESS OTHER WISE SPECIFIED
F07 Q_0	EMERGENCY LIGHT DOUBLE REMOTE HEAD	84" AFF TO CENTRE , UNLESS OTHERWISE SPECIFIED
\succeq	EXTERIOR LIGHT FIXTURE	77" AFF TO WIRE STUB OUT , UNLESS OTHERWISE SPECIFIED
¤	CEILING MOUNTED FIXTURE	
HX	WALL SCONCE FIXTURE	84" AFF TO CENTRE , UNLESS OTHERWISE SPECIFIED
	TROFFER FIXTURE	
A	FIXTURE TYPE TAG - REFER TO LUMINAIRE SCHEDULE	N/A

	POWER SYMBOL LEGEND	
SYMBOL	DESCRIPTION	MOUNTING HEIGHT
φ	5-15R, 120VAC, TAMPER-PROOF, DUPLEX RECEPTACLE	18" AFF TO CENTRE OF DEVICE BOX, UNLESS OTHERWISE SPECIFIED
Ŷ	SPECIAL RECEPTACLE, REFER TO DRAWING FOR DETAILS	REFER TO DRAWING FOR DETAILS
	HARDWIRED ELECTRICAL CONNECTION TO EQUIPMENT	
J	JUNCTION BOX, CONTAINING CIRCUIT FEEDS AS INDICATED	
	ELECTRICAL PANELBOARD, REFER TO PANEL SCHEDULE FOR SIZING, MODEL AND BREAKER LAYOUT. SURFACE MOUNTED.	66" AFF TO HIGHEST OVERCURRENT DEVICE
\$_M	120V 15A MOTOR RATED SWITCH	48" AFF TO CENTRE OF DEVICE BOX, UNLESS OTHERWISE SPECIFIED

	FIRE ALARM SYMBOL LE	GEND
SYMBOL	DESCRIPTION	MOUNTING HEIGHT
1	ISOLATION MODULE	84" AFF TO CENTRE , UNLESS OTHERWISE SPECIFIED
М	MANUAL PULL STATION	42" AFF TO CENTRE , UNLESS OTHERWISE SPECIFIED
MM	MONITOR MODULE	
СМ	CONTROL MODULE	
•	SMOKE DETECTOR	
Ø	HEAT DETECTOR	
	MINI HORN	90" AFF TO CENTRE , OR MIN 6" BELOW FCL TO TOP
-\ F	HORN / STROBE COMBO	78" AFF TO BOTTOM , UNLESS OTHERWISE SPECIFIED
		78" AFF TO BOTTOM , UNLESS OTHERWISE SPECIFIED
EOL	END OF LINE RESISTOR	N/A

E	ELECTRICAL ABBREVIATIONS
ABBREVIAT ION	DESCRIPTIONS
AFCI	ARC FAULT CIRCUIT INTERRUPTER
AFF	ABOVE FINSHED FLOOR
DP	DISTRIBUTION PANEL
FACP	FIRE ALARM CONTROL PANEL
GFCI	GROUND FAULT CIRCUIT INTERRUPTER
MCA	MINIMUM CIRCUIT AMPCITY
MCB	MAIN CIRCUIT BREAKER
MLO	MAIN LUG ONLY
MOCP	MAXIMUM OVERCURRENT CIRCUIT PROTECTION
MP	MAIN PANEL
SP	SUB PANEL
WP	WEATHER PROOF

CODE & DESIGN COMPLIANCE REFERENCE 1. NATIONAL BUILDING CODE 2023, PART 10 2. CANADIAN ELECTRICAL CODE 2024 (C22.1:24)



©2025 ATCO STRUCTURES & LOGISTICS LTD. ALL RIGHTS RESERVED THESE DRAWINGS ALL RIGHTS RESERVED THESE DRAWINGS
CONTAIN CONFIDENTIAL INFORMATION AND ARE
THE PROPERTY OF ATCO STRUCTURES &
LOGISTICS LTD. THEY SHALL BE HELD IN
STRICTEST CONFIDENCE AND CANNOT BE
USED, COPIED, REPRODUCED DISCLOSED,
PUBLISHED, DISTRIBUTED OR OTHERWISE
EXPLOITED, IN ANY FORM OR MANNER, IN
WHOLE OR IN PART, FOR ANY REASON OTHER
THAN THE REASON FOR WHICH THEY WERE
PROVIDED TO YOU BY ATCO STRUCTURES & PROVIDED TO YOU BY ATCO STRUCTURES & LOGISTICS LTD., WITHOUT EXPRESSED WRITTEN CONSENT OF ATCO STRUCTURES & LOGISTICS LTD.

24X36 SHEET - DO NOT PRINT TO OTHER SCALE.


FOR CONSTRUCTION


2025-08-13 ISSUED FOR CONSTRUCTION CM JW 2025-08-05 | ISSUED FOR 90% REVIEW JW REV. DATE DESCRIPTION BY CHK/APR

DRAWING TITLE:		
	_	⁻ &
PROJECT NO:	DRAWING NO:	REV.
1127059	EM001	0
	ELECTRICA GENERA PROJECT NO:	ELECTRICAL DRAWING LIST GENERAL INFORMATION PROJECT NO: DRAWING NO:





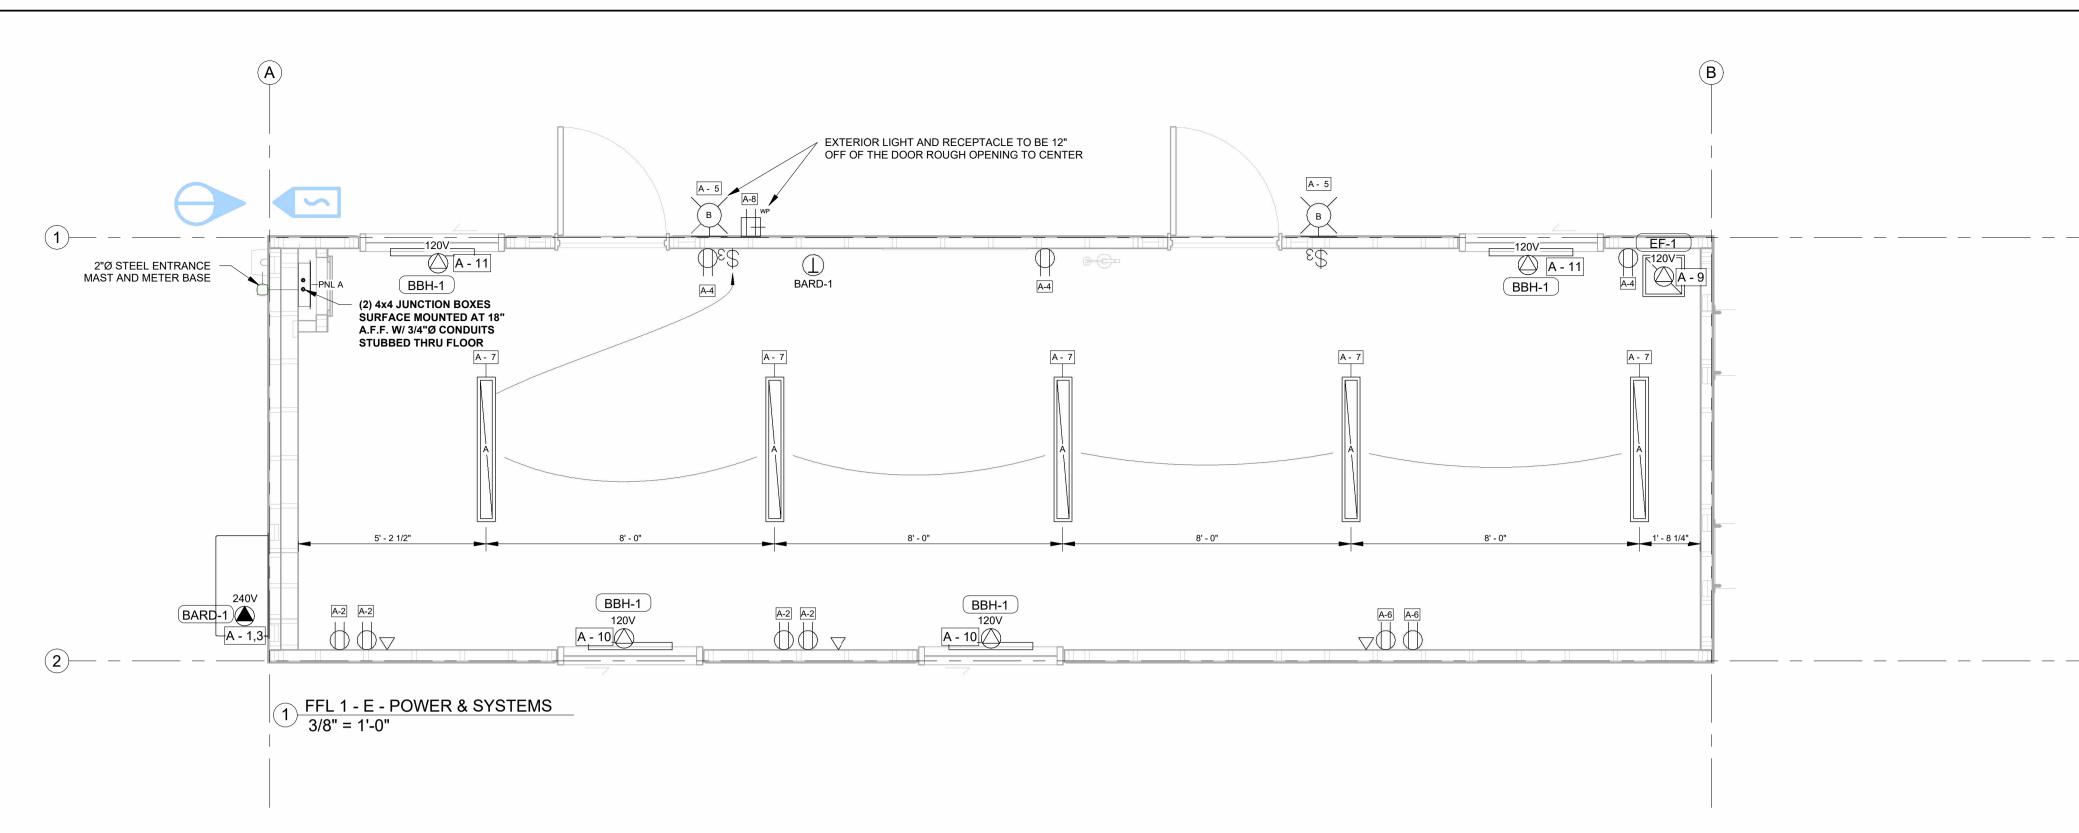

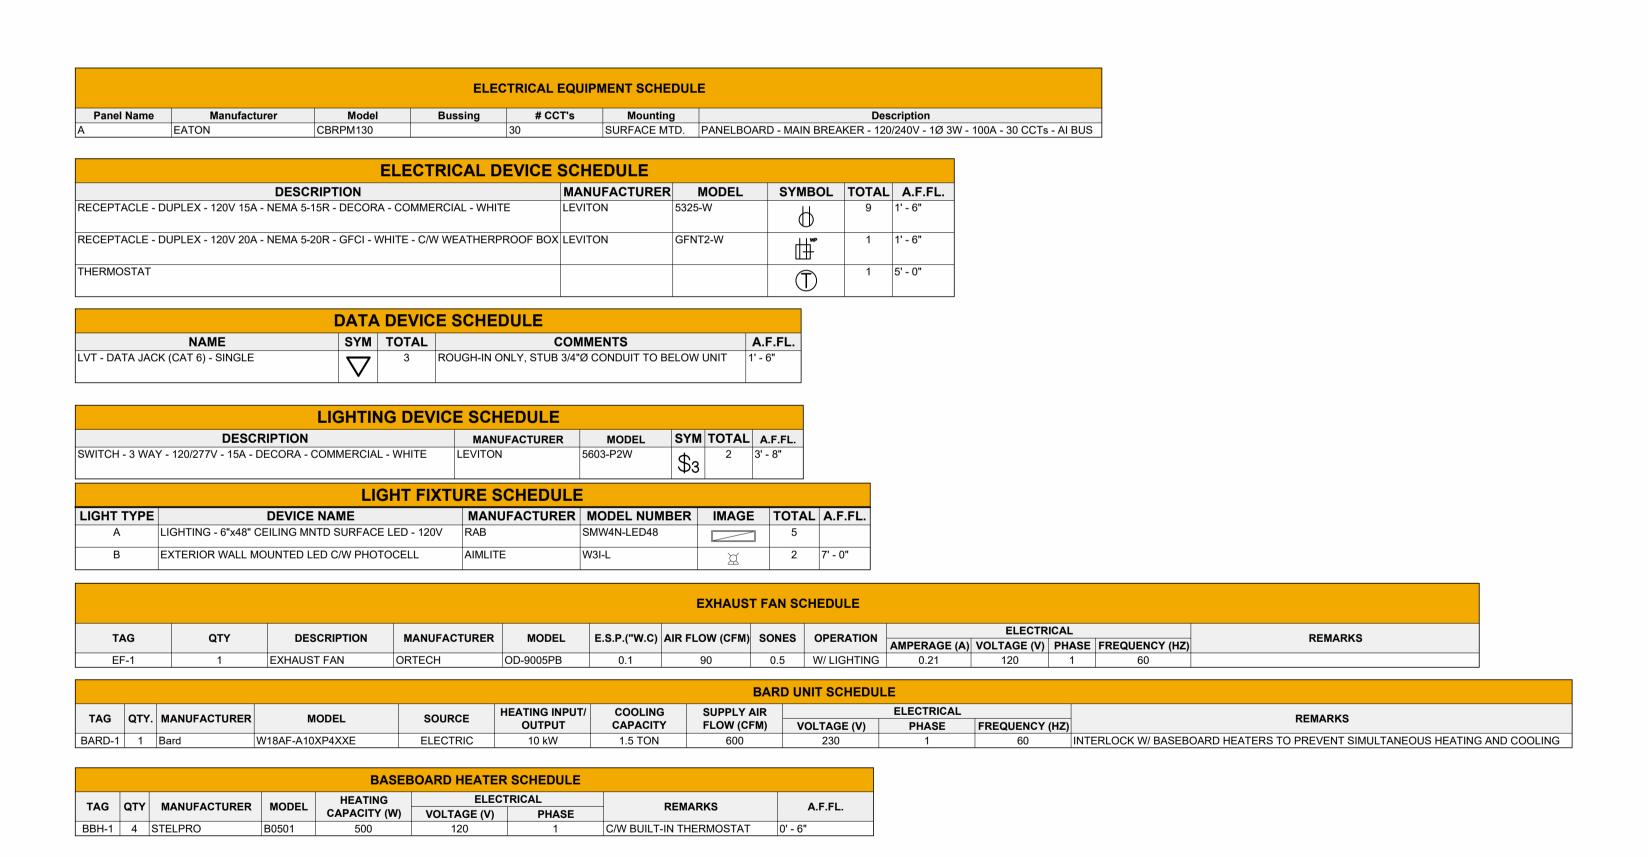

FOR CONSTRUCTION

Location: Unit #: Supply From: Mounting: SURFACE MTD. Enclosure:			Volts: 120/240 Single Phases: 1 Wires: 3 Cable Size: Stub Requirements: 1 1/4" STUB					Panel Model #: CBRPM130 Bus Rating: 100 A MCB Rating: 100 A MLO Rating: N/A Est. Demand Load: 16 kW			
#	Circuit Description	Trip	ø		\	ı	В	ø	Trip	Circuit Description	
1	DADD LINUT (DADD 4)	CO A		5000 VA	1440 VA			1	15 A	RECEPTACLES	
3	BARD UNIT (BARD-1)	60 A	2			5000 VA	1080 VA	1	15 A	RECEPTACLES	
5	EXTERIOR LIGHTS	15 A	1	28 VA	720 VA			1	15 A	RECEPTACLES	
7	INTERIOR LIGHTS	15 A	1			190 VA	360 VA	1	20 A	EXTERIOR RECEPTACLE GFCI	
9	EXHAUST FAN (EF-1)	15 A	1	25 VA	1000 VA			1	15 A	BASEBOARD HEATERS (BBH-1)	
11	BASEBOARD HEATERS (BBH-1)	15 A	1			1000 VA					
13											
15											
17											
19											
21											
23											
25											
27											
29											
					١		В				
			I Load		3 VA		0 VA				
		Tota	I Amp	68.	4 A	63.	.6 A			: 15843 VA	

AT	CO

©2025 ATCO STRUCTURES & LOGISTICS LTD.
ALL RIGHTS RESERVED THESE DRAWINGS
CONTAIN CONFIDENTIAL INFORMATION AND ARE
THE PROPERTY OF ATCO STRUCTURES &
LOGISTICS LTD. THEY SHALL BE HELD IN
STRICTEST CONFIDENCE AND CANNOT BE
USED, COPIED, REPRODUCED DISCLOSED,
PUBLISHED, DISTRIBUTED OR OTHERWISE
EXPLOITED, IN ANY FORM OR MANNER, IN
WHOLE OR IN PART, FOR ANY REASON OTHER
THAN THE REASON FOR WHICH THEY WERE
PROVIDED TO YOU BY ATCO STRUCTURES &
LOGISTICS LTD., WITHOUT EXPRESSED
WRITTEN CONSENT OF ATCO STRUCTURES &
LOGISTICS LTD.

24X36 SHEET - DO NOT PRINT TO OTHER SCALE.

					PROJECT:
					CLIENT:
0	2025-08-13	ISSUED FOR CONSTRUCTION	JW	CM	
Α	2025-08-05	ISSUED FOR 90% REVIEW	JW		
REV.	DATE	DESCRIPTION	BY	CHK/APR	

12x40 WHEELED OFFICE
ONTARIO FLEET

DRAWING TITLE:

OVERALL POWER & DATA PLAN LEVEL 1

PROJECT NO: DRAWING NO: REV. #

1127059

EM101

ATCO STRUCTURES

©2025 ATCO STRUCTURES & LOGISTICS LTD.
ALL RIGHTS RESERVED THESE DRAWINGS
CONTAIN CONFIDENTIAL INFORMATION AND ARE
THE PROPERTY OF ATCO STRUCTURES &
LOGISTICS LTD. THEY SHALL BE HELD IN
STRICTEST CONFIDENCE AND CANNOT BE
USED, COPIED, REPRODUCED DISCLOSED,
PUBLISHED, DISTRIBUTED OR OTHERWISE
EXPLOITED, IN ANY FORM OR MANNER, IN
WHOLE OR IN PART, FOR ANY REASON OTHER
THAN THE REASON FOR WHICH THEY WERE
PROVIDED TO YOU BY ATCO STRUCTURES &
LOGISTICS LTD., WITHOUT EXPRESSED
WRITTEN CONSENT OF ATCO STRUCTURES &
LOGISTICS LTD.

24X36 SHEET - DO NOT PRINT TO OTHER SCALE.

D	RAWING LIST - MECHANICAL MANUFACTURING
HEET NUMBER	SHEET NAME
MM001	MECHANICAL DRAWING LIST & GENERAL INFORMATION
MM101	OVERALL HVAC PLAN - LEVEL 1
rand total: 2	
	·

PLUMBING LEGEND								
SYMBOL	DESCRIPTION							
SAN	DRAINAGE PIPING							
V	VENT PIPING							
	COLD WATER PIPING							
	HOT WATER PIPING							

ME	CHANICAL LEGEND						
SYMBOL	DESCRIPTION T-BAR CEILING DIFFUSER, NECK SIZE AS SHOWN.						
	LAY-IN EGGCRATE RETURN AIR GRILLE.						
==	FLEXIBLE DUCT, SIZE TO MATCH DIFFUSER NECK SIZE.						
	DUCT TAKE-OFF C/W BALANCING DAMPER. DUCT SIZE TO MATCH DIFFUSER NECK SIZE.						
	SUPPLY/RETURN AIR GALV. DUCTWORK DUCT WITH EXTERNAL INSULATION / LINING WALL MOUNTED THERMOSTAT						
T							
FD	FIRE DAMPER						
T T	DUCT REDUCERS, SIZES AS SHOWN.						
	FIRE EXTINGUISHER						
DIFFUSER GRILL OR REGISTER TYPE	NECK OR FACE SIZE 81 6"Ø 200 AIR FLOW						
IMPERIA	AL:CFM (IN) METRIC:L/S(MM)						
IECH. EQUIPMENT TA	AG LAV-1						
6 MM11	DETAIL NUMBER DIAMING NUMBER						


ABBREVIATION	DEFINITION
AFF	ABOVE FINISHED FLOOR
AFR	ABOVE FINISHED ROOF
CWSR	CLOTHES WASHER
DCW	DOMESTIC COLD WATER
DHW	DOMESTIC HOT WATER
DHWR	DOMESTIC HOT WATER RECIRCULATION
DW	DISH WASHER
E/A	EXHAUST AIR
FD	FIRE DAMPER
FIM	FREE ISSUED MATERIAL
NFHB	NON-FREEZE HOSE BIBB
PL	REFRIGERANT PIPING LIQUID
PSPI	PLANT SUPPLIED PLANT INSTALLED
PSSI	PLANT SUPPLIED SITE INSTALLED
R/A	RETURN AIR
RS	REFRIGERANT PIPING SUCTION
S/A	SUPPLY AIR
SAN	SANITARY PIPING
SD	SMOKE DAMPER
SSSI	SITE SUPPLIED SITE INSTALLED
T/A	TRANSFER AIR
VENT	VENTING PIPING

BUILDING HEAT LOSS/GAIN:

INTERIOR DESIGN TEMP: 22°C EXTERIOR WINTER TEMP: -21°C EXTERIOR SUMMER TEMP: 34°C

DESIGN HEAT LOSS CALCULATED: 9,200 W HEATING OUTPUT: 12,000 W


FOR CONSTRUCTION						PROJECT: 12x40 WHEELED OFFICE ONTARIO FLEET	MECHANICAL DRAWING LIST & GENERAL INFORMATION		
	0	2025-08-13	ISSUED FOR CONSTRUCTION	JW	CM	CLIENT:	PROJECT NO:	DRAWING NO:	REV.#
	A REV.			JW	CHK/APR	ATCO STRUCTURES	1127059	MM001	0

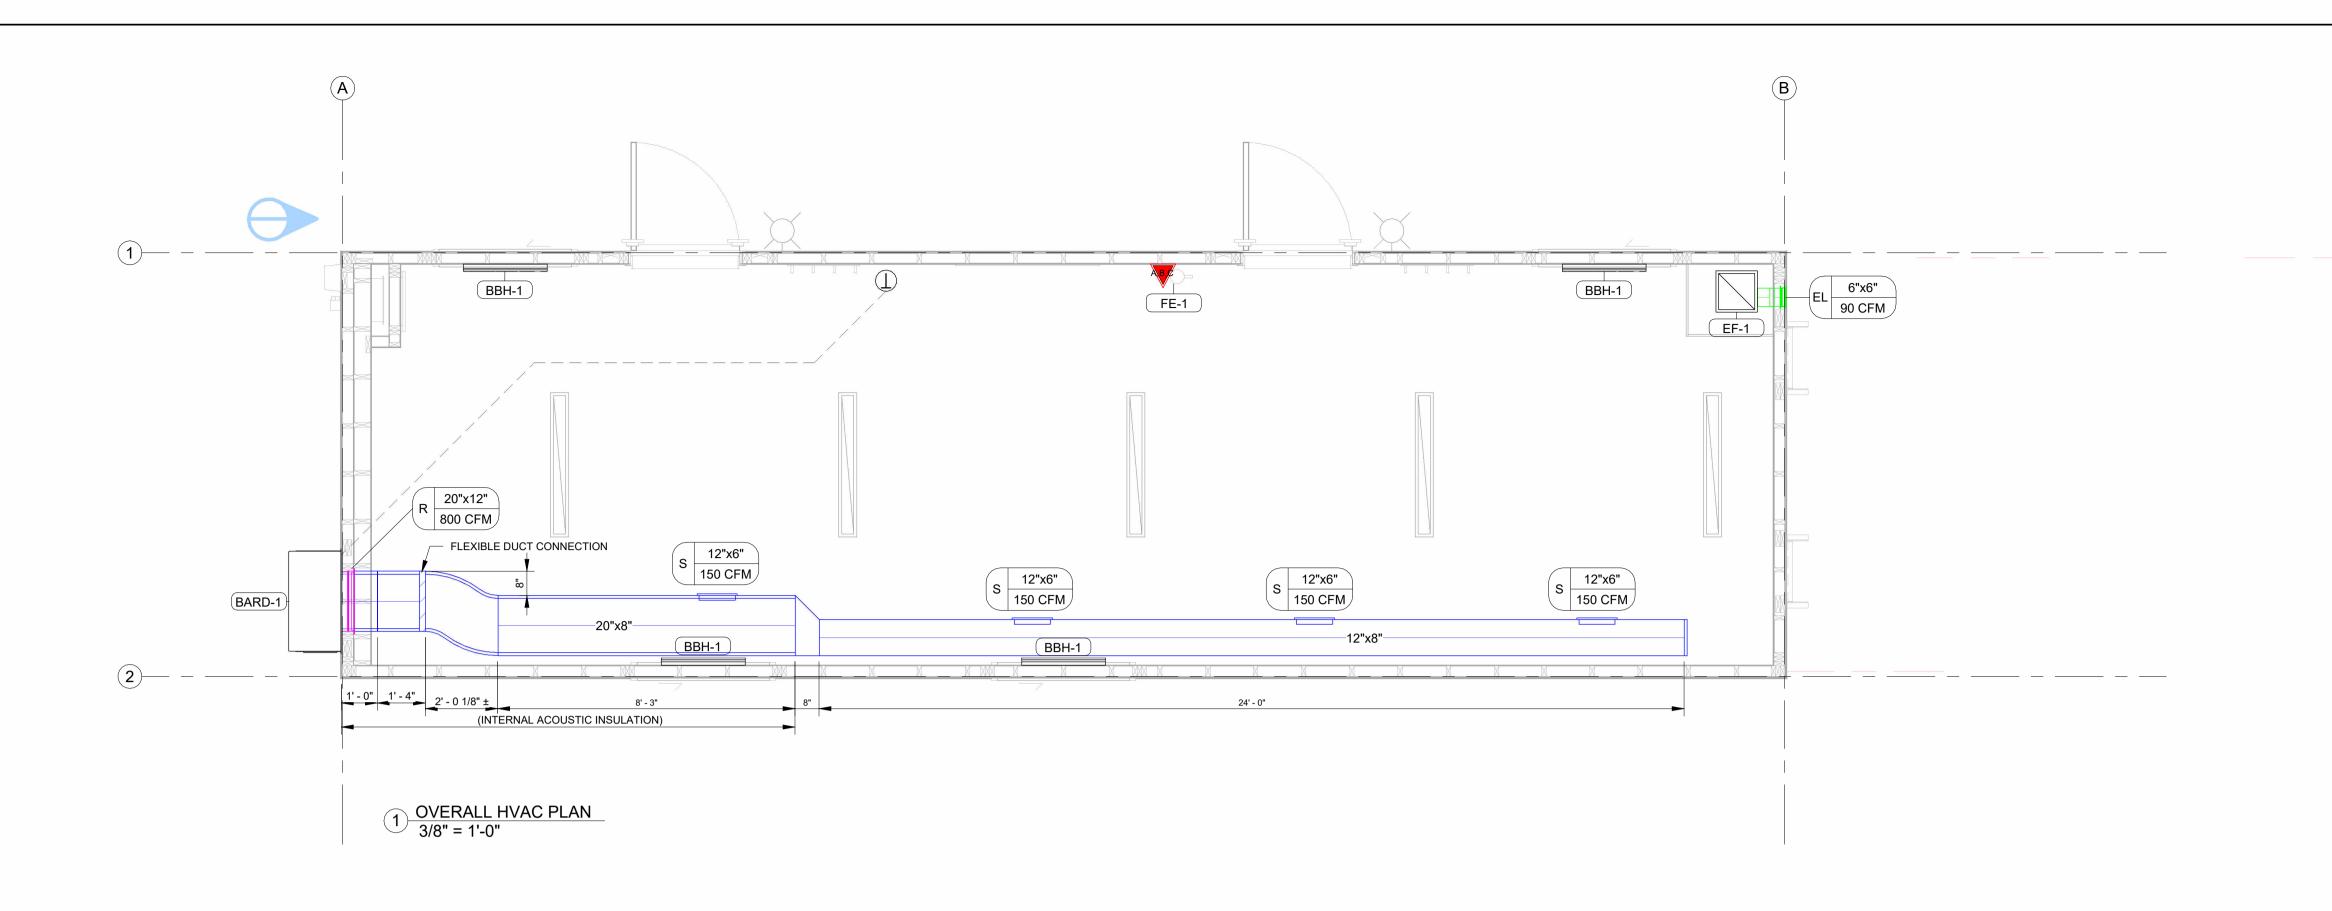

						ВА	RD UNIT SCHED	ULE					
TAC OTY	OTY MANUFACTURER MODEL SOURCE HEATING INPUT/ COOLING SUPPLY AIR						ELECTRICAL				DEMARKS		
TAG QTY	. MANUFACTURER	MODEL	SOURCE	OUTPUT	CAPACIT		VOLTAGE (V)	PHASE	FREQUENCY	(HZ)		REMARKS	
BARD-1 1	Bard	W18AF-A10XP4XXE	ELECTRIC	10 kW	1.5 TON	600	230	1	60	INT	ERLOCK W/ BASEBO	DARD HEATERS TO PREVENT SIMULTANEO	OUS HEATING AND COO
EXHAUST FAN SCHEDULE													
TAG	QTY	DESCRIPTION	MANUFACTURE	MODEL	E.S.P.("W.C)	AIR FLOW (CFM) SC	ONES OPERATION	AMPERAGE (A	ELECTR		FREQUENCY (HZ)	REMARKS	
EF-1	1	EXHAUST FAN	ORTECH	OD-9005PB	0.1	90	0.5 W/ LIGHTIN		120	1	60		
		LIEATIN	ASEBOARD HEAT	ER SCHEDULE									
TAG QTY	MANUFACTURER	MODEL CAPACITY				REMARKS	A.F.FL.						
BBH-1 4	STELPRO	B0501 500	120	1	C/W BUILT	-IN THERMOSTAT	0' - 6"						
TYPE MARI	K SIZE	MANUFACTURER	IR TERMINAL SCH	EDULE COUNT		DESCRIPTION							
iL	6"x6"		70737 OR = 1			/RE C/W BACKDRAFT	DAMPER						
	20"x12"	PRICE 51	0Z 1	RETUR	RN REGISTER								
	12"x6"	DAYUS DA	AHVD 4	DOUB	LE DEFLECTION	ON, OPPOSED BLADE	DAMPER						
TAG E-1	QTY.	FIRE EXTINGUISHI DESCRIPTION 5 LB. ABC (2A:10BC)	ER SCHEDULE REMARK C/W WALL MOUNT E		DMMENTS THERS								

©2025 ATCO STRUCTURES & LOGISTICS LTD.						PROJECT:	DRAWING TITLE:		
ALL RIGHTS RESERVED THESE DRAWINGS CONTAIN CONFIDENTIAL INFORMATION AND ARE THE PROPERTY OF ATCO STRUCTURES & LOGISTICS LTD. THEY SHALL BE HELD IN STRICTEST CONFIDENCE AND CANNOT BE USED, COPIED, REPRODUCED DISCLOSED, PUBLISHED, DISTRIBUTED OR OTHERWISE EXPLOITED, IN ANY FORM OR MANNER, IN WHOLE OR IN PART, FOR ANY REASON OTHER THAN THE REASON FOR WHICH THEY WERE	FOR CONSTRUCTION					12x40 WHEELED OFFICE ONTARIO FLEET	OVERALL	HVAC PLAN - LE\	/EL 1
PROVIDED TO YOU BY ATCO STRUCTURES & LOGISTICS LTD., WITHOUT EXPRESSED						CLIENT:	PROJECT NO:	DRAWING NO:	REV. #
WRITTEN CONSENT OF ATCO STRUCTURES & LOGISTICS LTD.		0	2025-08-13 ISSUED FOR CONST	RUCTION JW	/ CM				
24X36 SHEET - DO NOT PRINT TO OTHER SCALE.		A	2025-08-05 ISSUED FOR 90% RE	EVIEW JW	<i>I</i>	ATCO STRUCTURES	1407050	N 4 N 4 4 O 4	
		REV.	DATE	DESCRIPTION BY	/ CHK/APF	R	1127059	MM101	



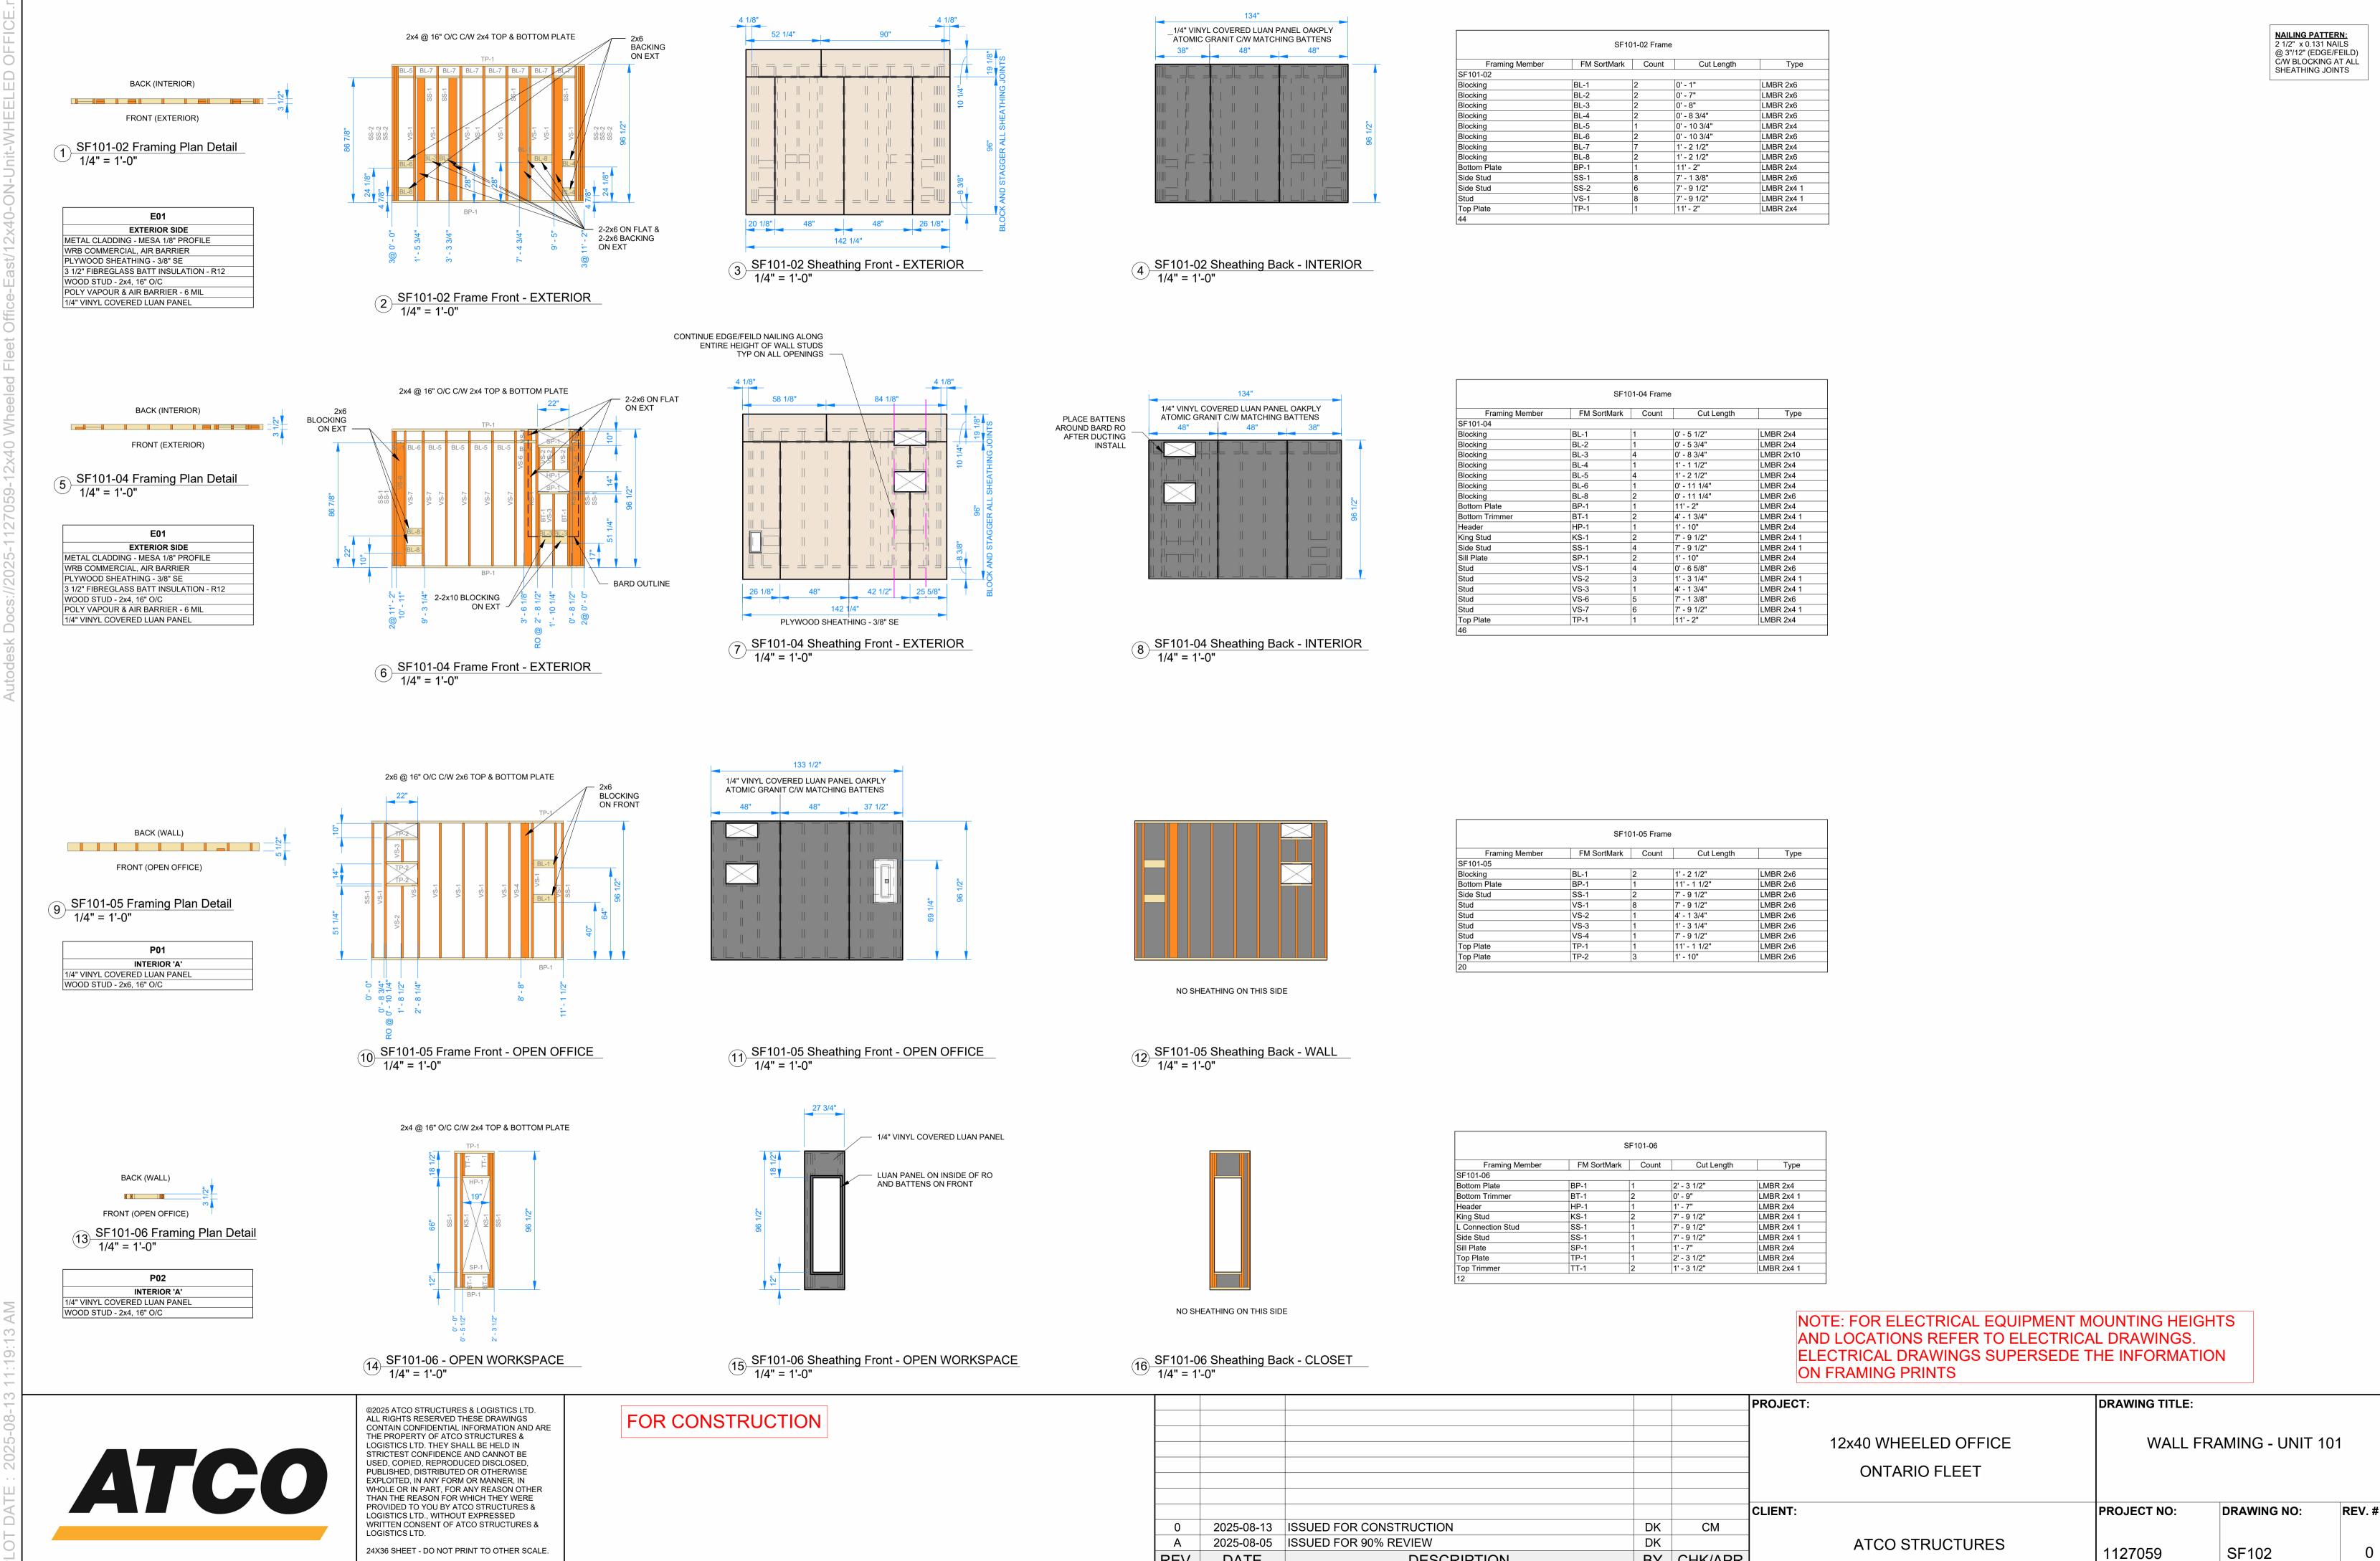

REV.

DATE

DESCRIPTION

BY CHK/APR

1127059

24X36 SHEET - DO NOT PRINT TO OTHER SCALE.