LIST OF DRAWINGS

A001	BUILDING CODE MATRIX, SB 10, EXPOSED BLDG FACE
A100	SITE PLAN
A101	SITE STATISTICS / SITE DETAILS
A102	FIRE SEPARATION PLANS AND SECTION
A200	BASEMENT FLOOR PLAN
A201	GROUND FLOOR PLAN
A202	TYPICAL FLOOR PLAN
A203	ROOF PLAN
A301	EXTERIOR ELEVATION I
A302	EXTERIOR ELEVATION II
A305	ISOMETRIC VIEWS
A306	PERSPECTIVE VIEWS
A307	PERSPECTIVE VIEWS


NIAGARA FALLS LUNDY'S LANE MIXED USE-RESIDENTIAL

8885-8911 Lundy's Lane Niagara Falls, L2H 1H3, Ontario, Canada



LIST OF CONSULTANTS ARCHITECT PODARIU ARCHITECTS EMAIL:

PODARIU ARCHITEGTS

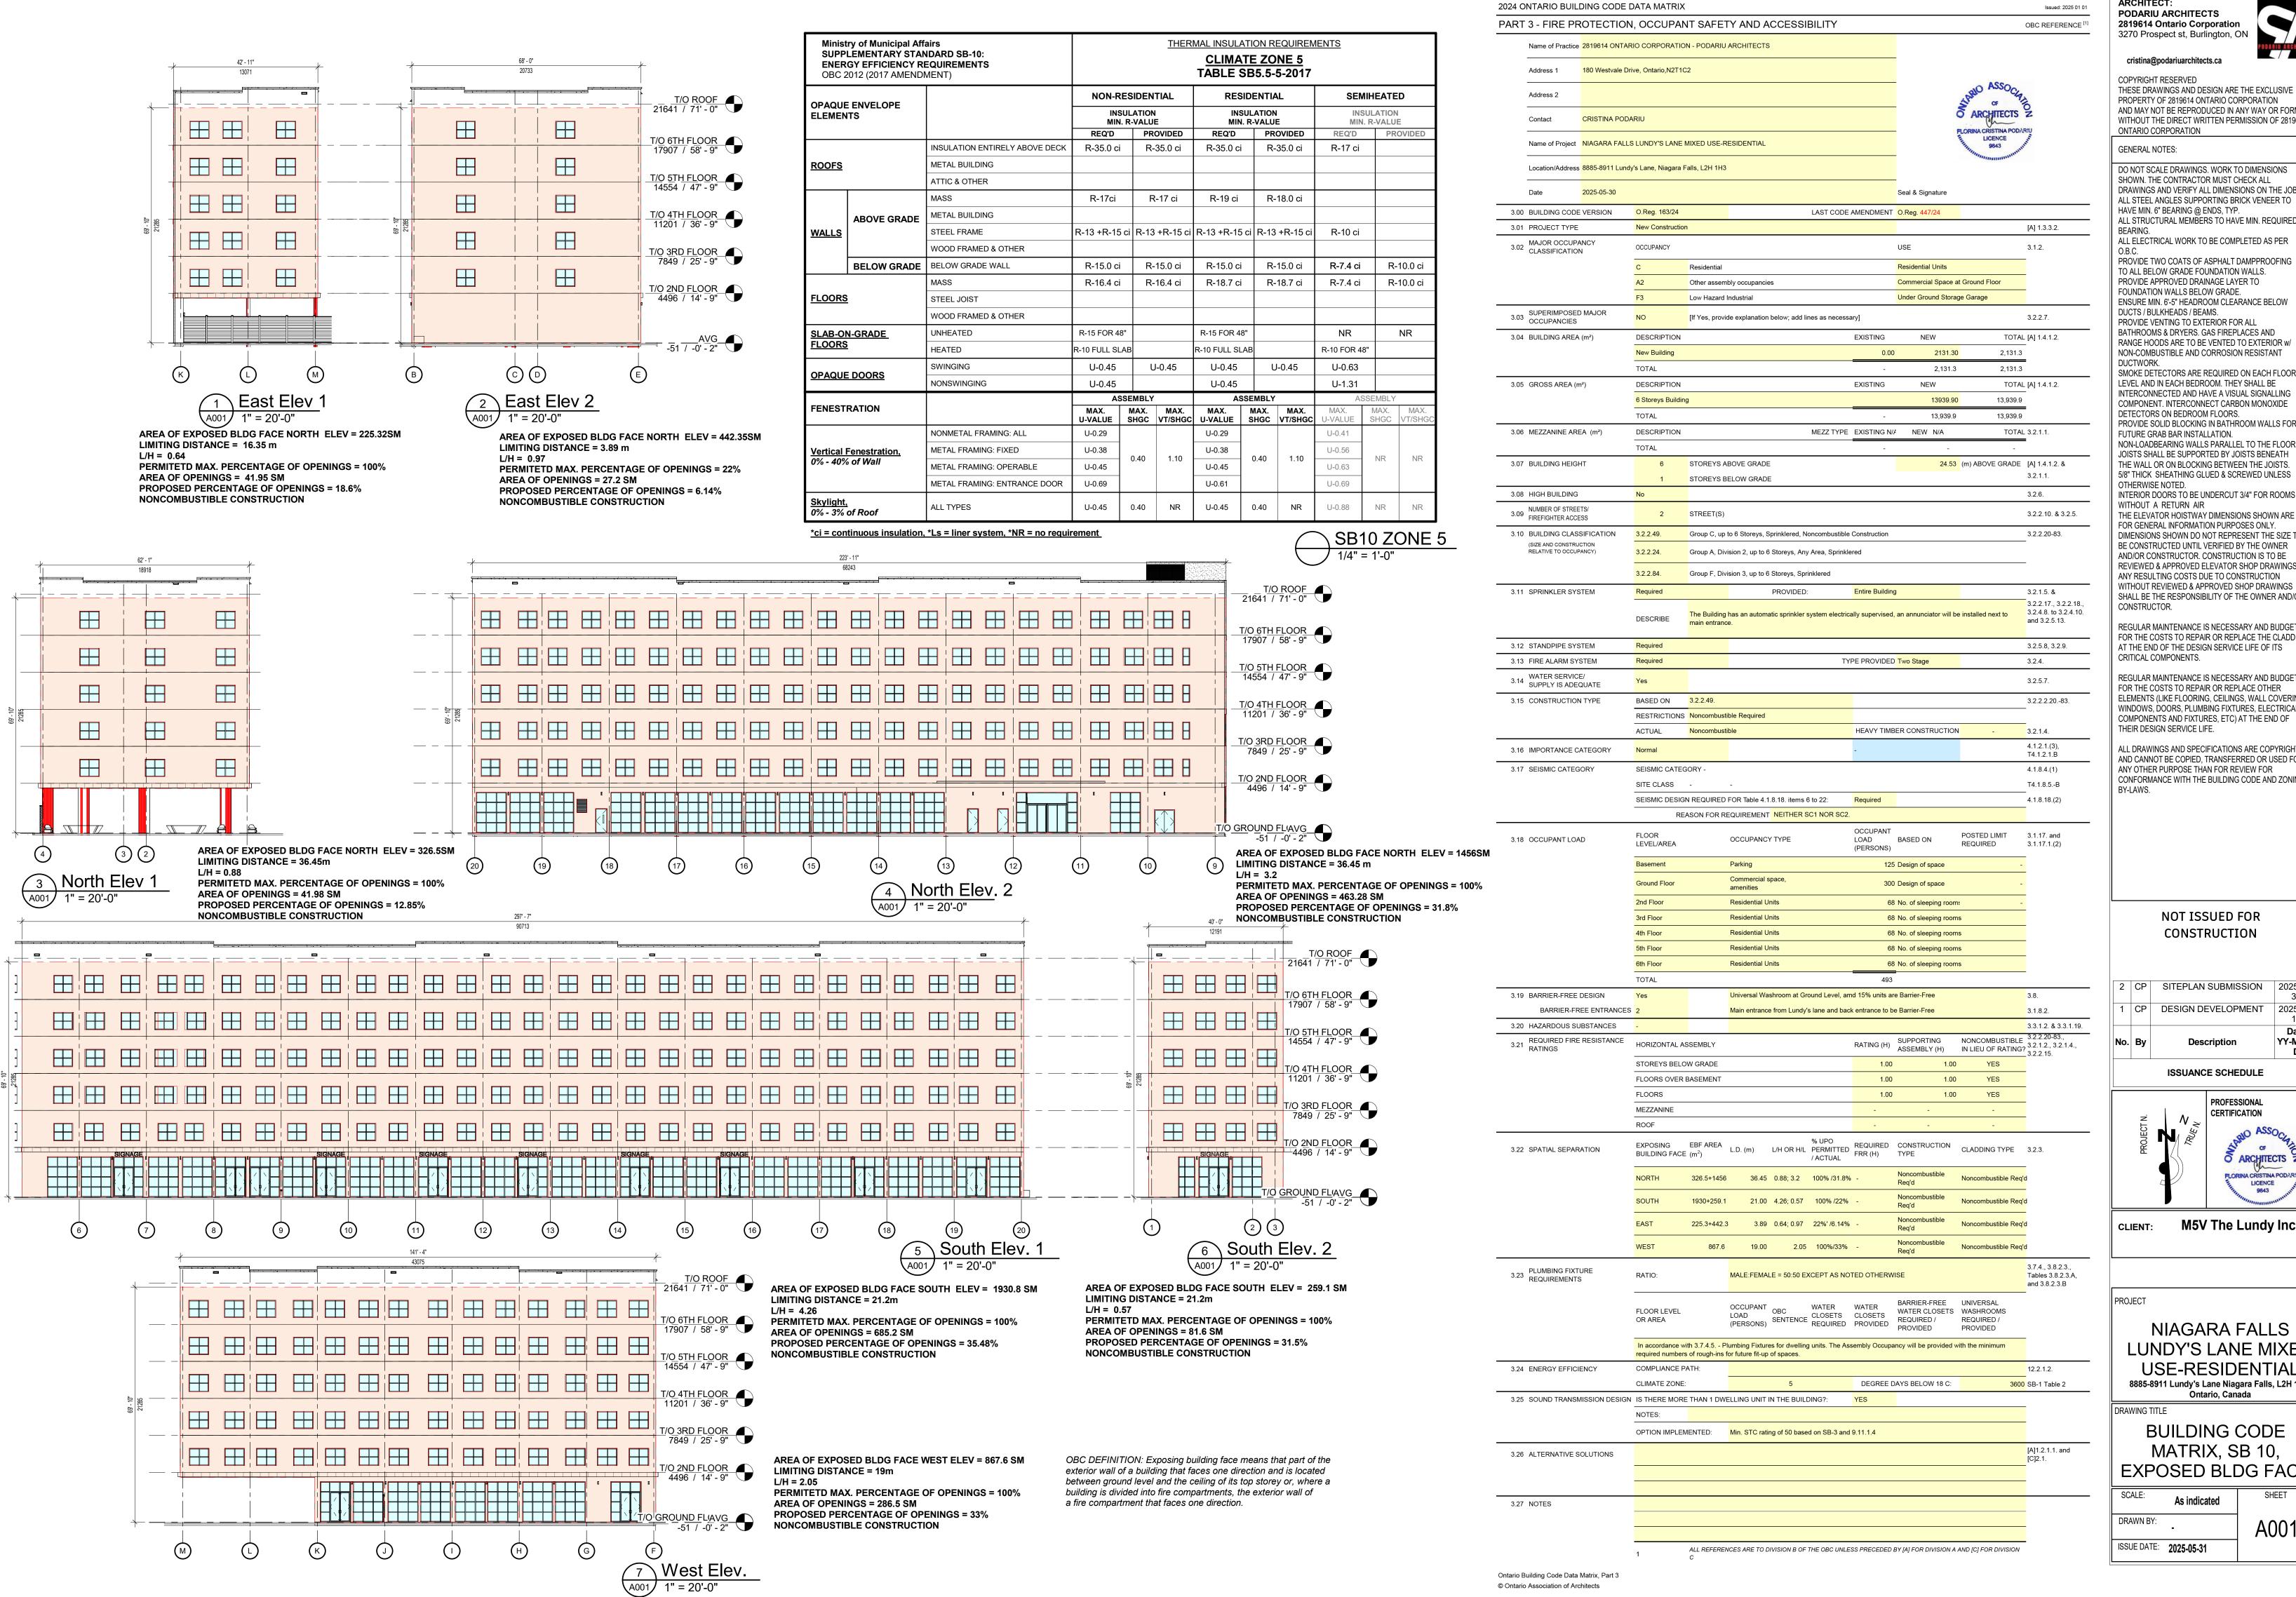

ARCHITECT: PODARIU ARCHITECTS 2819614 Ontario Corporation

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PROVIDE TWO COATS OF ASPHALT DAMPPROOFING TO ALL BELOW GRADE FOUNDATION WALLS. PROVIDE APPROVED DRAINAGE LAYER TO FOUNDATION WALLS BELOW GRADE. ENSURE MIN. 6'-5" HEADROOM CLEARANCE BELOW DUCTS / BULKHEADS / BEAMS. PROVIDE VENTING TO EXTERIOR FOR ALL BATHROOMS & DRYERS. GAS FIREPLACES AND RANGE HOODS ARE TO BE VENTED TO EXTERIOR W. NON-COMBUSTIBLE AND CORROSION RESISTANT

INTERCONNECTED AND HAVE A VISUAL SIGNALLING COMPONENT. INTERCONNECT CARBON MONOXIDE DETECTORS ON BEDROOM FLOORS. PROVIDE SOLID BLOCKING IN BATHROOM WALLS FOR FUTURE GRAB BAR INSTALLATION. NON-LOADBEARING WALLS PARALLEL TO THE FLOOR JOISTS SHALL BE SUPPORTED BY JOISTS BENEATH THE WALL OR ON BLOCKING BETWEEN THE JOISTS. 5/8" THICK SHEATHING GLUED & SCREWED UNLESS NTERIOR DOORS TO BE UNDERCUT 3/4" FOR ROOMS

THE ELEVATOR HOISTWAY DIMENSIONS SHOWN ARE FOR GENERAL INFORMATION PURPOSES ONLY. DIMENSIONS SHOWN DO NOT REPRESENT THE SIZE TO BE CONSTRUCTED UNTIL VERIFIED BY THE OWNER AND/OR CONSTRUCTOR, CONSTRUCTION IS TO BE REVIEWED & APPROVED ELEVATOR SHOP DRAWINGS. ANY RESULTING COSTS DUE TO CONSTRUCTION WITHOUT REVIEWED & APPROVED SHOP DRAWINGS SHALL BE THE RESPONSIBILITY OF THE OWNER AND/OR

REGULAR MAINTENANCE IS NECESSARY AND BUDGET FOR THE COSTS TO REPAIR OR REPLACE THE CLADDING AT THE END OF THE DESIGN SERVICE LIFE OF ITS

REGULAR MAINTENANCE IS NECESSARY AND BUDGET FOR THE COSTS TO REPAIR OR REPLACE OTHER ELEMENTS (LIKE FLOORING, CEILINGS, WALL COVERINGS, WINDOWS, DOORS, PLUMBING FIXTURES, ELECTRICAL COMPONENTS AND FIXTURES, ETC) AT THE END OF THEIR DESIGN SERVICE LIFE.

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NOT ISSUED FOR

•	Ву	Description	Date YY-MM-D D
	СР	DESIGN DEVELOPMENT	2025-05- 16
	СР	SITEPLAN SUBMISSION	2025-05- 31


ISSUANCE SCHEDULE





M5V The Lundy Inc.

NIAGARA FALLS LUNDY'S LANE MIXED USE-RESIDENTIAL 8885-8911 Lundy's Lane Niagara Falls, L2H 1H3,

BUILDING CODE MATRIX, SB 10, **EXPOSED BLDG FACE**

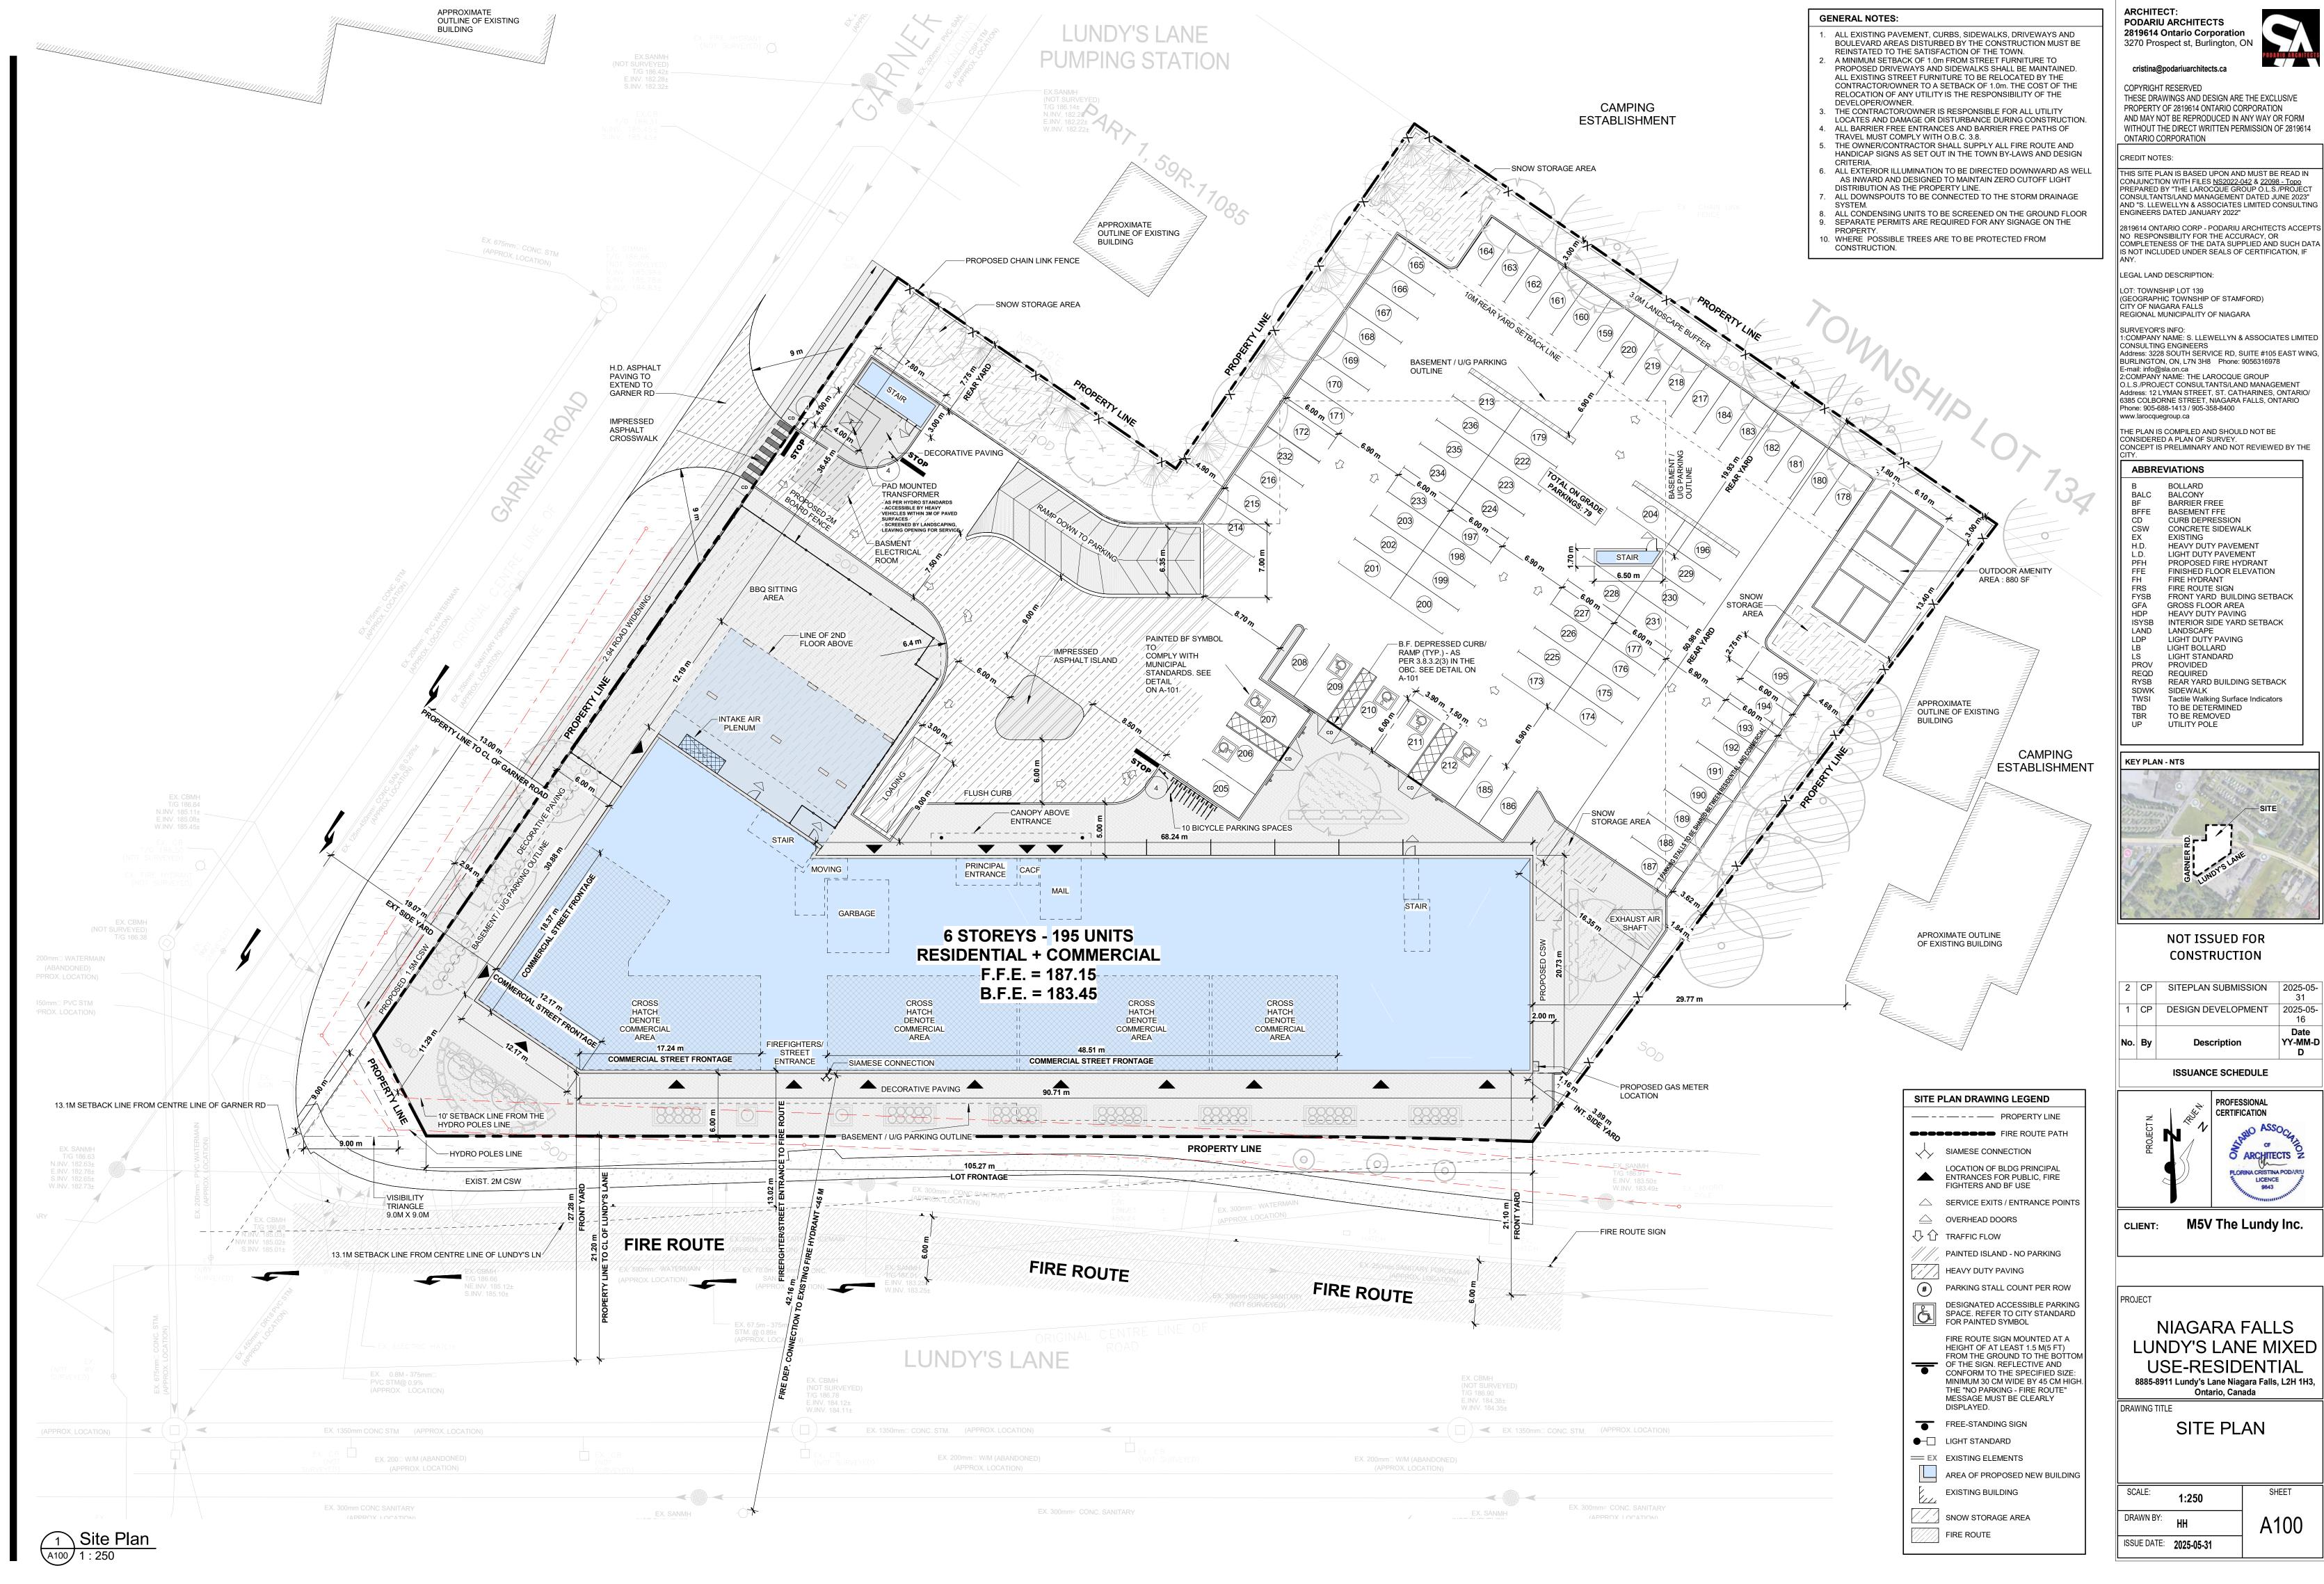

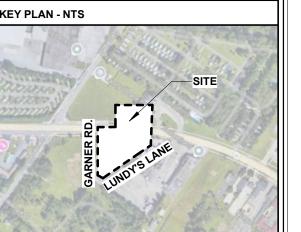

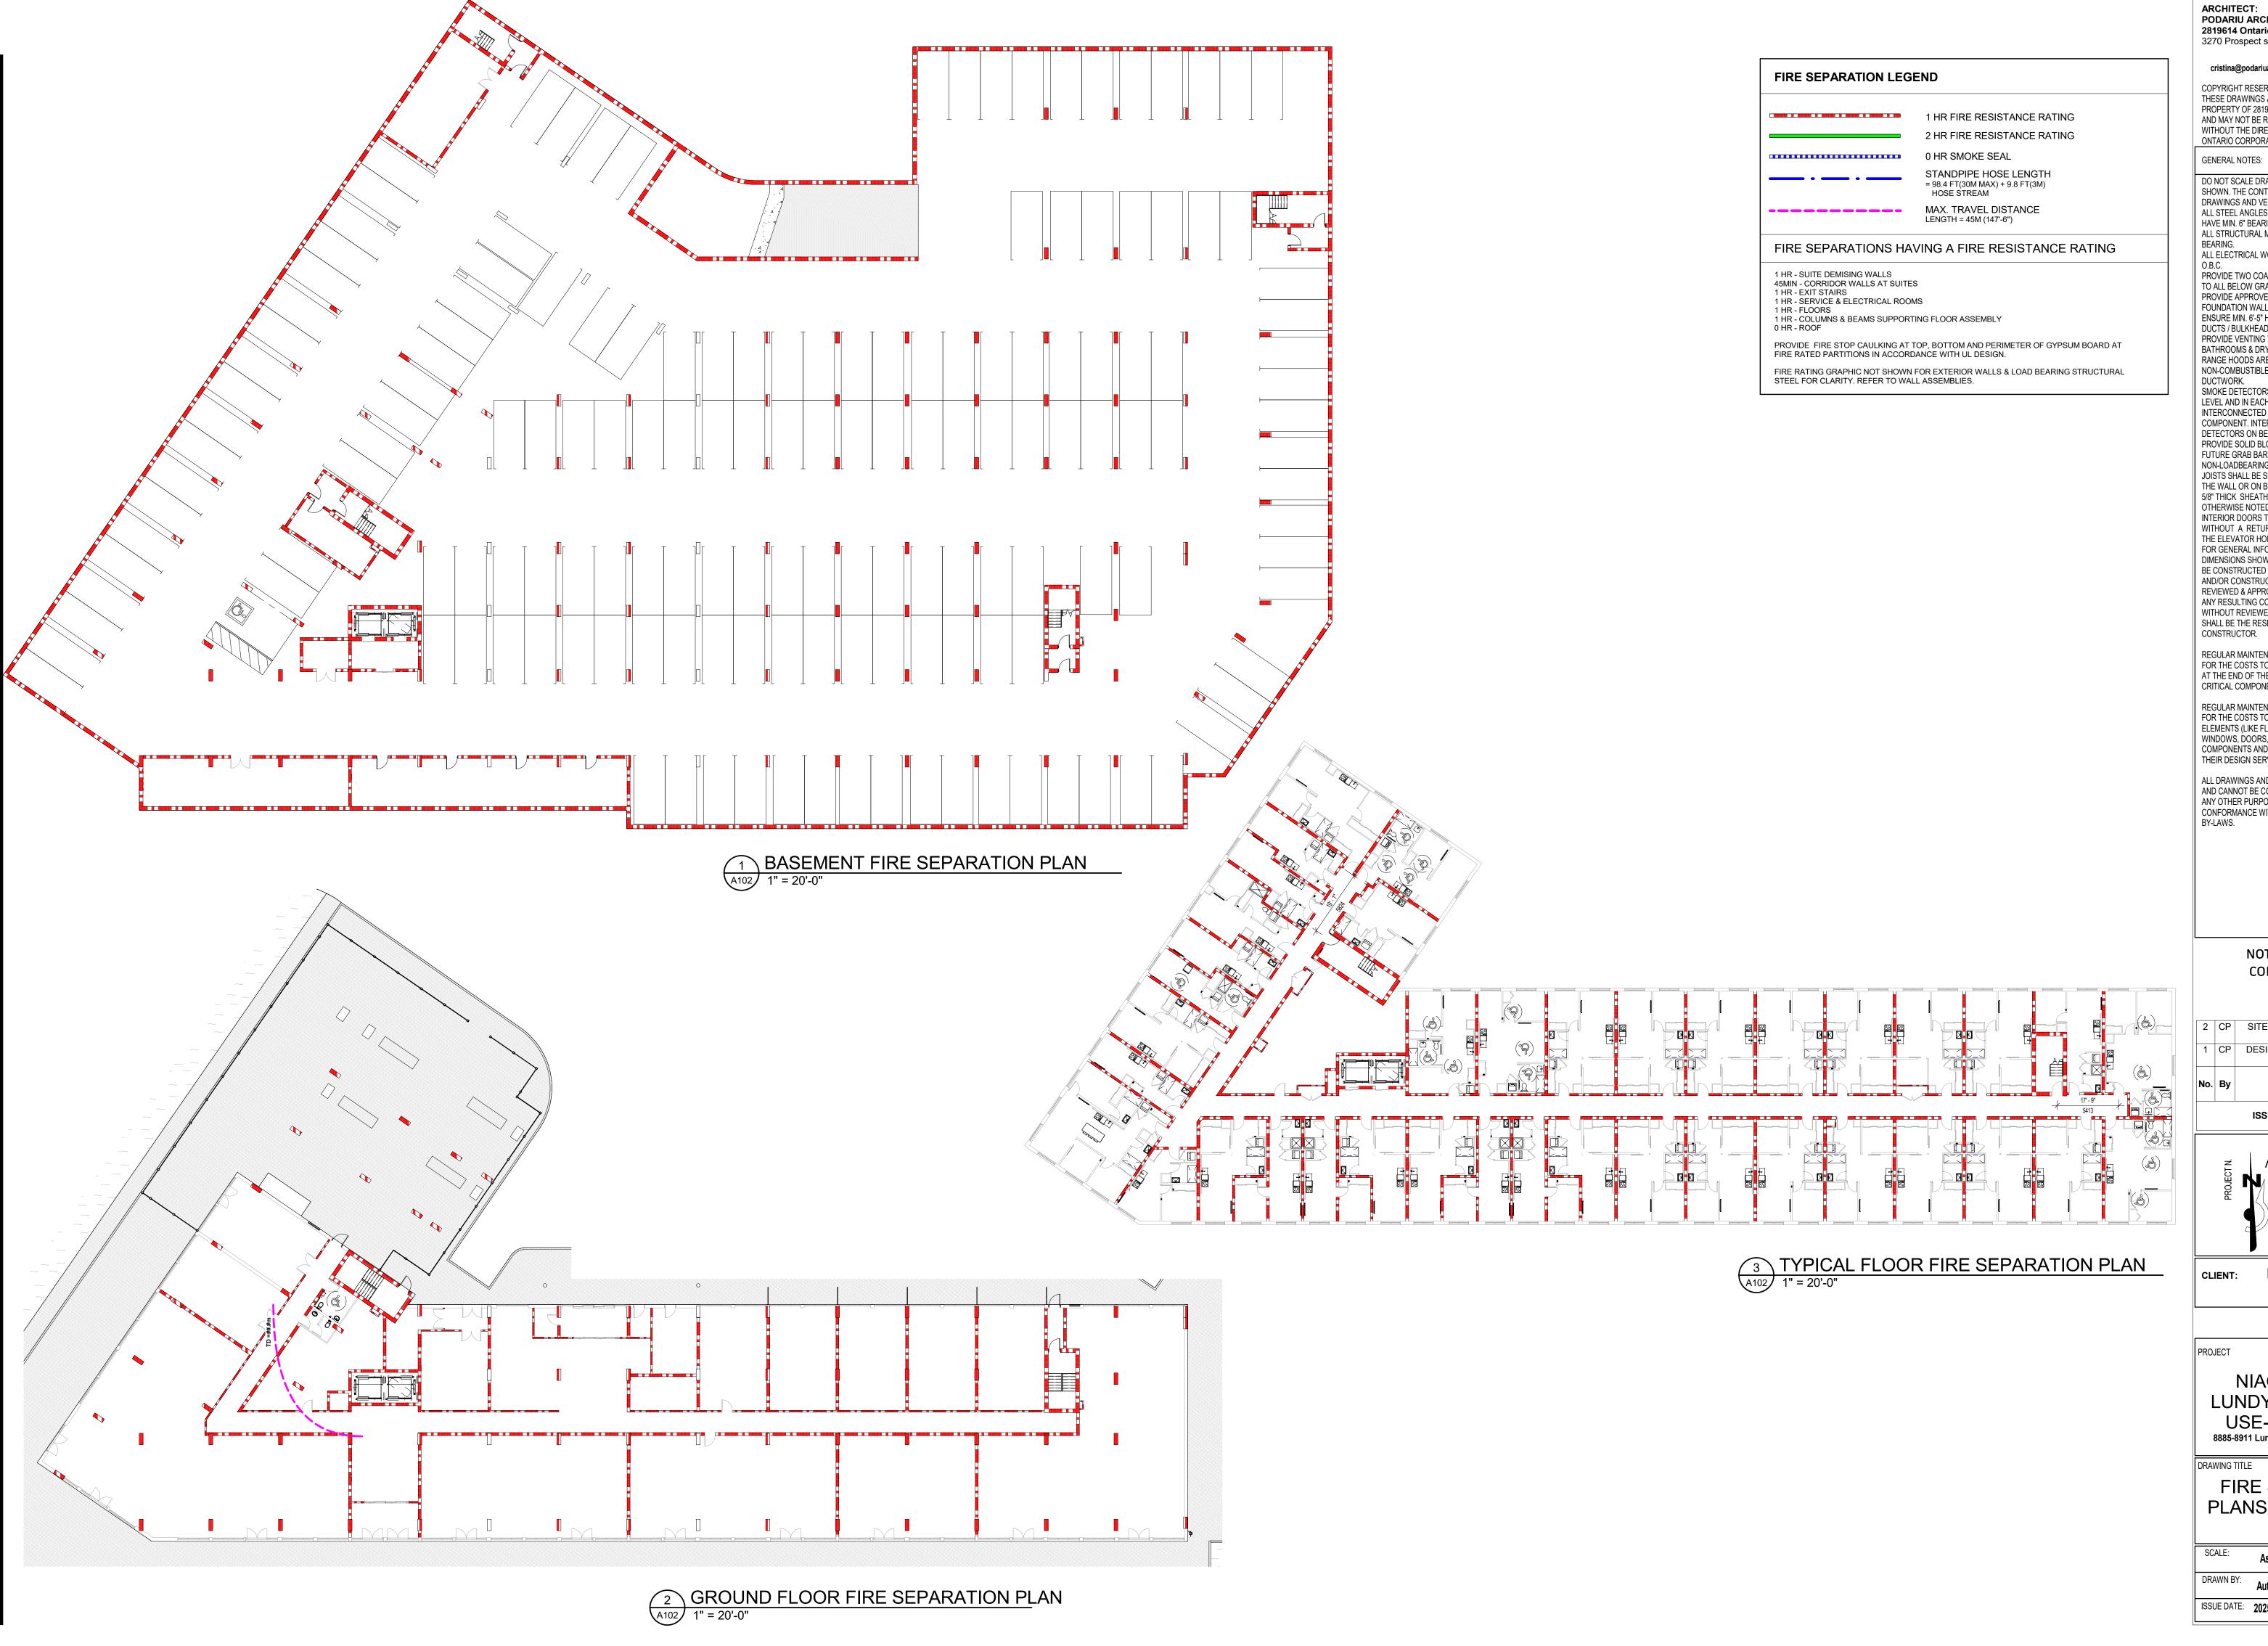

cristina@podariuarchitects.ca

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BATHROOMS & DRYERS. GAS FIREPLACES AND RANGE HOODS ARE TO BE VENTED TO EXTERIOR w/ NON-COMBUSTIBLE AND CORROSION RESISTANT

SMOKE DETECTORS ARE REQUIRED ON EACH FLOOR LEVEL AND IN EACH BEDROOM. THEY SHALL BE INTERCONNECTED AND HAVE A VISUAL SIGNALLING COMPONENT. INTERCONNECT CARBON MONOXIDE DETECTORS ON BEDROOM FLOORS. PROVIDE SOLID BLOCKING IN BATHROOM WALLS FOR

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REGULAR MAINTENANCE IS NECESSARY AND BUDGET FOR THE COSTS TO REPAIR OR REPLACE OTHER ELEMENTS (LIKE FLOORING, CEILINGS, WALL COVERINGS, WINDOWS, DOORS, PLUMBING FIXTURES, ELECTRICAL COMPONENTS AND FIXTURES, ETC) AT THE END OF THEIR DESIGN SERVICE LIFE.

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1 CP DESIGN DEVELOPMENT Date YY-MM-D

ISSUANCE SCHEDULE



M5V The Lundy Inc.

NIAGARA FALLS LUNDY'S LANE MIXED USE-RESIDENTIAL 8885-8911 Lundy's Lane Niagara Falls, L2H 1H3, Ontario, Canada

FIRE SEPARATION PLANS AND SECTION

As indicated

A102 ISSUE DATE: 2025-05-31

GROSS SITE AREA 9,261.8 99,691.3 1256.4 90,604.9 9,694.6 100.8 10			DEVEL			S (LUNDY'S LAI	N □)	%
ROAD WIDENING (234m) 255.4 2.746.9 0.083 NEW GROSS STEARCA 9,0084.0 9,0084.5 1000%	GRO	OSS SITE AF	PFΛ					%
NEW GROSS SITÉ AREA 9,064, 46,544,5 2,226, 109% SCAPED GROSS SITÉ AREA 400,2 2,276,9 0,121, 4,44, 3,17,5 0,099 4,454, 4,544, 4,545, 4,5	Department Light Co.		100 - 201 CAP					
SCAPING AREAS	Sterili V. 1. (1. (1. (1. (1. (1. (1. (1. (1. (1.		Contract Contract Services			The state of the s		100%
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LLANDSCAPE OPEN SPACE			AVING			No. Control of the Co		
ALT AREA	OTAL LANDSCA	APE OPEN S	PACE					9.9%
INDICIDED LOCK CONTROL CONTR	SPHALT AREA				37,550.1	0.862		38.7%
SS AND ARR SHAFTS	•				24,882.7	0.571		25.7%
138.6 1.492.2 0.034 1.5%			coverage)	2,131.3	22,940.7	0.527		
SECONSTRUCTION AREA (GCA)				45.0	484.3	0.011		
SE CONSTRUCTION AREA (GCA)	XPOSED RAMP			138.6	1,492.2	0.034		AXICHER
SCONSTRUCTION AREA WITH U/G 20,282.8 218,322.0 5.012		March 1997 Committee Commi		2,314.9				HEROTO CONTACTOR
TOTAL SALEABLE AREA CALCULATION IL DWELLING AREA 9,975.4 107,373.8 IL COMMERCIAL AREA 807.1 8,687.1 IL SALEABLE AREA 10,724.2 116,060.9 PARKING CALCULATION IL SALEABLE AREA 10,724.2 116,060.9 PARKING CALCULATION AL PARKING REQUIRED AS PER NEW SMUNITS RATIO PER 715 IL SALEABLE AREA 10,724.2 116,060.9 PARKING CALCULATION AL PARKING REQUIRED AS PER NEW SMUNITS RATIO PER 715 IL SALEABLE AREA 10,724.2 116,060.9 PARKING CALCULATION AL PARKING REQUIRED AS PER NEW SMUNITS RATIO PER 715 IL SALEABLE AREA 10,724.2 116,060.9 PARKING CALCULATION 1 28 IL SALEABLE AREA 10,724.2 116,060.9 PARKING CALCULATION 215 IL SALEABLE AREA 10,724.2 116,060.9 IL PARKING PROVIDED 1 275 IL COMBING PROVIDED 1 1 1 1 PARKING SURPLUS 1 1 1 1 ACCESSIBLE PARKING ZONING BY-LAW REQ'D PROV. COMPLY YES 1 IL COMMERCIAL - (1500 SM) - BIKE ROOM 20 8 98 IL COMMERCIAL - (1500 SM) - BIKE ROOM 20 98 98 IL COMMERCIAL - (1500 SM) - BIKE ROOM 20 98 98 IL COMMERCIAL - (1500 SM) - BIKE ROOM 20 98 98 IL COMMERCIAL - (1500 SM) - BIKE ROOM 20 98 98 IL COMMERCIAL - (1500 SM) - BIKE ROOM 20 98 98 IL COMMERCIAL - (1500 SM) - BIKE ROOM 20 98 98 IL COMMERCIAL - (1500 SM) - BIKE ROOM 20 98 98 IL COMMERCIAL - (1500 SM) - BIKE ROOM 20 98 98 IL COMMERCIAL - (1500 SM) - BIKE ROOM 20 98 98 IL COMMERCIAL - (1500 SM) - BIKE ROOM 20 98 98 IL COMMERCIAL - (1500 SM) - BIKE ROOM 20 98 98 IL COMMERCIAL - (1500 SM) - BIKE ROOM 20 98 98 IL COMMERCIAL - (1500 SM) - BIKE ROOM 20 98 98 IL COMMERCIAL - (1500 SM) - BIKE ROOM 20 98 98 IL COMMERCIAL - (1500 SM) - BIKE ROOM 20 98 98 98 IL COMMERCIAL - (1500 SM) - BIKE ROOM 20 98 98 98 IL COMMERCIAL - (1500 SM) - BIKE ROOM 20 98 98 98 IL COMMERCIAL - (1500 SM) - BIKE ROOM 20 98 98 98 IL COMMERCIAL - (1500 SM) - BIKE ROOM 20 98 98 98 IL COMMERCIAL - (1500 SM) - BIKE ROOM 20 98 98 98 IL COMMERCIAL - (1500 SM) - BIKE ROOM 20 98 98 98 IL COMMER	ROSS CONSTR	UCTION ARI	EA (GCA)	13,939.9	150,047.7	3.445	1	154.8%
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L COMPLECT LA REA 9,975.4 107,373.8 LL COMMERCIAL AREA 807.1 8,887.1 LL SALEABLE AREA 10,762.4 116,060.9 PARKING REQUIRED AS PER NEW SMINITS RATIO PER 10,11 AL PARKING REQUIRED AS PER NEW SMINITS RATIO PER 11.1 AL PARKING REQUIRED AS PER NEW SMINITS RATIO PER 1.1 AL PARKING REQUIRED A19.1 BI DIVIC COMPLETE A19.1 BI DIVIC COMPLETE A19.1 PROPOSED PARKING RATES ARKING TOTAL REQUIRED A19.1 RAKING RADE PARKING RATES ARKING TOTAL REQUIRED A19.1 LOADING RECOT PROV. COMPLY TOTAL REQUIRED A19.1 LOADING RECOT PROV. COMPLY PROV. COMPLY REQUIRED (201-1000) = 2+2% 7, 7, 7 FES DILLIONAL (1,650 SM) - BIKE ROOM 2 2 2 YES BICYCLE PARKING COMPLY REGOT PROV. COMPLY PES ILL COMMERCIAL (1,650 SM) - BIKE ROOM 2 2 2 YES BILL COMMERCIAL (1,650 SM) - BIKE ROOM 2 2 2 YES BUILDING HEIGHT GFA SM GFA SF AREA (SM) AMENITY AREA (CCA) LL COMMERCIAL (1,650 SM) - BIKE ROOM 2 2 2 YES BUILDING HEIGHT GFA SM GFA SF AREA (SM) AMENITY AREA (SF) ARE	ARKING AREA				***************************************			
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PARKING CALCULATION								
AL PARKING REQUIRED AS PER NEW \$MUINITS RATIO PER TOTAL	JIAL SALEABL	E AKEA		10,782.4	116,060.9			
Section								
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Insert	esidential - UNIT	202		1				10-01-70-01
TOTAL REQUIRED 4.19.1 236 TOTAL		- III III III.	encials with t	807.1	29.0	1		
PROPOSED PARKING RATES			Court of the Court					
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CADING PROVIDED	/G PARKING	(1) (0)						
Company								10.00
Company								1
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Dut not exceeding 3,700 sq. m) 1 1 1 1 1 1 1 1 1		LOAL			KEQ D	FRUV.		Omi El
REQUIRED (201-1000) = 2+2%	· · · · · · · · · · · · · · · · · · ·	_		er 300 sq. m	1	1		YES
BICYCLE PARKING				_AW	REQ'D	PROV.	С	
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STATISTICS/TOTAL STATISTICS STATIST STATISTICS				and produce the second				
STATISTICS/TOTAL STATISTICS/	ETAIL COMMER			OOM	_			
BUILDING HEIGHT GROSS CONSTRUCTION AREA (GCA)		101	AL		100	100		ILO
BUILDING HEIGHT GROSS CONSTRUCTION AREA (GCA)				STA	TISTICS/T	OTAL		
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P1	OOR LEVELS						SALEABLE AREA - RESEDENTIAL	AREA -
2 3.35 2361.7 25,421.4 107.5 1,157.1 1,995.1 21,474.8 3 3.35 2361.7 25,421.4 107.5 1,157.1 1,995.1 21,474.8 1 4 3.35 2361.7 25,421.4 107.5 1,157.1 1,995.1 21,474.8 1 5 3.35 2361.7 25,421.4 107.5 1,157.1 1,995.1 21,474.8 1 6 3.73 2361.7 25,421.4 107.5 1,157.1 1,995.1 21,474.8 1 6 3.73 2361.7 25,421.4 107.5 1,157.1 1,995.1 21,474.8 1 6 3.73 2361.7 25,421.4 107.5 1,157.1 1,995.1 21,474.8 1 1 1,000.5 1,157.1 1,995.1 21,474.8 1 1 1,000.5 1,157.1 1,995.1 21,474.8 1 1 1,000.5 1,157.1 1,157.1 1,995.1 21,474.8 1 1 1,000.5 1,157.1 1,157.1 1,995.1 21,474.8 1 1 1,000.5 1 1,157.1 1,157.1 1,995.1 21,474.8 1 1 1,000.5 1 1,157.1 1,157.1 1,157.1 1,1995.1 1,1474.8 1 1 1,000.5 1 1,157.1 1,157.1 1,157.1 1,157.1 1,1995.1 1,1474.8 1 1 1,157.1 1,1995.1 1,1474.8 1 1 1,157.1 1,1995.1 1,157.1 1,157.1 1,157.1 1,157.1 1,157.1 1,157.1 1,157.1 1,1995.1 1,1474.8 1 1 1,157.	P1							
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Sample S								
Column C	ALC: NO.							
ARAPET 2.90			 					
24.53			2361.7	25,421.4	107.5	1,157.1	1,995.1	21,474.8
BLDG. HEIGHT	PARAPEI	-	12020.0	150 047 7	1 627 0	17 522 6	9 975 4	107 373 8
TOTAL CONSTRUCTION AREA WITH U/G PARKING AREA PER UNIT (SF) 89.9		BLDG.				11,022.0		101,010.0
TOTAL CONSTRUCTION AREA WITH U/G PARKING AREA PER UNIT (SF) UNIT BREAKDOWN DR LEVELS 1 BDRM 1 BDRM ACC 2 BDRM ACC 3 BDRM ACC 3 BDRM STUDIO ACC //FLOO AC		I HEIGHT	41-0 according 20-11-11-12					
AREA WITH U/G PARKING AREA PER UNIT (SF) UNIT BREAKDOWN DR LEVELS 1 BDRM 1 BDRM ACC 2 BDRM ACC 3 BDRM ACC 5 BDRM ACC 7			20202.0	•				
UNIT BREAKDOWN DR LEVELS 1 BDRM 1 BDRM ACC 2 BDRM 2 BDRM ACC 3 BDRM STUDIO ACC //FLOO				TRUCTION		89.9		
1 BDRM 1 BDRM ACC 2 BDRM 2 BDRM 3 BDRM STUDIO STUDIO ACC IFLOOR			AREA WITH U/	G PARKING	Control of the Contro			
1 1 1 1 1 1 1 39			AREA WITH U/	G PARKING A	UNIT (SF)	OM/NI	•	
12			AREA WITH U/	G PARKING A UNI	UNIT (SF)	ASSET MANAGEMENT		STUDIO TOTAL
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12			AREA WITH U/	G PARKING A UNI	UNIT (SF) T BREAKD 2 BDRM	ASSET MANAGEMENT	STUDIO	
12			AREA WITH U/	G PARKING A UNI	UNIT (SF) T BREAKD 2 BDRM	ASSET MANAGEMENT	STUDIO	
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TAL UNITS 60 20 80 5 5 20 5 195		1 BDRM 12 12	1 BDRM ACC	UNI 2 BDRM 16 16	UNIT (SF) T BREAKD 2 BDRM	ASSET MANAGEMENT		1 39 1 39
AL UNITS 80 85 5 25 195		1 BDRM 12 12 12 12 12	1 BDRM ACC	UNI 2 BDRM 16 16 16	UNIT (SF) T BREAKD 2 BDRM	ASSET MANAGEMENT		ACC /FLOO 1 39 1 39 1 39 1 39
80 85 5 25 30.8% 10.3% 41.0% 2.6% 10.3% 2.6% 41.0% 43.6% 2.6% 12.8%		1 BDRM 12 12 12 12 12	AREA WITH U/ARE 1 BDRM ACC 4 4 4 4 4	UNI 2 BDRM 16 16 16 16 16	T BREAKD 2 BDRM ACC 1 1 1 1	ASSET MANAGEMENT	4 4 4 4 4	ACC /FLOO 1 39 1 39 1 39 1 39 1 39 1 39
41.0% 43.6% 2.6% 12.8%		1 BDRM 12 12 12 12 12 12	AREA WITH U/ARE 1 BDRM ACC 4 4 4 4 4 20	UNI 2 BDRM 16 16 16 16 16 16 16	T BREAKD 2 BDRM ACC 1 1 1 1 5	3 BDRM 1 1 1 1 1 5	4 4 4 4 4 20	ACC /FLOO 1 39 1 39 1 39 1 39 1 39
		1 BDRM 12 12 12 12 12 12 160	AREA WITH U/ARE 1 BDRM ACC 4 4 4 4 4 20 80	UNI 2 BDRM 16 16 16 16 16 16 16	T BREAKD 2 BDRM ACC 1 1 1 1 5 85	3 BDRM 1 1 1 1 1 5 5	4 4 4 4 4 20 25	ACC /FLOO 1 39 1 39 1 39 1 39 1 39 5 195
ACC 30		1 BDRM 12 12 12 12 12 12 30.8%	1 BDRM ACC 4 4 4 4 4 20 80 10.3%	UNI 2 BDRM 16 16 16 16 16 16 41.0%	UNIT (SF) T BREAKD 2 BDRM ACC 1 1 1 1 5 35 2.6%	3 BDRM 1 1 1 1 5 5 2.6%	4 4 4 4 4 20 25 10.3%	ACC /FLOO 1 39 1 39 1 39 1 39 1 39 5 195

2 BDRM

ACC

726.1

3 BDRM

949.1

1 BDRM ACC

621.4

1332.5

1 BDRM

STUDIO

ACC

336.9

STUDIO

331.2

15% ACC

AVERAGE UNIT

SIZE (SF)

ZONING MATRIX - ZONING BY-LAW No.	79-200 and	BY-LAW No. 20	24-30	GF	ROUND F
ZONED: TOURIST COMMERCIAL ZONE (rezoned as per by-		and the second s		N	AME
Permited Uses - TC	REQ'D (SM/M)	PROV.(SM/M)	COMPLY		-FITNESS
Residential + Commercial		42.020.0	YES		
TOTAL FLOOR AREA TOTAL COMMERCIAL AREA		13,939.9 807.1		A	MEN-
% OF TOTAL FLOOR AREA USED FOR DWELLING UNITS	92%	72%	YES	MAIL/F	PARCELS
Table 8.6.2	REQ'D (SM/M)	PROV.(SM/M)			N-PARTY OOM
(a) Min. Lot Frontage (Lundy's Lane)	6		YES		EN-PET
a) will. Lot Frontage (Lundy's Lane)	0	105.27 MAX 27.28 m AT	123	W	/ASH
(b) MIN. FRONT YARD (From the centerline of the original road allowance Lundy's Lane)	13.1	GRADE AND UPPER LEVELS MIN 21.10 m AT GRADE AND UPPER LEVELS MAX 24.48 m for	YES	AMEN AMI	THEATER OOM ITY AREA TBD ENITY - TDOOR
		BASEMENT MIN 16.63 m for BASEMENT		TOTAL	
c.i) MIN. REAR YARD (where any part of the building is used for residential purpose)	10	50.98	YES		R IS
		19.93m EXIT		7	TYPICAL FLOO
c.ii) MIN. REAR YARD (where no part of the building is	3	STAIR BLDG.	YES	Number	Name
used for residential purposes)		7.75m EXIST	120	206-506	1BDRM
()) MIN (NITTEN OF OUR		STAIR BLDG.		212-512 230-530	1BDRM 1BDRM
(d.i) MIN. INTERIOR SIDE YARD (EAST) (Abutting	3	N.A.	N.A.	214-514	1BDRM A
(d.ii) MIN. INTERIOR SIDE YARD (EAST) (Not Abutting Res,In, OS zones)	N/A	3.89m at GRADE and UPPER FLOORS 1.24m for BASEMENT	YES	215-515 218-518 219-519 202-502 228-528 238-538 239-539	1BDRM A 1BDRM A 1BDRM ACC 1BDRM ACC 1BDRM ACC 1BDRM ACC 1BDRM ACC
(e) MIN. EXTERIOR SIDE YARD (WEST) (from the original centerline of Garner Road)	13.1	19.07m at GRADE and ABOVE GRADE 15.44m for BASEMENT	YES	213-513 216-516 217-517 220-520 201-501 209-509	1BDRM B 1BDRM B 1BDRM B 1BDRM TYPE 2BDRM
f) Max. Lot Coverage	70%	25.7%	YES	221-521 222-522	2BDRM 2BDRM
g) Max Buidling Height (as per by-law No. 2024-30)	36.5	24.53	YES	223-523 224-524	2BDRM 2BDRM
k) Max floor area for each retail store	400	343	YES	225-525	2BDRM
i) Max total floor area for all retail stores per property	3530	807	YES	226-526 227-527	2BDRM 2BDRM
PARKING STANDARDS		y 50 X 50 5 6 6 7	19.27 5.3 (Jun. 4)	231-531	2BDRM
PARKING STALL (4.19)	2.	75 x 6.0		232-532	2BDRM
ACC.PARKING - DBL LOADED	3	.9 x 6.0		233-533 234-534	2BDRM 2BDRM
BICYCLE PARKING		0 / 1.2X0.6 FOR CAL PARKING		235-535 236-536	2BDRM 2BDRM
LOADING STALL DIMENSION	3.0 >	c 9.0 X 4.0		237-537	2BDRM
MANOUVERING WITHOUT PARKING		6		229-529 203-503	2BDRM ACC 2BDRM TYPE
MANOUVERING DRIVE AISLE (4.19) WITHIN PARKING (ON SURFACE)		6.9		211-511 204-504 205-505	3BDRM STUDIO STUDIO
MANOUVERING DRIVE AISLE (4.19) - WITHIN PARKING (BUILDING)		6.3			STUDIO STUDIO STUDIO ACC
Under By-law 79-200, Gross Floor Area is defined as:	rior walls virt	ual walls or hetweer	the outside of	Grand tota	al: 39

								_
Jnder By-law	79-200,	Gross	Floor	Area	is	defined	as:	

al floor area, measured between the outside of exterior walls, virtual walls or between the outside of walls or virtual walls and the centre line of party walls dividing the building from another building, of

	GROUND FLOOR LIVE/V	VORK AREA	4	GR	OUND FLOOR C	OMMERCIA	L AREA	TYPI	CAL FLOOR PL	AN EFFICIENC	CY
Number	Name	Area	Area sm	Number	Name	Area	Area sm		A (63)	A (2)	Floor
1	LIVE/WORK AREA TBD	617.6 SF	57.38 m²	1	COMMERCIAL	3694.4 SF	343.22 m ²	Name	Area (ft²)	Area (m²)	Efficiency
2	LIVE/WORK AREA TBD	617.2 SF	57.34 m²	2	COMMERCIAL	1872.2 SF	173.94 m²	Common area	2778 ft²	258.1 m ²	11%
3	LIVE/WORK AREA TBD	616.6 SF	57.28 m ²	3	COMMERCIAL	1872.2 SF	173.94 m²	Saleble area	22641 ft²	2103.4 m²	89%
4	LIVE/WORK AREA TBD	616.6 SF	57.28 m ²	4	COMMERCIAL	1248.2 SF	115.96 m²		'		
5	LIVE/WORK AREA TBD	630.5 SF	58.57 m ²	Grand to	otal: 4	8687.0 SF	807.05 m ²				
Grand tot	al: 5	3098.4 SF	287.85 m²								

			ST	ATISTI	CS RE	SIDEN	TIAL					
FLOOR LEVELS	GFA (T RESIDE		MECHA	ANICAL	ELEC1	TRICAL	ST	AIR	ELEV	ATOR	COR	RIDOR
	GFA SM	GFA SF	SM	SF	SM	SF	SM	SF	SM	SF	SM	SF
2	1995.1	21474.8	2.2	23.9	3.5	37.8	27.1	291.33	15.6	167.7	205.2	2208.6
3	1995.1	21474.8	2.2	23.9	3.5	37.8	27.1	291.33	15.6	167.7	205.2	2208.6
4	1995.1	21474.8	2.2	23.9	3.5	37.8	27.1	291.33	15.6	167.7	205.2	2208.6
5	1995.1	21474.8	2.2	23.9	3.5	37.8	27.1	291.33	15.6	167.7	205.2	2208.6
6	1995.1	21474.8	2.2	23.9	3.5	37.8	27.1	291.33	15.6	167.7	205.2	2208.6
TOTAL	9975.4	107373.8	11.1	119.5	17.6	189.0	135.3	1456.7	77.9	838.6	1025.9	11043.0

					(STATIS	TICS	СОММ	ERCIA							
LEVELS C		GFA (TOTAL COMMERCIAL)		MECHANICAL GARBAG		BAGE	ST	AIR	ELEVATOR		COR	RIDOR	AD	MIN	MOV	/ING
	GFA SM	GFA SF	SM	SF	SM	SF	SM	SF	SM	SF	SM	SF	SM	SF	SM	SF
1	807.1	8687.0	8.7	94.2	44.5	478.9	27.1	291.3	15.6	167.7	300.3	3232.2	20.8	223.7	21.7	233.9
						0							,			
TOTAL	807.1	8687.0	8.7	94.2	44.5	478.9	27.1	291.3	15.6	167.7	300.3	3232.2	20.8	223.7	21.7	233.9

							STA	TISTICS	S PARI	KING								
FLOOR LEVELS	GFA (T	OTAL)	MECHA	ANICAL	ELEC1	RICAL	ST	AIR	ELEV	ATOR	DRIV	EWAY	BIKE S	TORAGE	PAR	KING	SECU RO	
	GFA SM	GFA SF	SM	SF	SM	SF	SM	SF	SM	SF	SM	SF	SM	SF	SM	SF	SM	SF
P1	6342.9	68274.3	137.0	1474.2	67.1	721.8	55.9	602.1	15.6	167.7	2326.9	25046.3	117.5	1264.3	2613.9	28135.8	13.1	140.9
								-										
TOTAL	6342.9	68274.3	137.0	1474.2	67.1	721.8	55.9	602.1	15.6	167.7	2326.9	25046.3	117.5	1264.3	2613.9	28135.8	13.1	140.9

ROUND FLOOR AMENITIES TYPICAL FLOOR AMENITIES AREA SM AREA SF LEVELS NAME AREA SM AREA SF 2nd FLOOR - WORK SPACE 107.5 1157.1 3119.4 3RD&4TH FLOOR-LOCKERS 107.5 1157.1 272.9 3RD&4TH FLOOR-LOCKERS 107.5 1157.1 679.7 107.5 1157.1 5TH FLOOR-YOGA AREA 70.6 **AMENITY AREA TBD** 107.5 661.0 772.7

289.8

25.4

6.6

572.3

6160.7


TOTAL	: 7	1090.4	117
-	TYPICAL FLOOR	SUITES AF	REA
Number	Name	Area	Area (sm)
206-506	1BDRM	496.7 SF	46.14 m ²
212-512	1BDRM	424.0 SF	39.39 m²
230-530	1BDRM	471.8 SF	43.84 m²
214-514	1BDRM A	447.4 SF	41.57 m²
215-515	1BDRM A	447.4 SF	
218-518	1BDRM A	445.9 SF	
219-519	1BDRM A	447.4 SF	41.57 m²
202-502	1BDRM ACC	605.4 SF	56.24 m²
228-528	1BDRM ACC	636.3 SF	59.12 m²
238-538	1BDRM ACC	619.6 SF	57.56 m²
239-539	1BDRM ACC	624.3 SF	57.99 m²
213-513	1BDRM B	487.3 SF	45.27 m²
216-516	1BDRM B	484.6 SF	
217-517	1BDRM B	486.1 SF	45.16 m²
220-520	1BDRM B	484.6 SF	45.02 m²
201-501	1BDRM TYPE F	499.3 SF	46.39 m²
209-509	2BDRM	622.4 SF	57.82 m²
221-521	2BDRM	621.4 SF	57.73 m²
222-522	2BDRM	621.4 SF	57.73 m ²
223-523	2BDRM	621.4 SF	57.73 m ²
224-524	2BDRM	621.4 SF	57.73 m ²
225-525	2BDRM	621.4 SF	57.73 m²
226-526	2BDRM	621.4 SF	57.73 m ²
227-527	2BDRM	621.4 SF	57.73 m²
231-531	2BDRM	629.1 SF	58.45 m²
232-532	2BDRM	619.6 SF	57.56 m ²
233-533	2BDRM	619.6 SF	57.56 m ²
234-534	2BDRM	619.6 SF	57.56 m ²
235-535	2BDRM	619.6 SF	57.56 m ²
236-536	2BDRM	619.6 SF	57.56 m ²
237-537	2BDRM	619.6 SF	57.56 m ²
229-529	2BDRM ACC	726.1 SF	67.46 m ²
203-503	2BDRM TYPE B	711.2 SF	66.07 m ²
211-511	3BDRM	949.1 SF	88.18 m²
204-504	STUDIO	333.6 SF	30.99 m²
205-505	STUDIO	332.0 SF	30.85 m²
207-507	STUDIO	347.6 SF	32.29 m²
210-510	STUDIO	311.4 SF	28.93 m²
208-508	STUDIO ACC	336.9 SF	31.30 m ²
Grand tot	al: 39	21474.7 SF	1995.07 m²

TOTAL: 5 537.5 5785.5


> BLACK LETTER "P" & റ്റ BORDER 1.5cm RED REFLECTIVE INTERDICTOR STROKE 2cm RED REFLECTIVE ம் ► ANNULAR BAND ──WHITE REFLECTIVE SYMBOL AND BORDER BLUE REFLECTIVE BACKGROUND AND ம் COUTLINE BY PERMIT BLACK LETTER

BARRIER FREE PARKING SIGNAGE REQUIREMENTS

Designated parking space or spaces shall be identified by a minimum of one authorized sign for each designated parking space, as prescribed in R.R.O. 1990, Regulation 581 under the Highway Traffic Act as amended from time to time. (b) A sign shall have the dimensions as described and illustrated in the figure above.

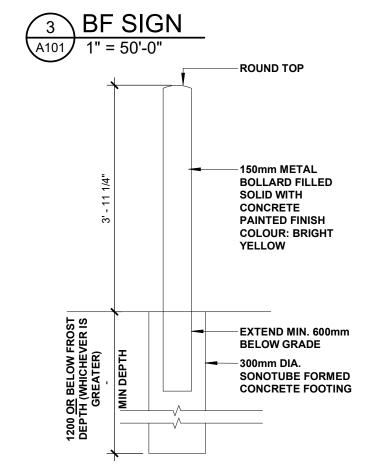

2 BOLLARD DETAIL

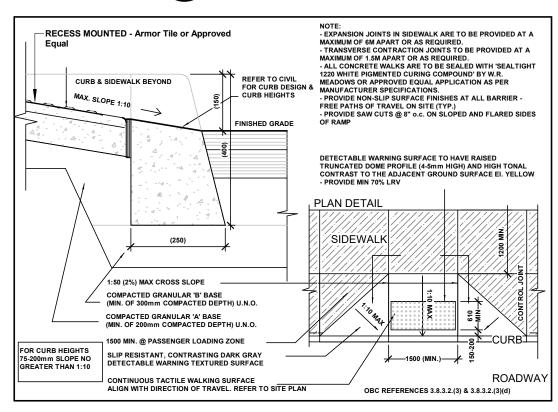

1 BF CURB DEPRESSION DETAIL

GENERAL NOTES: DO NOT SCALE DRAWINGS. WORK TO DIMENSIONS SHOWN. THE CONTRACTOR MUST CHECK ALL DRAWINGS AND VERIFY ALL DIMENSIONS ON THE JOB. ALL STEEL ANGLES SUPPORTING BRICK VENEER TO HAVE MIN. 6" BEARING @ ENDS, TYP. ALL STRUCTURAL MEMBERS TO HAVE MIN. REQUIRED ALL ELECTRICAL WORK TO BE COMPLETED AS PER

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ARCHITECT:

PODARIU ARCHITECTS

2819614 Ontario Corporation 3270 Prospect st, Burlington, ON

cristina@podariuarchitects.ca

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ONTARIO CORPORATION

O.B.C. PROVIDE TWO COATS OF ASPHALT DAMPPROOFING TO ALL BELOW GRADE FOUNDATION WALLS. PROVIDE APPROVED DRAINAGE LAYER TO FOUNDATION WALLS BELOW GRADE. ENSURE MIN. 6'-5" HEADROOM CLEARANCE BELOW DUCTS / BULKHEADS / BEAMS. PROVIDE VENTING TO EXTERIOR FOR ALL BATHROOMS & DRYERS. GAS FIREPLACES AND RANGE HOODS ARE TO BE VENTED TO EXTERIOR w/

NON-COMBUSTIBLE AND CORROSION RESISTANT

DUCTWORK. SMOKE DETECTORS ARE REQUIRED ON EACH FLOOR LEVEL AND IN EACH BEDROOM. THEY SHALL BE INTERCONNECTED AND HAVE A VISUAL SIGNALLING COMPONENT. INTERCONNECT CARBON MONOXIDE DETECTORS ON BEDROOM FLOORS. PROVIDE SOLID BLOCKING IN BATHROOM WALLS FOR FUTURE GRAB BAR INSTALLATION. NON-LOADBEARING WALLS PARALLEL TO THE FLOOR JOISTS SHALL BE SUPPORTED BY JOISTS BENEATH

THE WALL OR ON BLOCKING BETWEEN THE JOISTS. 5/8" THICK SHEATHING GLUED & SCREWED UNLESS OTHERWISE NOTED. INTERIOR DOORS TO BE UNDERCUT 3/4" FOR ROOMS WITHOUT A RETURN AIR THE ELEVATOR HOISTWAY DIMENSIONS SHOWN ARE

FOR GENERAL INFORMATION PURPOSES ONLY. DIMENSIONS SHOWN DO NOT REPRESENT THE SIZE TO BE CONSTRUCTED UNTIL VERIFIED BY THE OWNER AND/OR CONSTRUCTOR. CONSTRUCTION IS TO BE REVIEWED & APPROVED ELEVATOR SHOP DRAWINGS. ANY RESULTING COSTS DUE TO CONSTRUCTION WITHOUT REVIEWED & APPROVED SHOP DRAWINGS SHALL BE THE RESPONSIBILITY OF THE OWNER AND/OR CONSTRUCTOR.

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> **NOT ISSUED FOR** CONSTRUCTION

2 CP SITEPLAN SUBMISSION 31 1 CP DESIGN DEVELOPMENT 16 Date YY-MM-D Description D **ISSUANCE SCHEDULE**

PROFESSIONAL CERTIFICATION

FLORINA CRISTINA PODARIU LICENCE 9843

M5V The Lundy Inc.

PROJECT


NIAGARA FALLS LUNDY'S LANE MIXED **USE-RESIDENTIAL** 8885-8911 Lundy's Lane Niagara Falls, L2H 1H3, Ontario, Canada

DRAWING TITLE

SITE STATISTICS / SITE **DETAILS**

SHEET SCALE: As indicated DRAWN BY: ISSUE DATE: 2025-05-31

A101

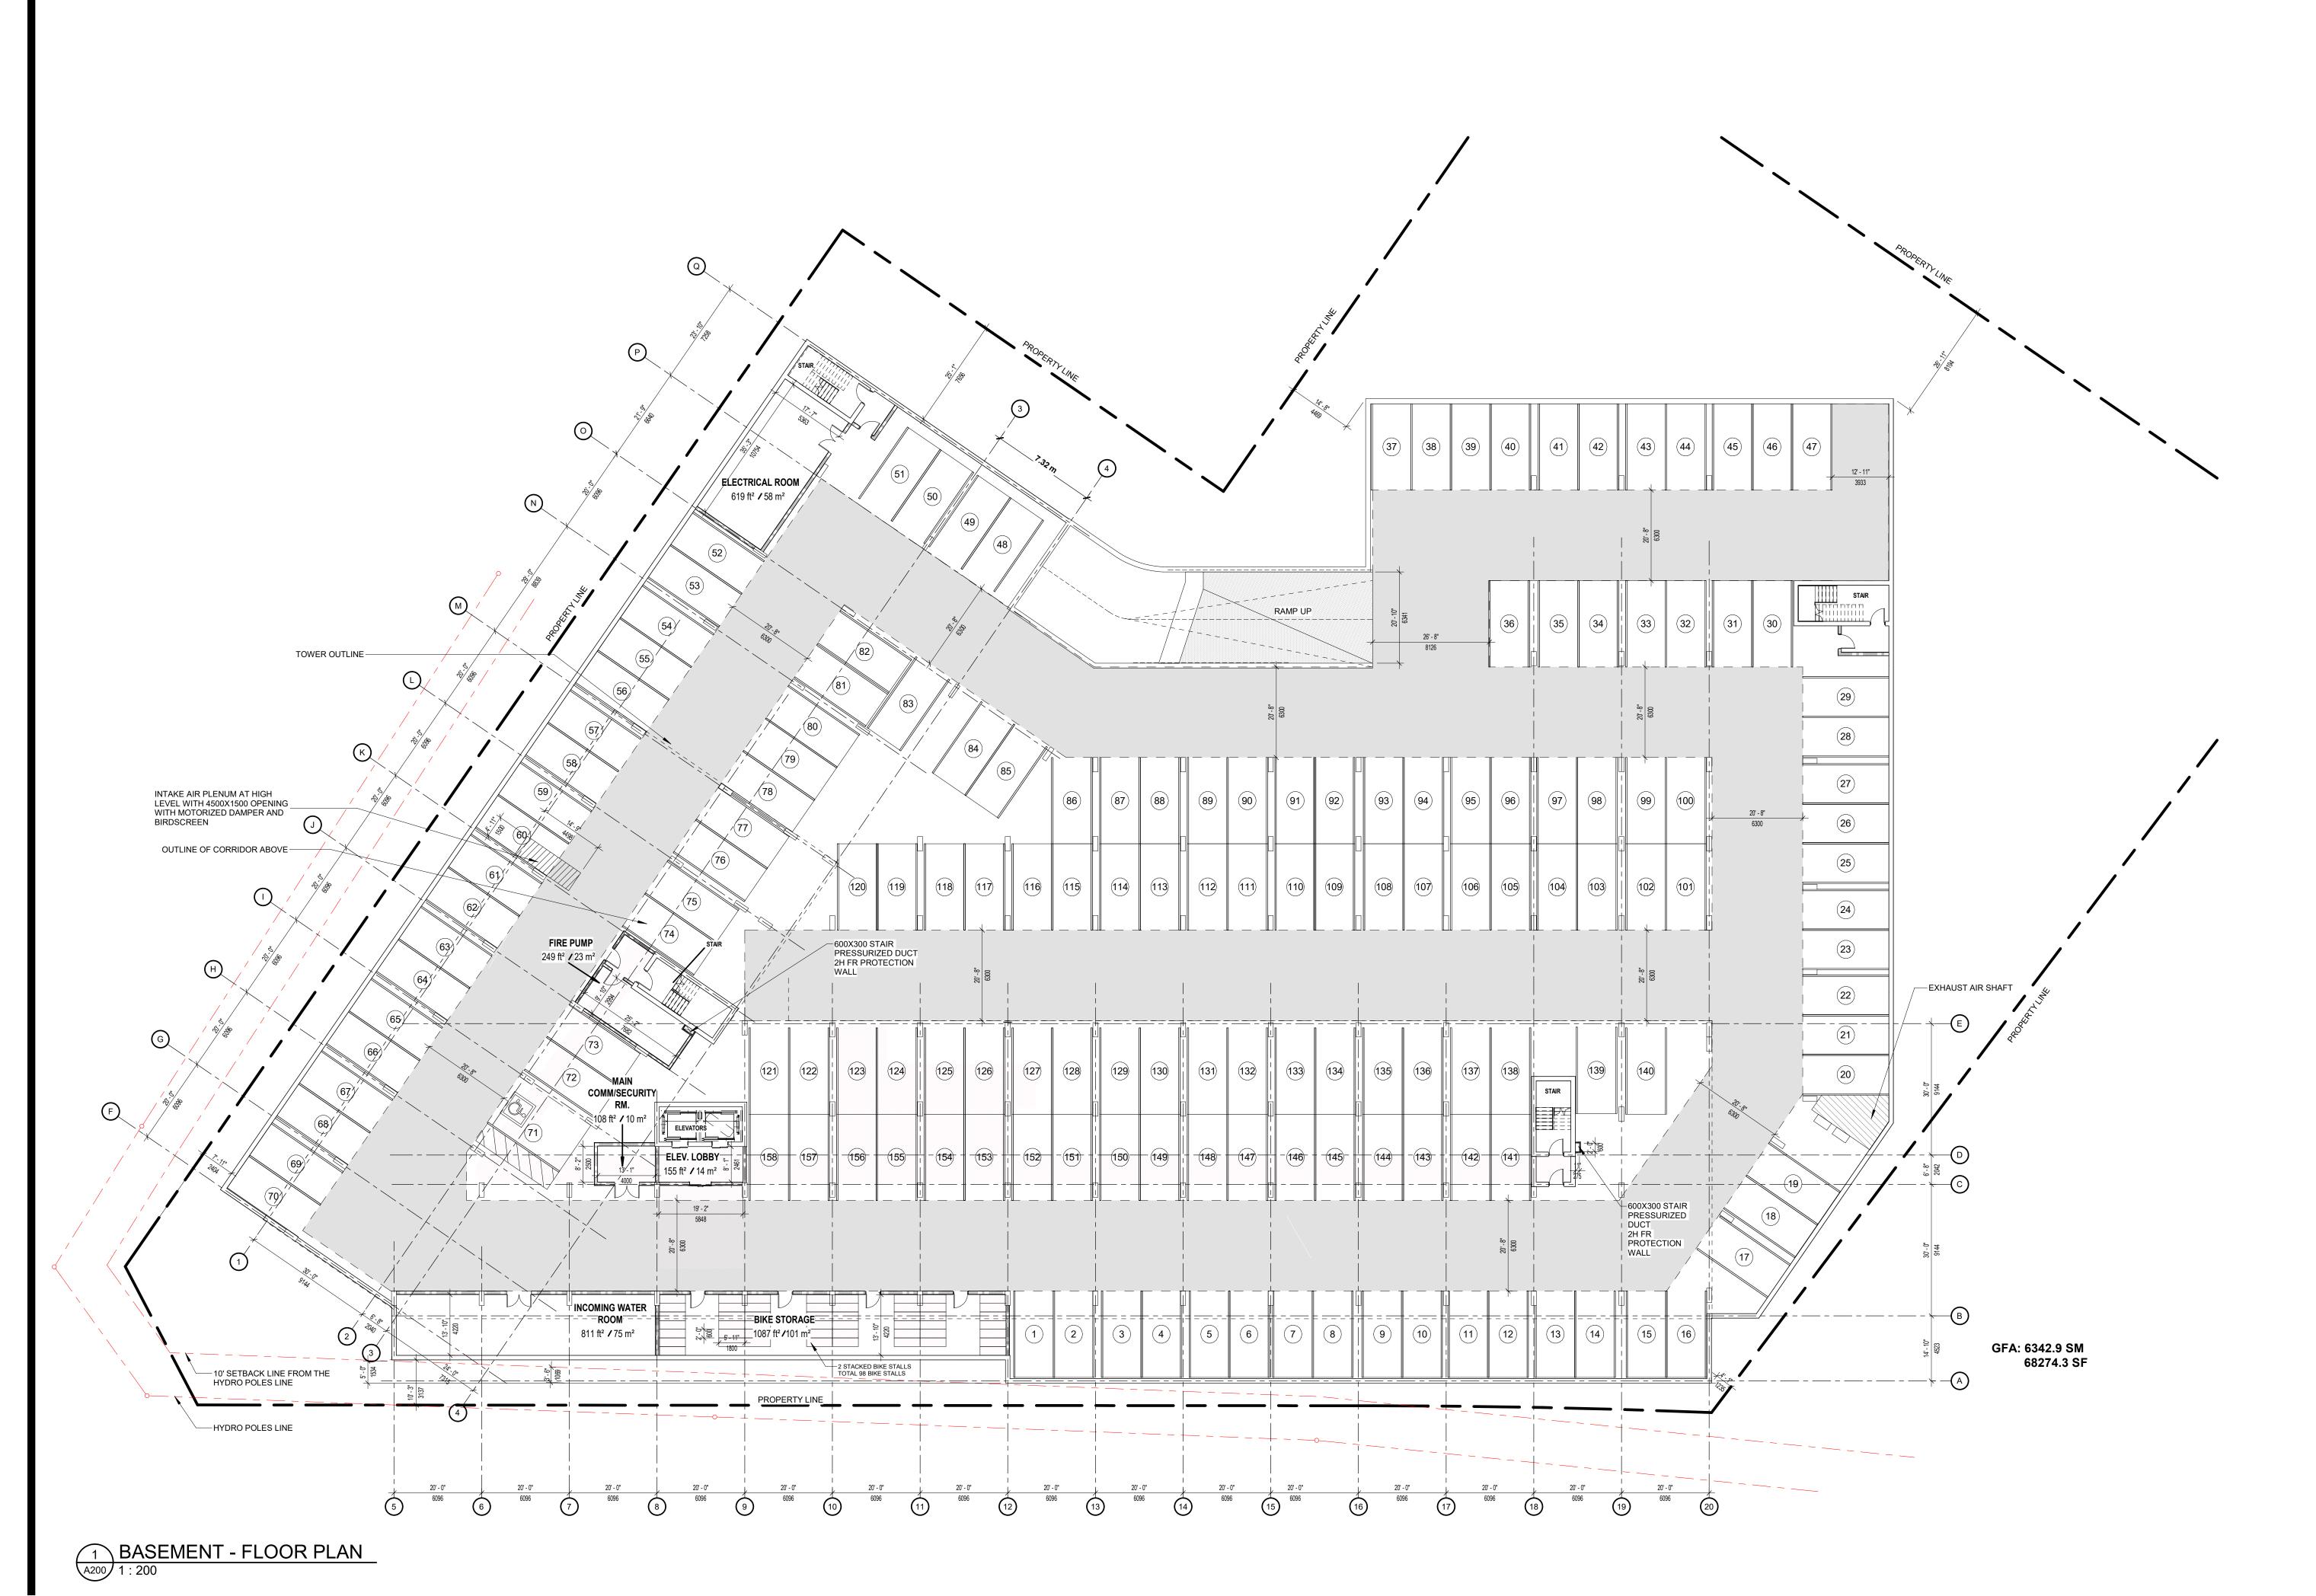

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ALL ELECTRICAL WORK TO BE COMPLETED AS PER

TO ALL BELOW GRADE FOUNDATION WALLS. PROVIDE APPROVED DRAINAGE LAYER TO FOUNDATION WALLS BELOW GRADE. ENSURE MIN. 6'-5" HEADROOM CLEARANCE BELOW DUCTS / BULKHEADS / BEAMS. PROVIDE VENTING TO EXTERIOR FOR ALL BATHROOMS & DRYERS. GAS FIREPLACES AND

PROVIDE TWO COATS OF ASPHALT DAMPPROOFING

RANGE HOODS ARE TO BE VENTED TO EXTERIOR w/ NON-COMBUSTIBLE AND CORROSION RESISTANT DUCTWORK. SMOKE DETECTORS ARE REQUIRED ON EACH FLOOR LEVEL AND IN EACH BEDROOM. THEY SHALL BE

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5/8" THICK SHEATHING GLUED & SCREWED UNLESS OTHERWISE NOTED. INTERIOR DOORS TO BE UNDERCUT 3/4" FOR ROOMS WITHOUT A RETURN AIR

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2 CP SITEPLAN SUBMISSION 2025-05-1 CP DESIGN DEVELOPMENT Date YY-MM-D Description

ISSUANCE SCHEDULE





PROFESSIONAL

CLIENT: M5V The Lundy Inc.


NIAGARA FALLS LUNDY'S LANE MIXED **USE-RESIDENTIAL** 8885-8911 Lundy's Lane Niagara Falls, L2H 1H3, Ontario, Canada

DRAWING TITLE

BASEMENT FLOOR PLAN

SHEET SCALE: DRAWN BY: A200

ISSUE DATE: 2025-05-31

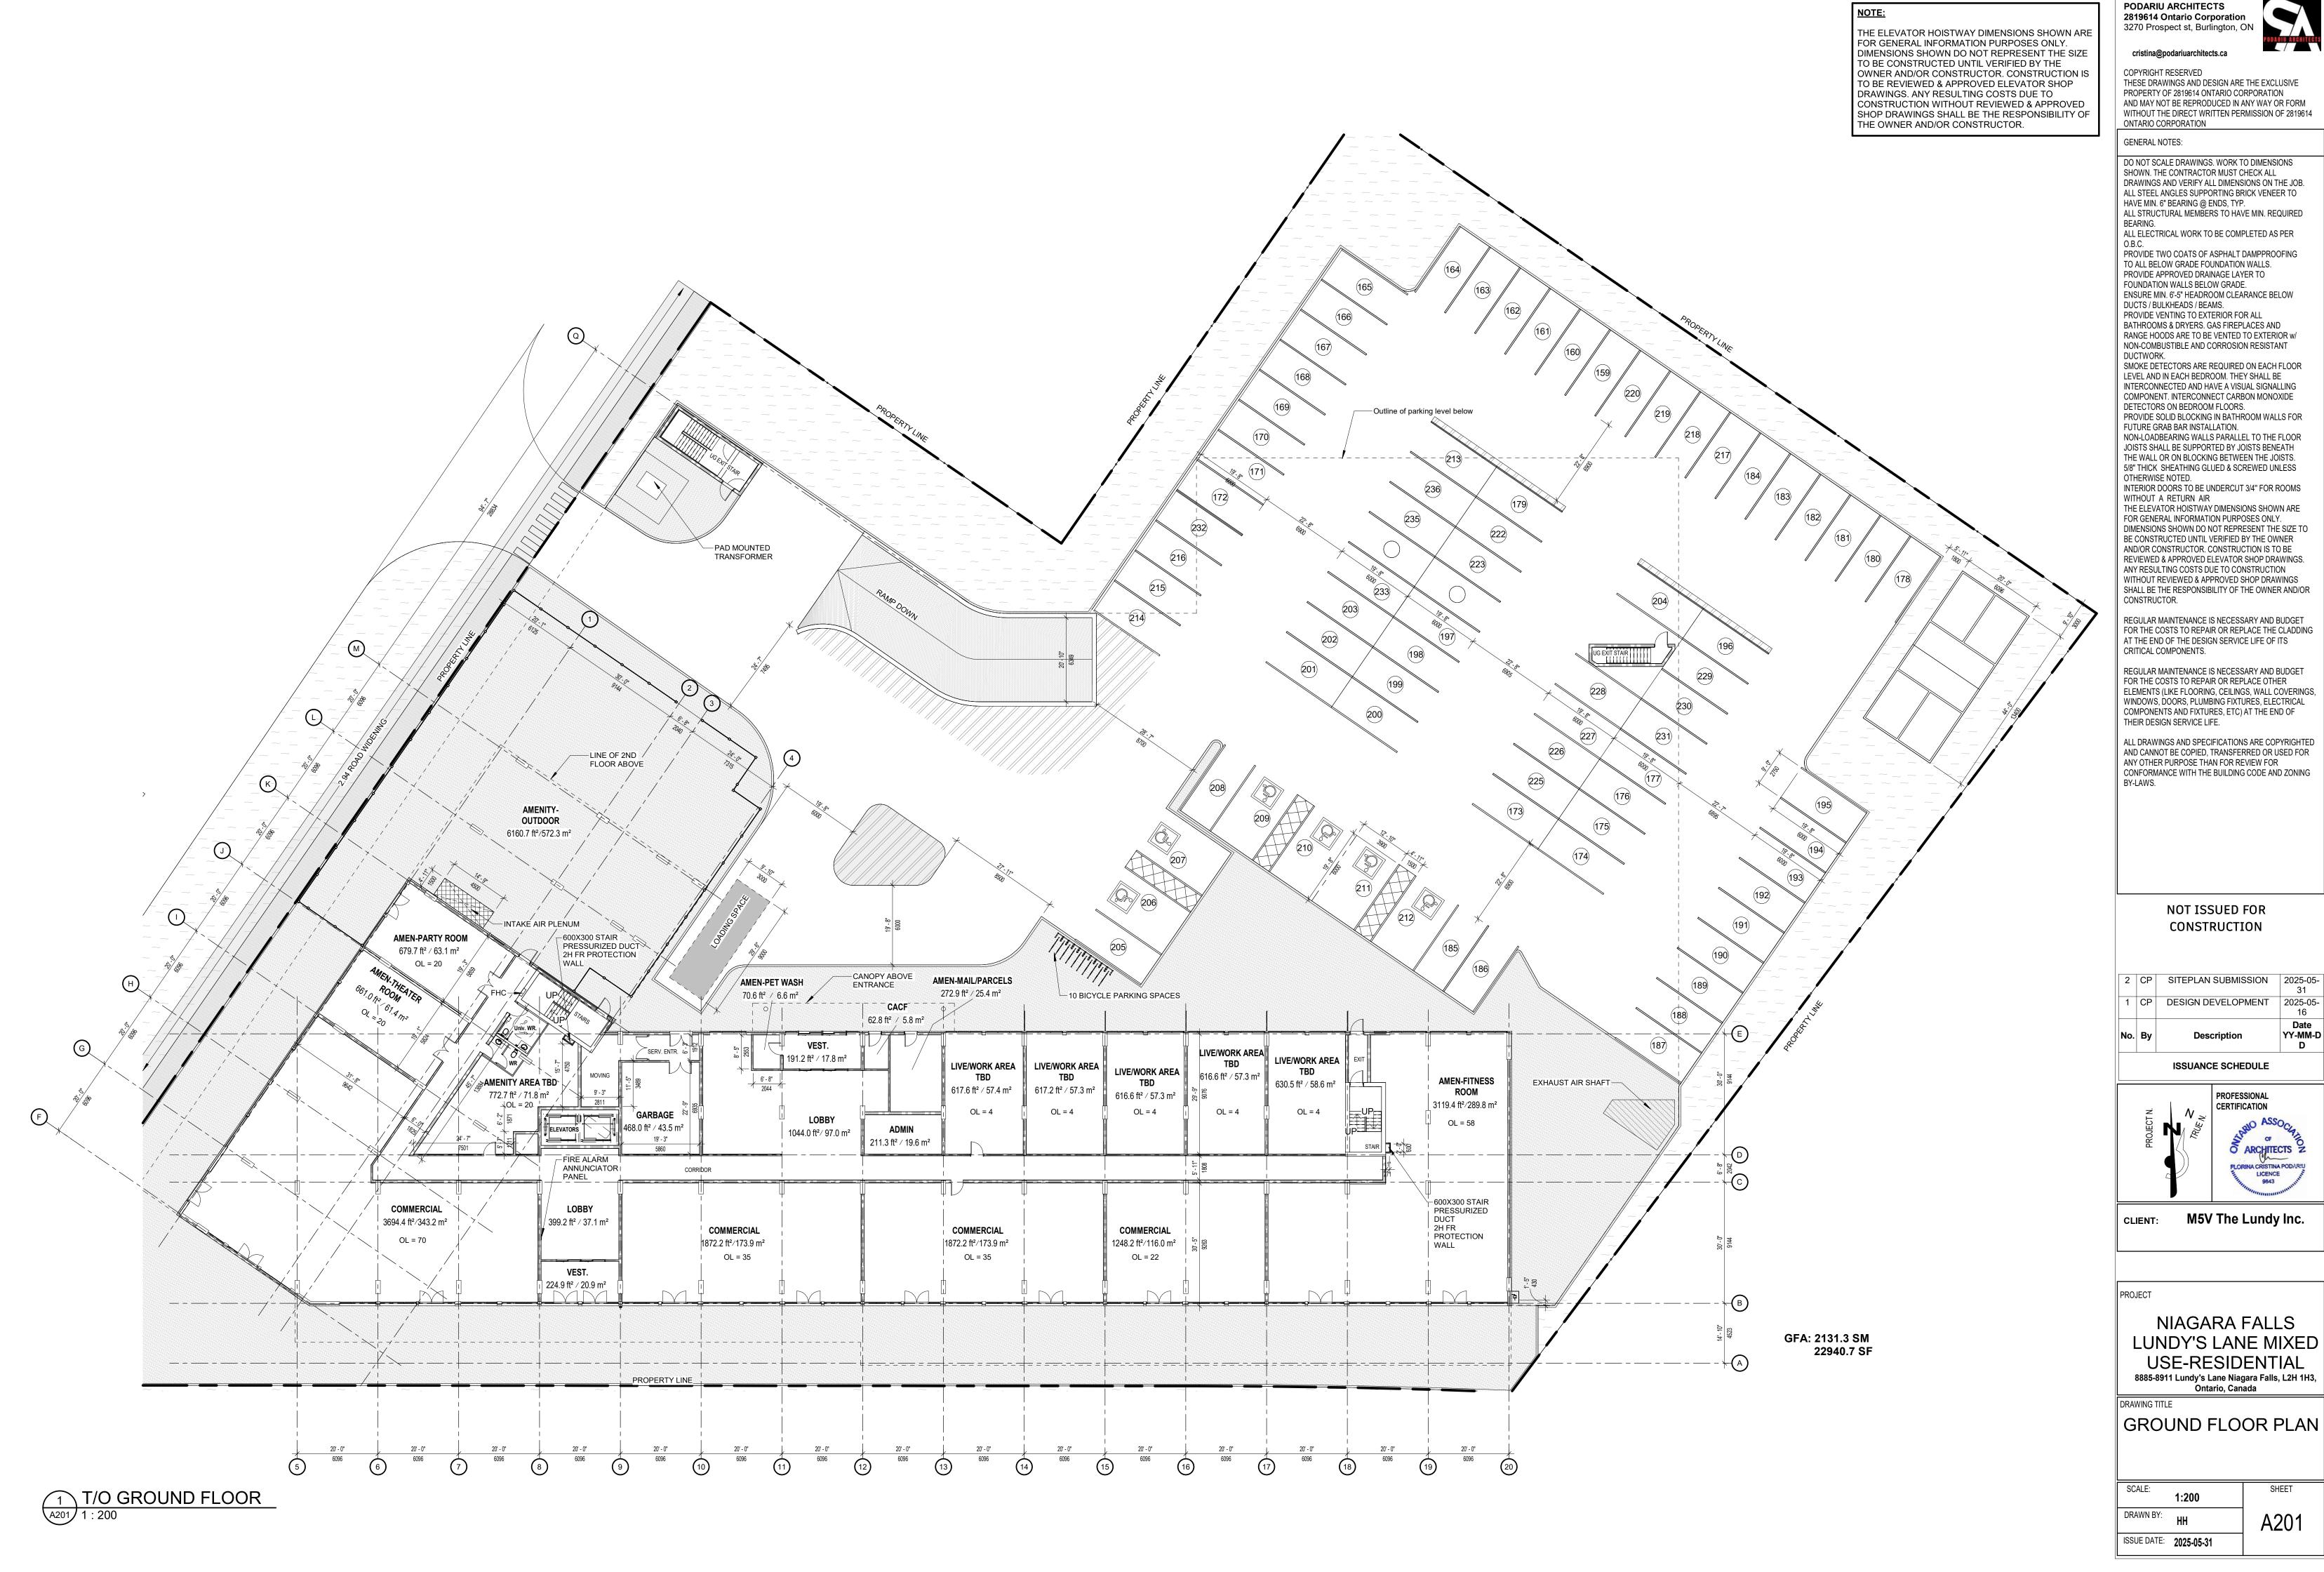

ARCHITECT:

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DRAWINGS AND VERIFY ALL DIMENSIONS ON THE JOB. ALL STEEL ANGLES SUPPORTING BRICK VENEER TO ALL STRUCTURAL MEMBERS TO HAVE MIN. REQUIRED

PROVIDE SOLID BLOCKING IN BATHROOM WALLS FOR

NON-LOADBEARING WALLS PARALLEL TO THE FLOOR

INTERIOR DOORS TO BE UNDERCUT 3/4" FOR ROOMS THE ELEVATOR HOISTWAY DIMENSIONS SHOWN ARE

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FOR THE COSTS TO REPAIR OR REPLACE THE CLADDING AT THE END OF THE DESIGN SERVICE LIFE OF ITS

FOR THE COSTS TO REPAIR OR REPLACE OTHER ELEMENTS (LIKE FLOORING, CEILINGS, WALL COVERINGS, WINDOWS, DOORS, PLUMBING FIXTURES, ELECTRICAL COMPONENTS AND FIXTURES, ETC) AT THE END OF

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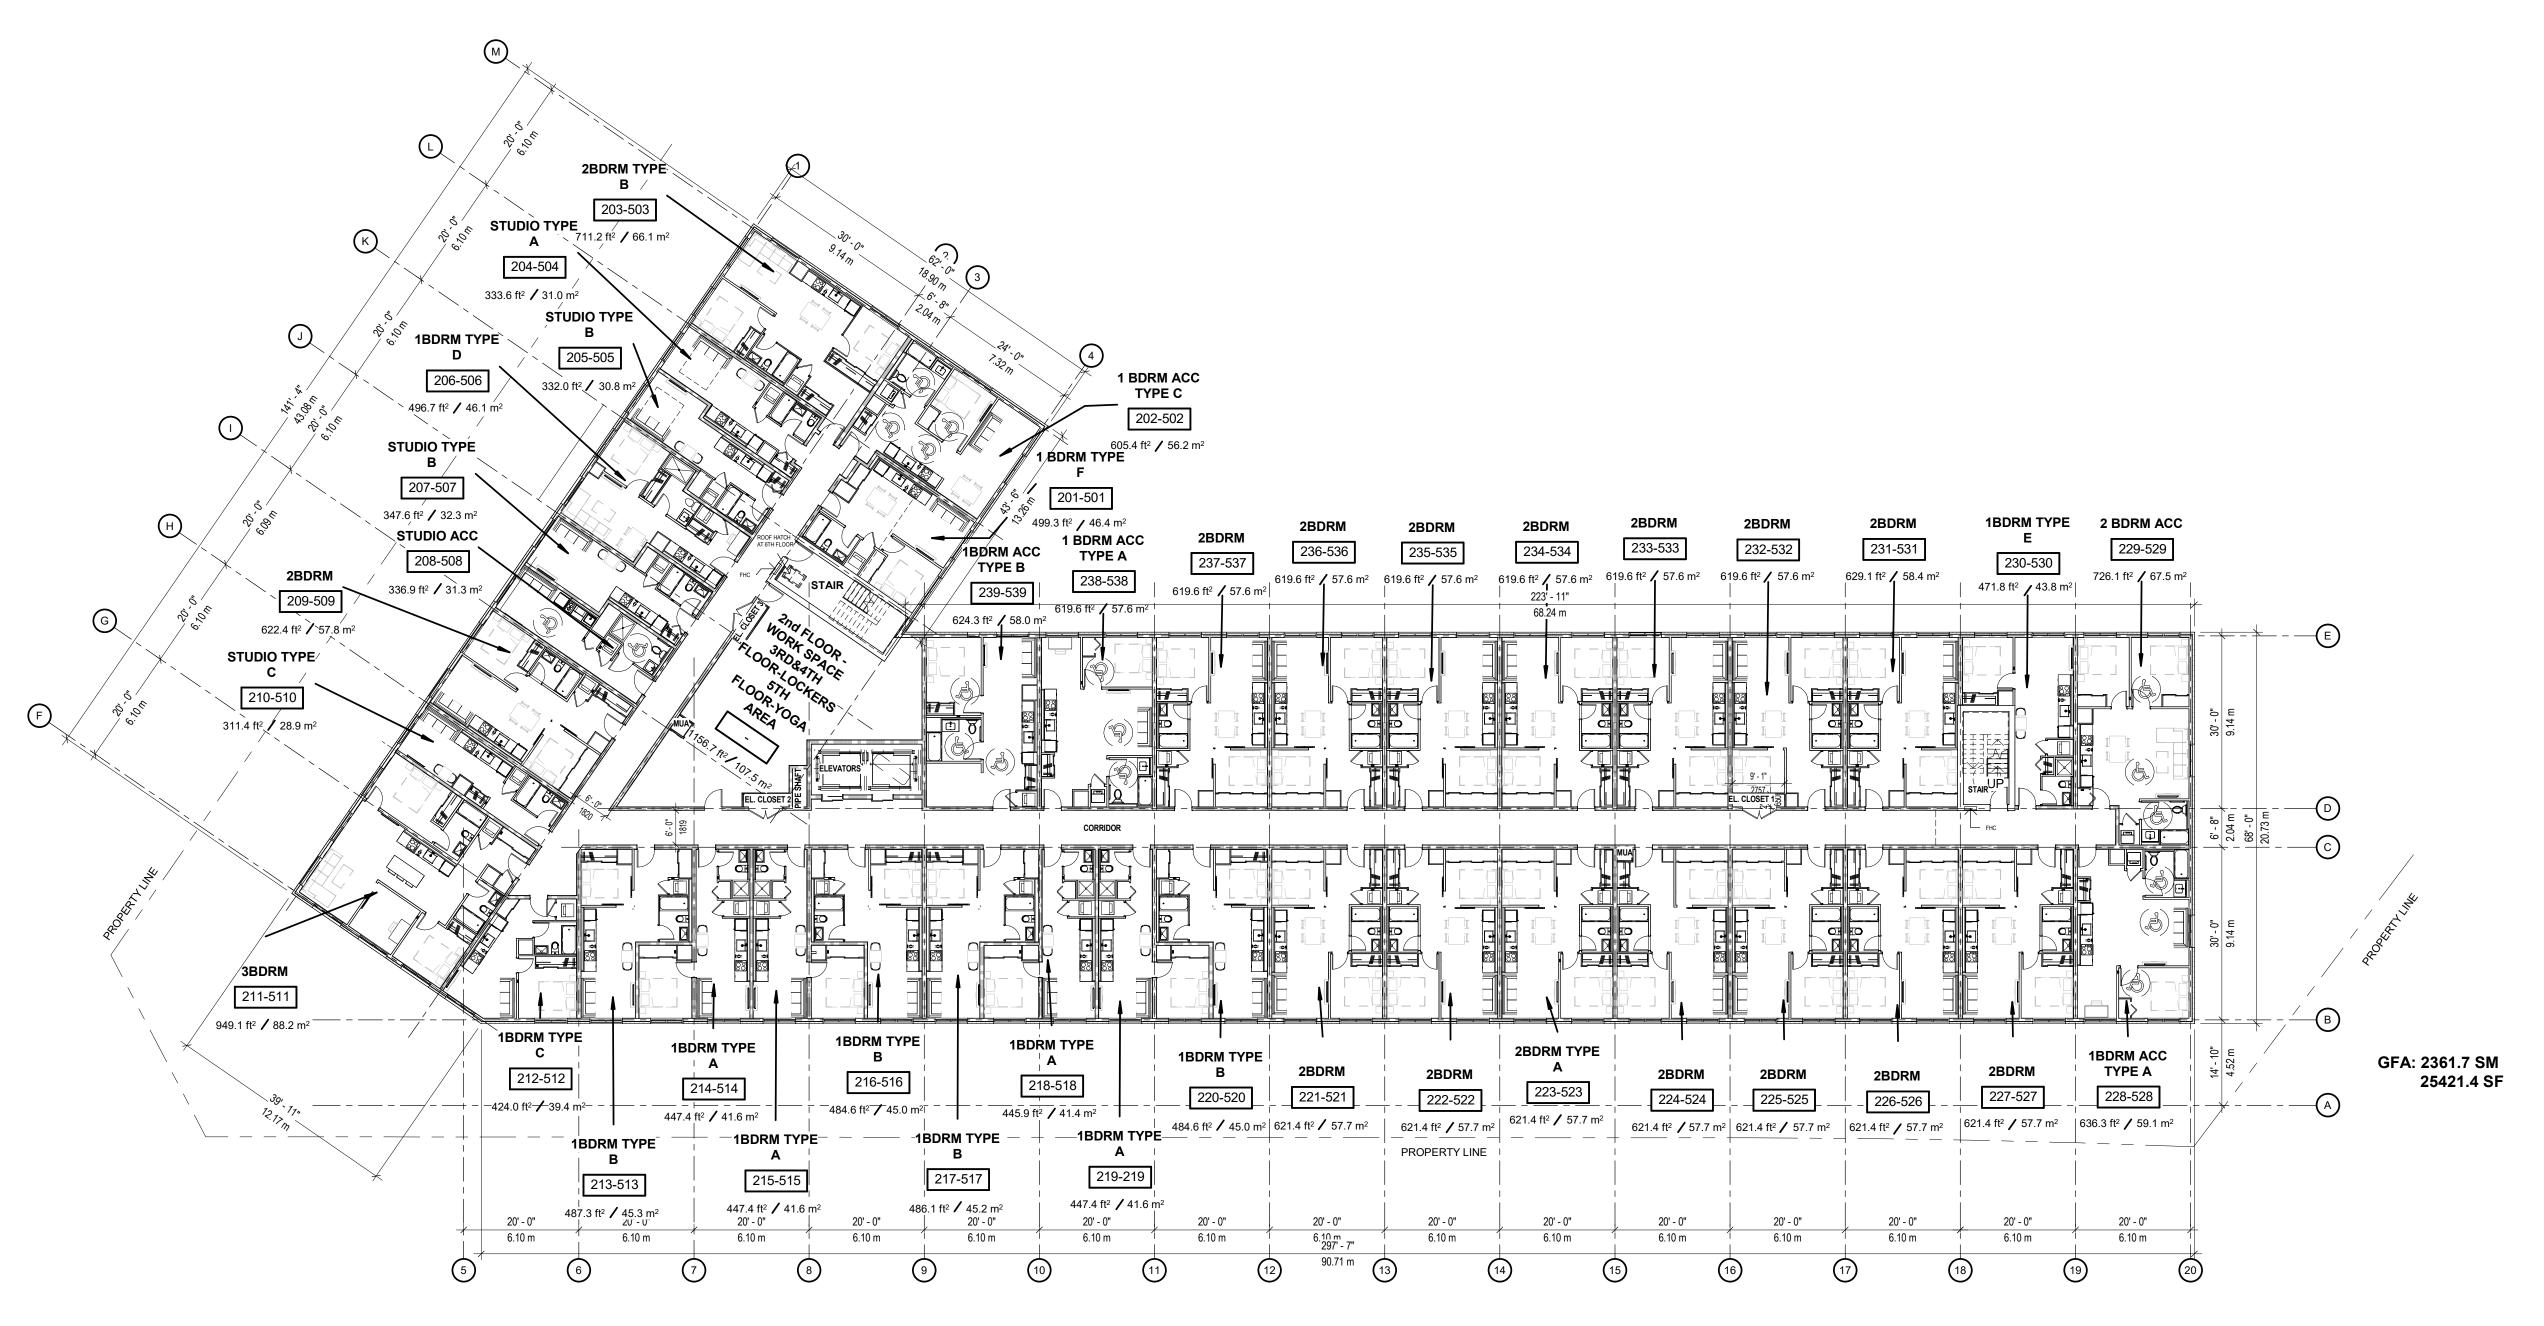
Date YY-MM-D



NIAGARA FALLS LUNDY'S LANE MIXED **USE-RESIDENTIAL**

SHEET

A201



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ALL ELECTRICAL WORK TO BE COMPLETED AS PER

ALL ELECTRICAL WORK TO BE COMPLETED AS PER O.B.C.
PROVIDE TWO COATS OF ASPHALT DAMPPROOFING

TO ALL BELOW GRADE FOUNDATION WALLS.
PROVIDE APPROVED DRAINAGE LAYER TO
FOUNDATION WALLS BELOW GRADE.
ENSURE MIN. 6'-5" HEADROOM CLEARANCE BELOW
DUCTS / BULKHEADS / BEAMS.
PROVIDE VENTING TO EXTERIOR FOR ALL
BATHROOMS & DRYERS. GAS FIREPLACES AND
BANCE HOOPS ARE TO BE VENTED TO EXTERIOR W

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ANY RESULTING COSTS DUE TO CONSTRUCTION

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NOT ISSUED FOR CONSTRUCTION

No.	Ву	Description	Date YY-MM-D
1	СР	DESIGN DEVELOPMENT	2025-05- 16
2	СР	SITEPLAN SUBMISSION	2025-05- 31

ISSUANCE SCHEDULE



M5V The Lundy Inc.

PRO

NIAGARA FALLS
LUNDY'S LANE MIXED
USE-RESIDENTIAL
8885-8911 Lundy's Lane Niagara Falls, L2H 1H3,
Ontario, Canada

DRAWING TITLE


TYPICAL FLOOR PLAN

SCALE: 1:200 SHEET

DRAWN BY: HH A202

ISSUE DATE: 2025-05-31

1 TYPICAL FLOOR PLAN (2nd-6th)

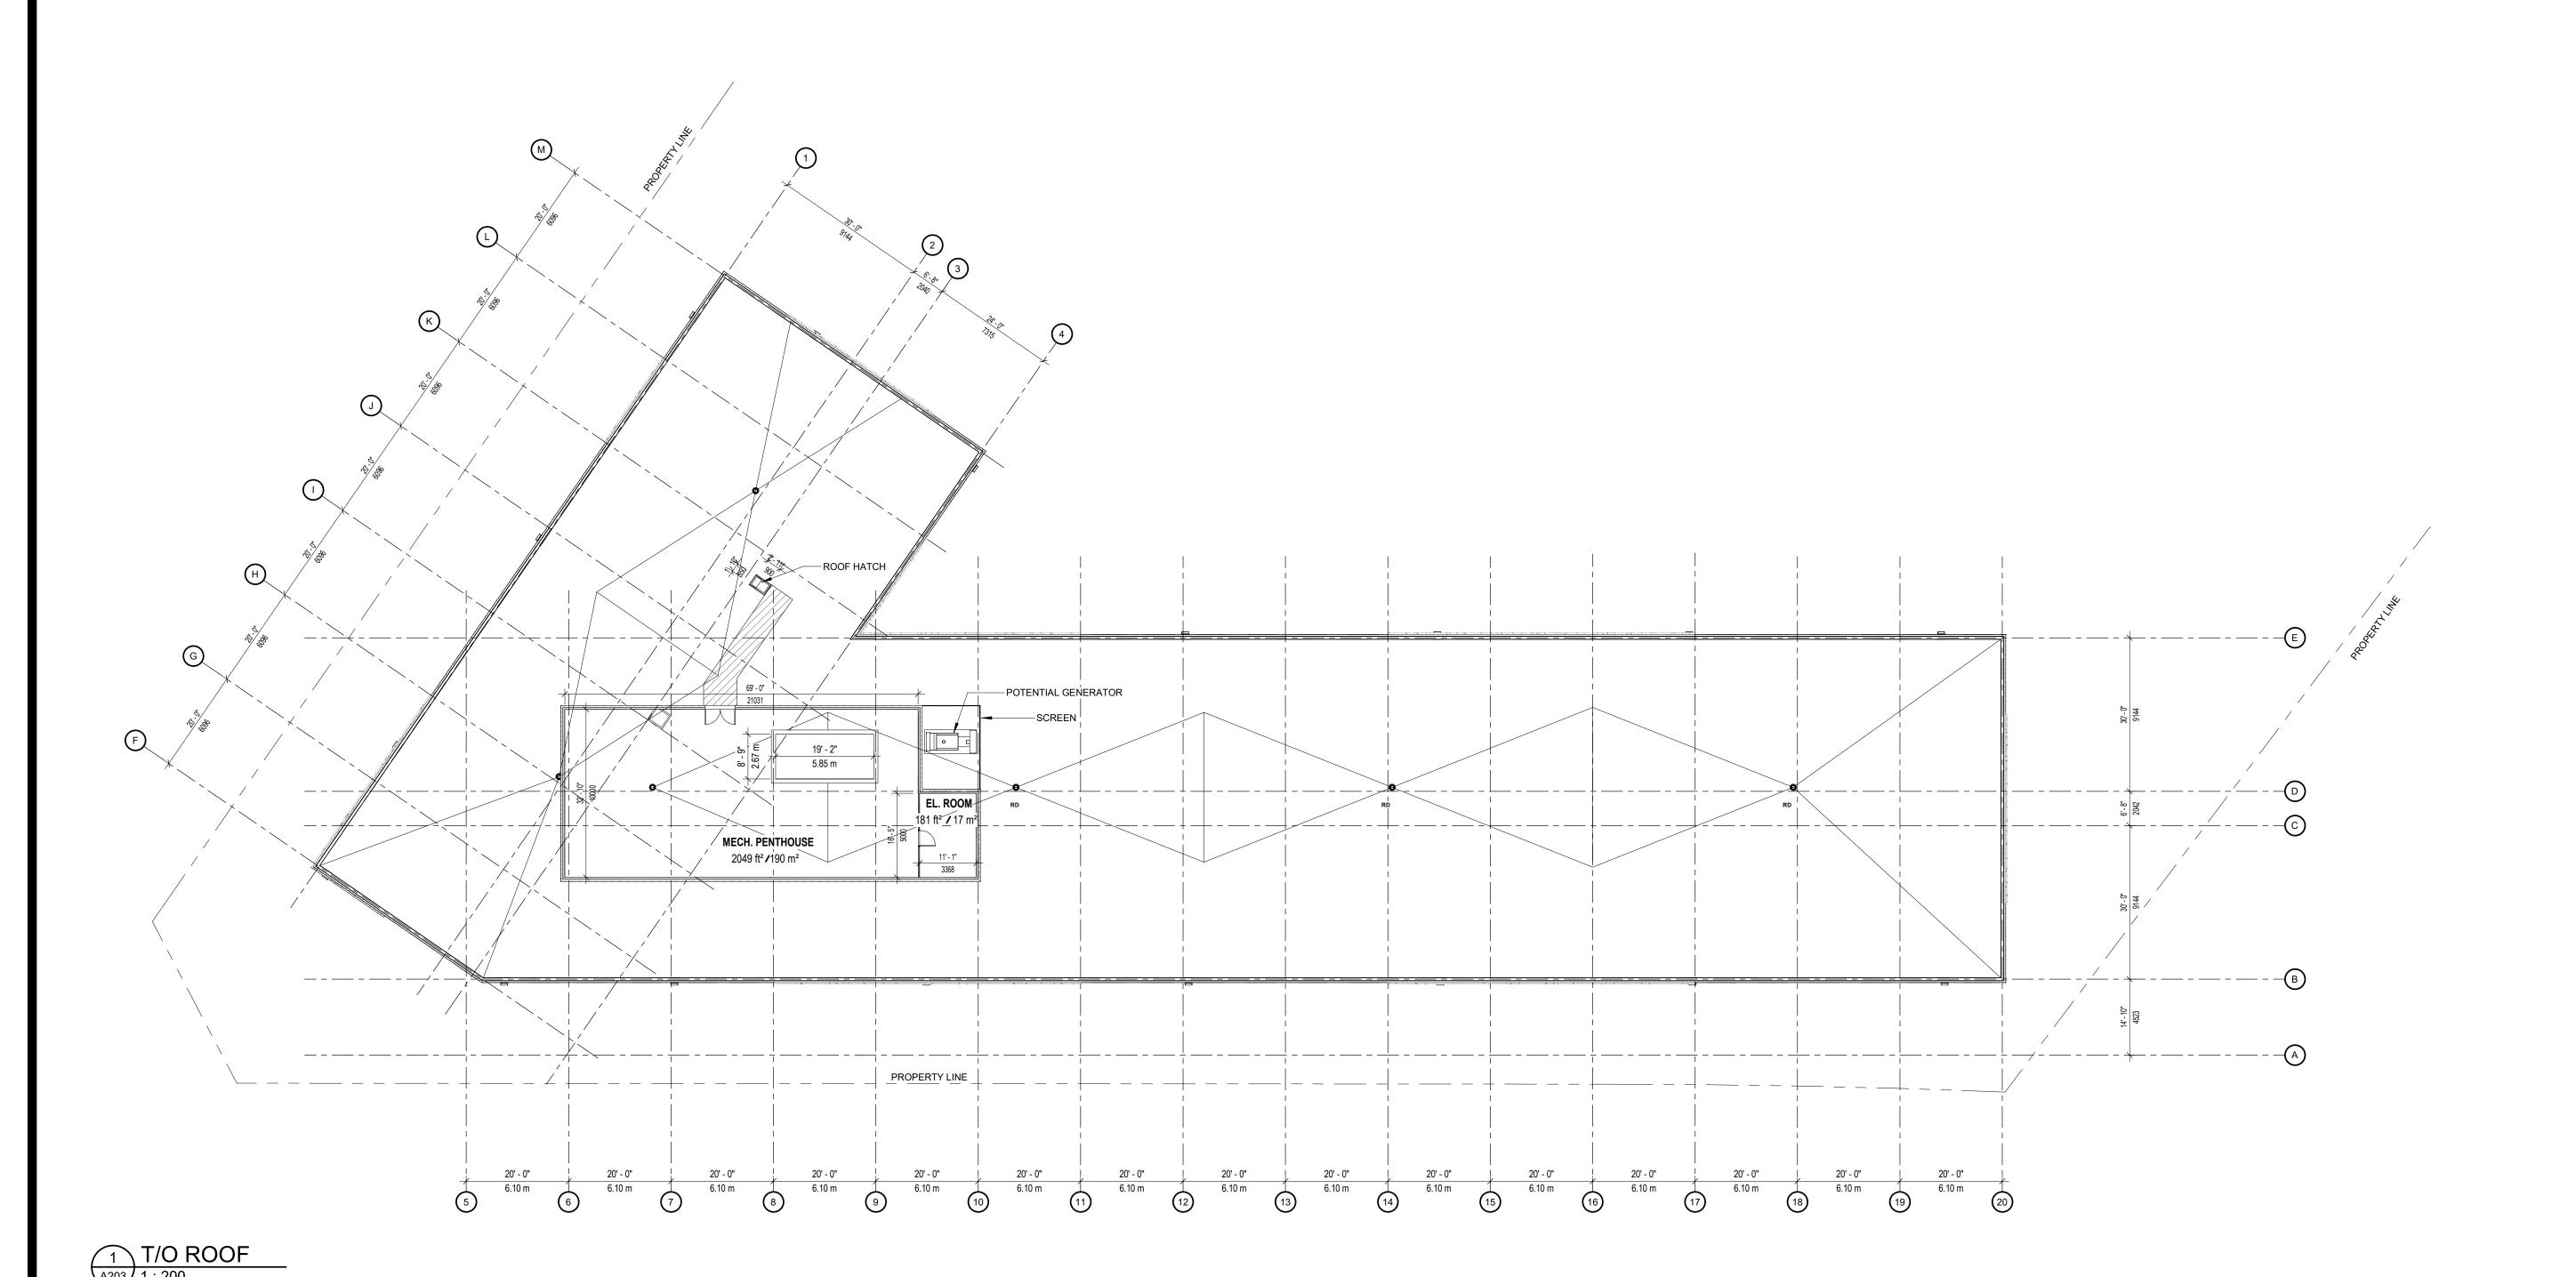

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OTHERWISE NOTED.

CONSTRUCTOR.

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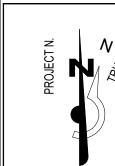
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NOT ISSUED FOR CONSTRUCTION

1 CP DESIGN DEVELOPMENT 202	
	1
2 CP SITEPLAN SUBMISSION 202	2







CLIENT: M5V The Lundy Inc.

NIAGARA FALLS LUNDY'S LANE MIXED **USE-RESIDENTIAL** 8885-8911 Lundy's Lane Niagara Falls, L2H 1H3, Ontario, Canada

DRAWING TITLE

ROOF PLAN

A203

ISSUE DATE: 2025-05-31

EXTERIOR ELEVATION LEGEND

- A1 MASONRY VENEER RAINSCREEN ASSEMBLY
- A3 WINDOW, ALUMINUM PROFILE, TERMALLY BROKEN FRAME, DUAL GLAZED, Max.U-value=0.45 for operable windows, Max. U-value=0.38 for fixed windows
- A10 CORNICE AND METAL FLASHING
- A14 EXTERIOR LIGHTING
- A15 WALL MOUNTED ILLUMINATED SIGNAGE
- A20 ROOF OVERFLOW SCUPPER



1 NORTH ELEVATION



2 EAST ELEVATION A301 1 : 150

PODARIU ARCHITECTS 2819614 Ontario Corporation 3270 Prospect st, Burlington, ON

cristina@podariuarchitects.ca

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No.	Ву	Description	Date YY-MM-D
1	СР	DESIGN DEVELOPMENT	2025-05- 16
2	СР	SITEPLAN SUBMISSION	2025-05- 31

ISSUANCE SCHEDULE **PROFESSIONAL**



M5V The Lundy Inc. CLIENT:

NIAGARA FALLS LUNDY'S LANE MIXED **USE-RESIDENTIAL** 8885-8911 Lundy's Lane Niagara Falls, L2H 1H3, Ontario, Canada

EXTERIOR ELEVATION

SCALE: DRAWN BY:

A301 ISSUE DATE: 2025-05-31

SHEET

EXTERIOR ELEVATION LEGEND Max.U-value=0.45 for operable windows, Max. U-value=0.38 for fixed windows



1 SOUTH ELEVATION - LUNDY'S LANE



WEST ELEVATION - GARNER ROAD
1: 150

A1 MASONRY VENEER RAINSCREEN ASSEMBLY

A3 WINDOW, ALUMINUM PROFILE, TERMALLY BROKEN FRAME, DUAL GLAZED,

A10 CORNICE AND METAL FLASHING

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ARCHITECT:

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		ISSUANCE SCHEDULE			
No.	Ву	Description	Date YY-MM-D		
1	СР	DESIGN DEVELOPMENT	2025-05- 16		
2	СР	SITEPLAN SUBMISSION	2025-05- 31		

PROFESSIONAL CERTIFICATION FLORINA CRISTINA PODARIL LICENCE 9843

M5V The Lundy Inc.

NIAGARA FALLS LUNDY'S LANE MIXED **USE-RESIDENTIAL** 8885-8911 Lundy's Lane Niagara Falls, L2H 1H3, Ontario, Canada

DRAWING TITLE


EXTERIOR ELEVATION


SCALE: DRAWN BY:

ISSUE DATE: 2025-05-31


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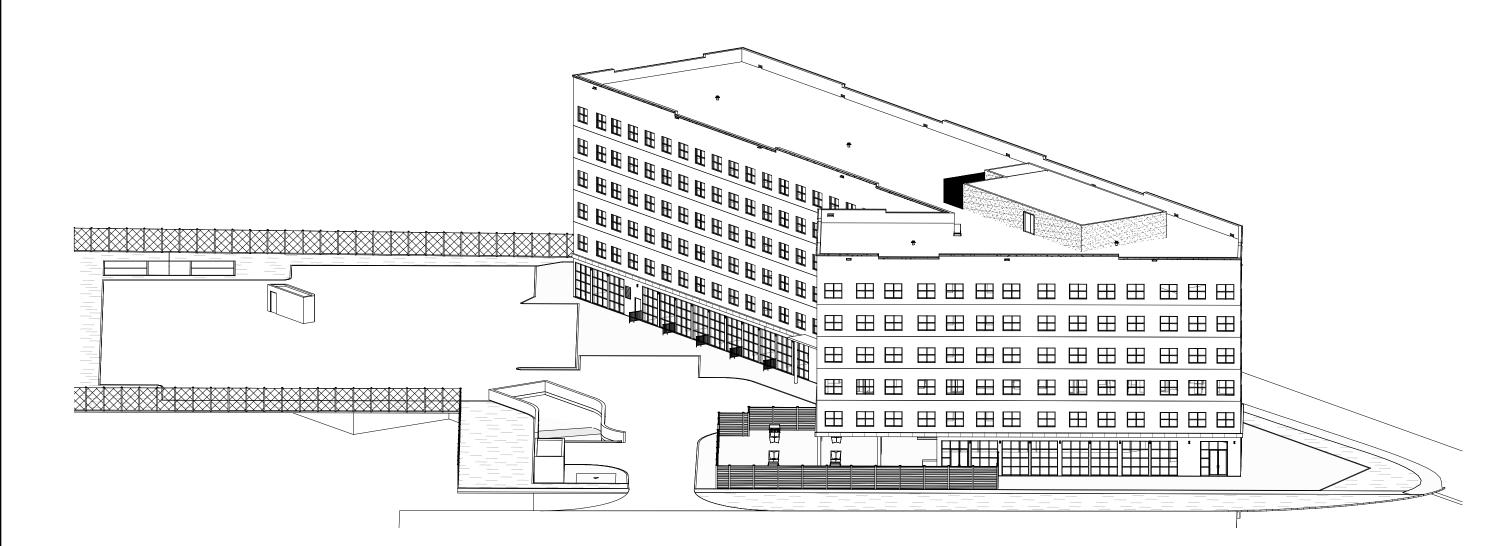
A302




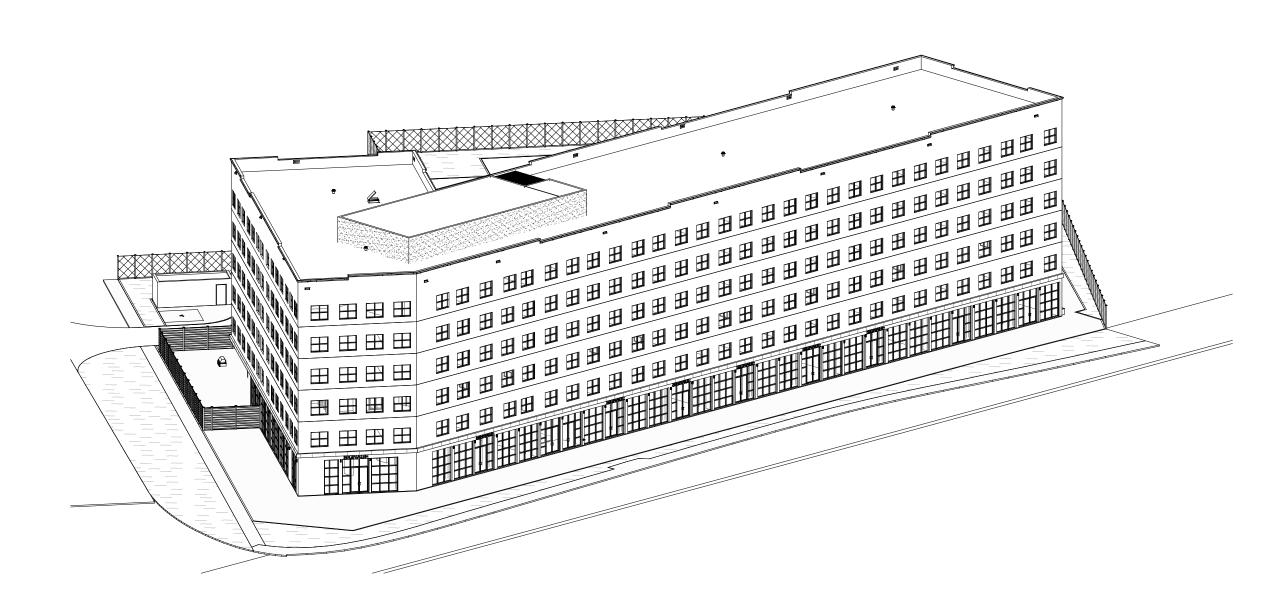

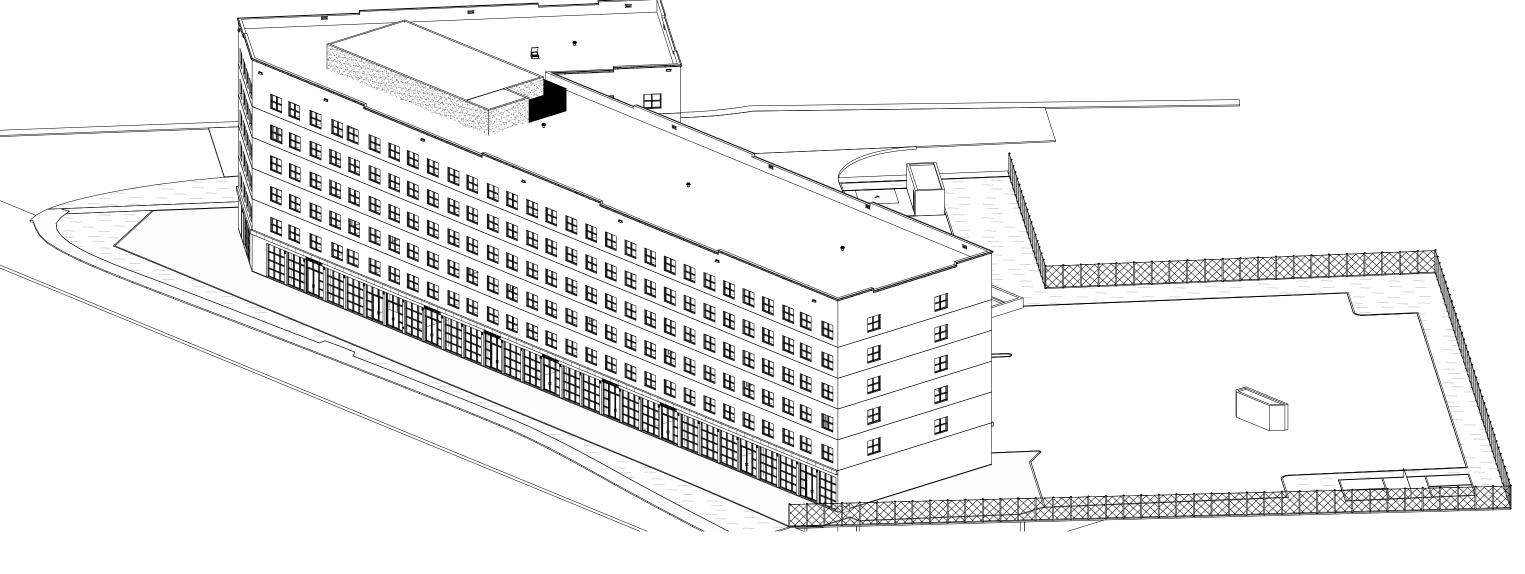2 ISO 02



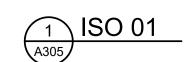

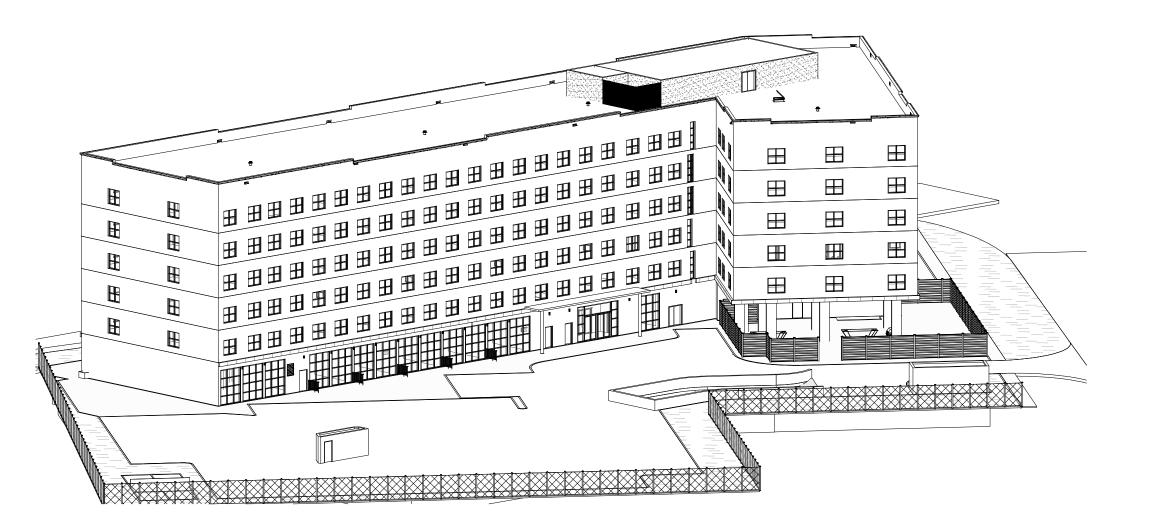

4 ISO 04

3 ISO 03

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1	СР	DESIGN DEVELOPMENT	2025-05- 16
2	СР	SITEPLAN SUBMISSION	2025-05- 31

ISSUANCE SCHEDULE



CLIENT: M5V The Lundy Inc.

PROJ

NIAGARA FALLS
LUNDY'S LANE MIXED
USE-RESIDENTIAL
8885-8911 Lundy's Lane Niagara Falls, L2H 1H3,
Ontario, Canada

DRAWING TITLE

ISOMETRIC VIEWS

SCALE:	SHEET
DRAWN BY: HH	A305
ISSUE DATE: 2025-05-31	





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1	СР	DESIGN DEVELOPMENT	2025-0 16
2	СР	SITEPLAN SUBMISSION	2025-0 31

ISSUANCE SCHEDULE



ıт: M5V The Lundy Inc.

PRO

NIAGARA FALLS LUNDY'S LANE MIXED USE-RESIDENTIAL 8885-8911 Lundy's Lane Niagara Falls, L2H 1H3, Ontario, Canada

DRAWING TITLE

PERSPECTIVE VIEWS

SCALE:		SHEET
DRAWN BY:	НН	A30
ISSUE DATE:	2025-05-31	



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ISSUANCE SCHEDULE



NT: M5V The Lundy Inc.

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NIAGARA FALLS LUNDY'S LANE MIXED USE-RESIDENTIAL 8885-8911 Lundy's Lane Niagara Falls, L2H 1H3, Ontario, Canada

DRAWING TITL

PERSPECTIVE VIEWS

SCALE: SHEET

DRAWN BY: HH A307

ISSUE DATE: 2025-05-31