




Building Location Plan Site Information R2 ZONE

SITE AREA - 5726.40 SF

MAX LOT COVERAGE - 45%

MIN LANDSCAPED OPEN SPACE 30%

MAXIMUM HGT - 10M (32.81')

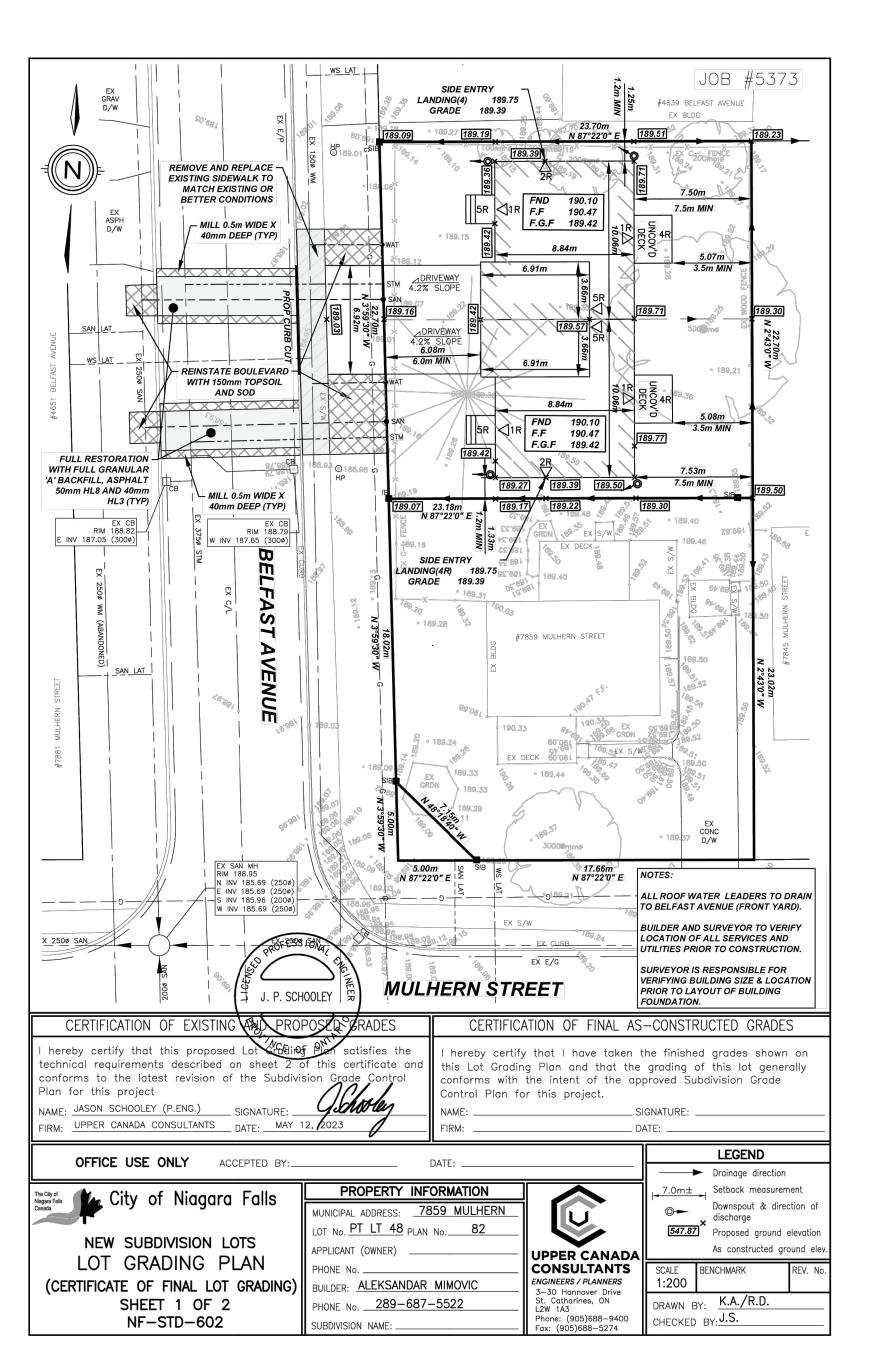



7859 MULHERN



consultant





drawing

Site Plan Project information

disclaimer

do not scale drawings, verify all dimensions and information prior to construction report any errors and/or descrepancies to the maker of these plans immediately. All construction must meet or exceed all applicable current building codes including all revisions. Contractor shall be responsible for proceeding with work not fully checked or verified on site to ensure intent of the drawings are fully adhered to in regards to the basic design intent.

copyright

all designs are the sole property of "andrew allen hellwig design consultants inc." reproduction, copying of this document shall not be considered in any way unless permission is granted by "andrew allen hellwig" (Designer)

date of issues and revisions


A- ISSUED FOR BUILDING PERMIT 2023-08-25 AAH

drawn drawing no.

reviewed

SP1.01

plot A 2023-70

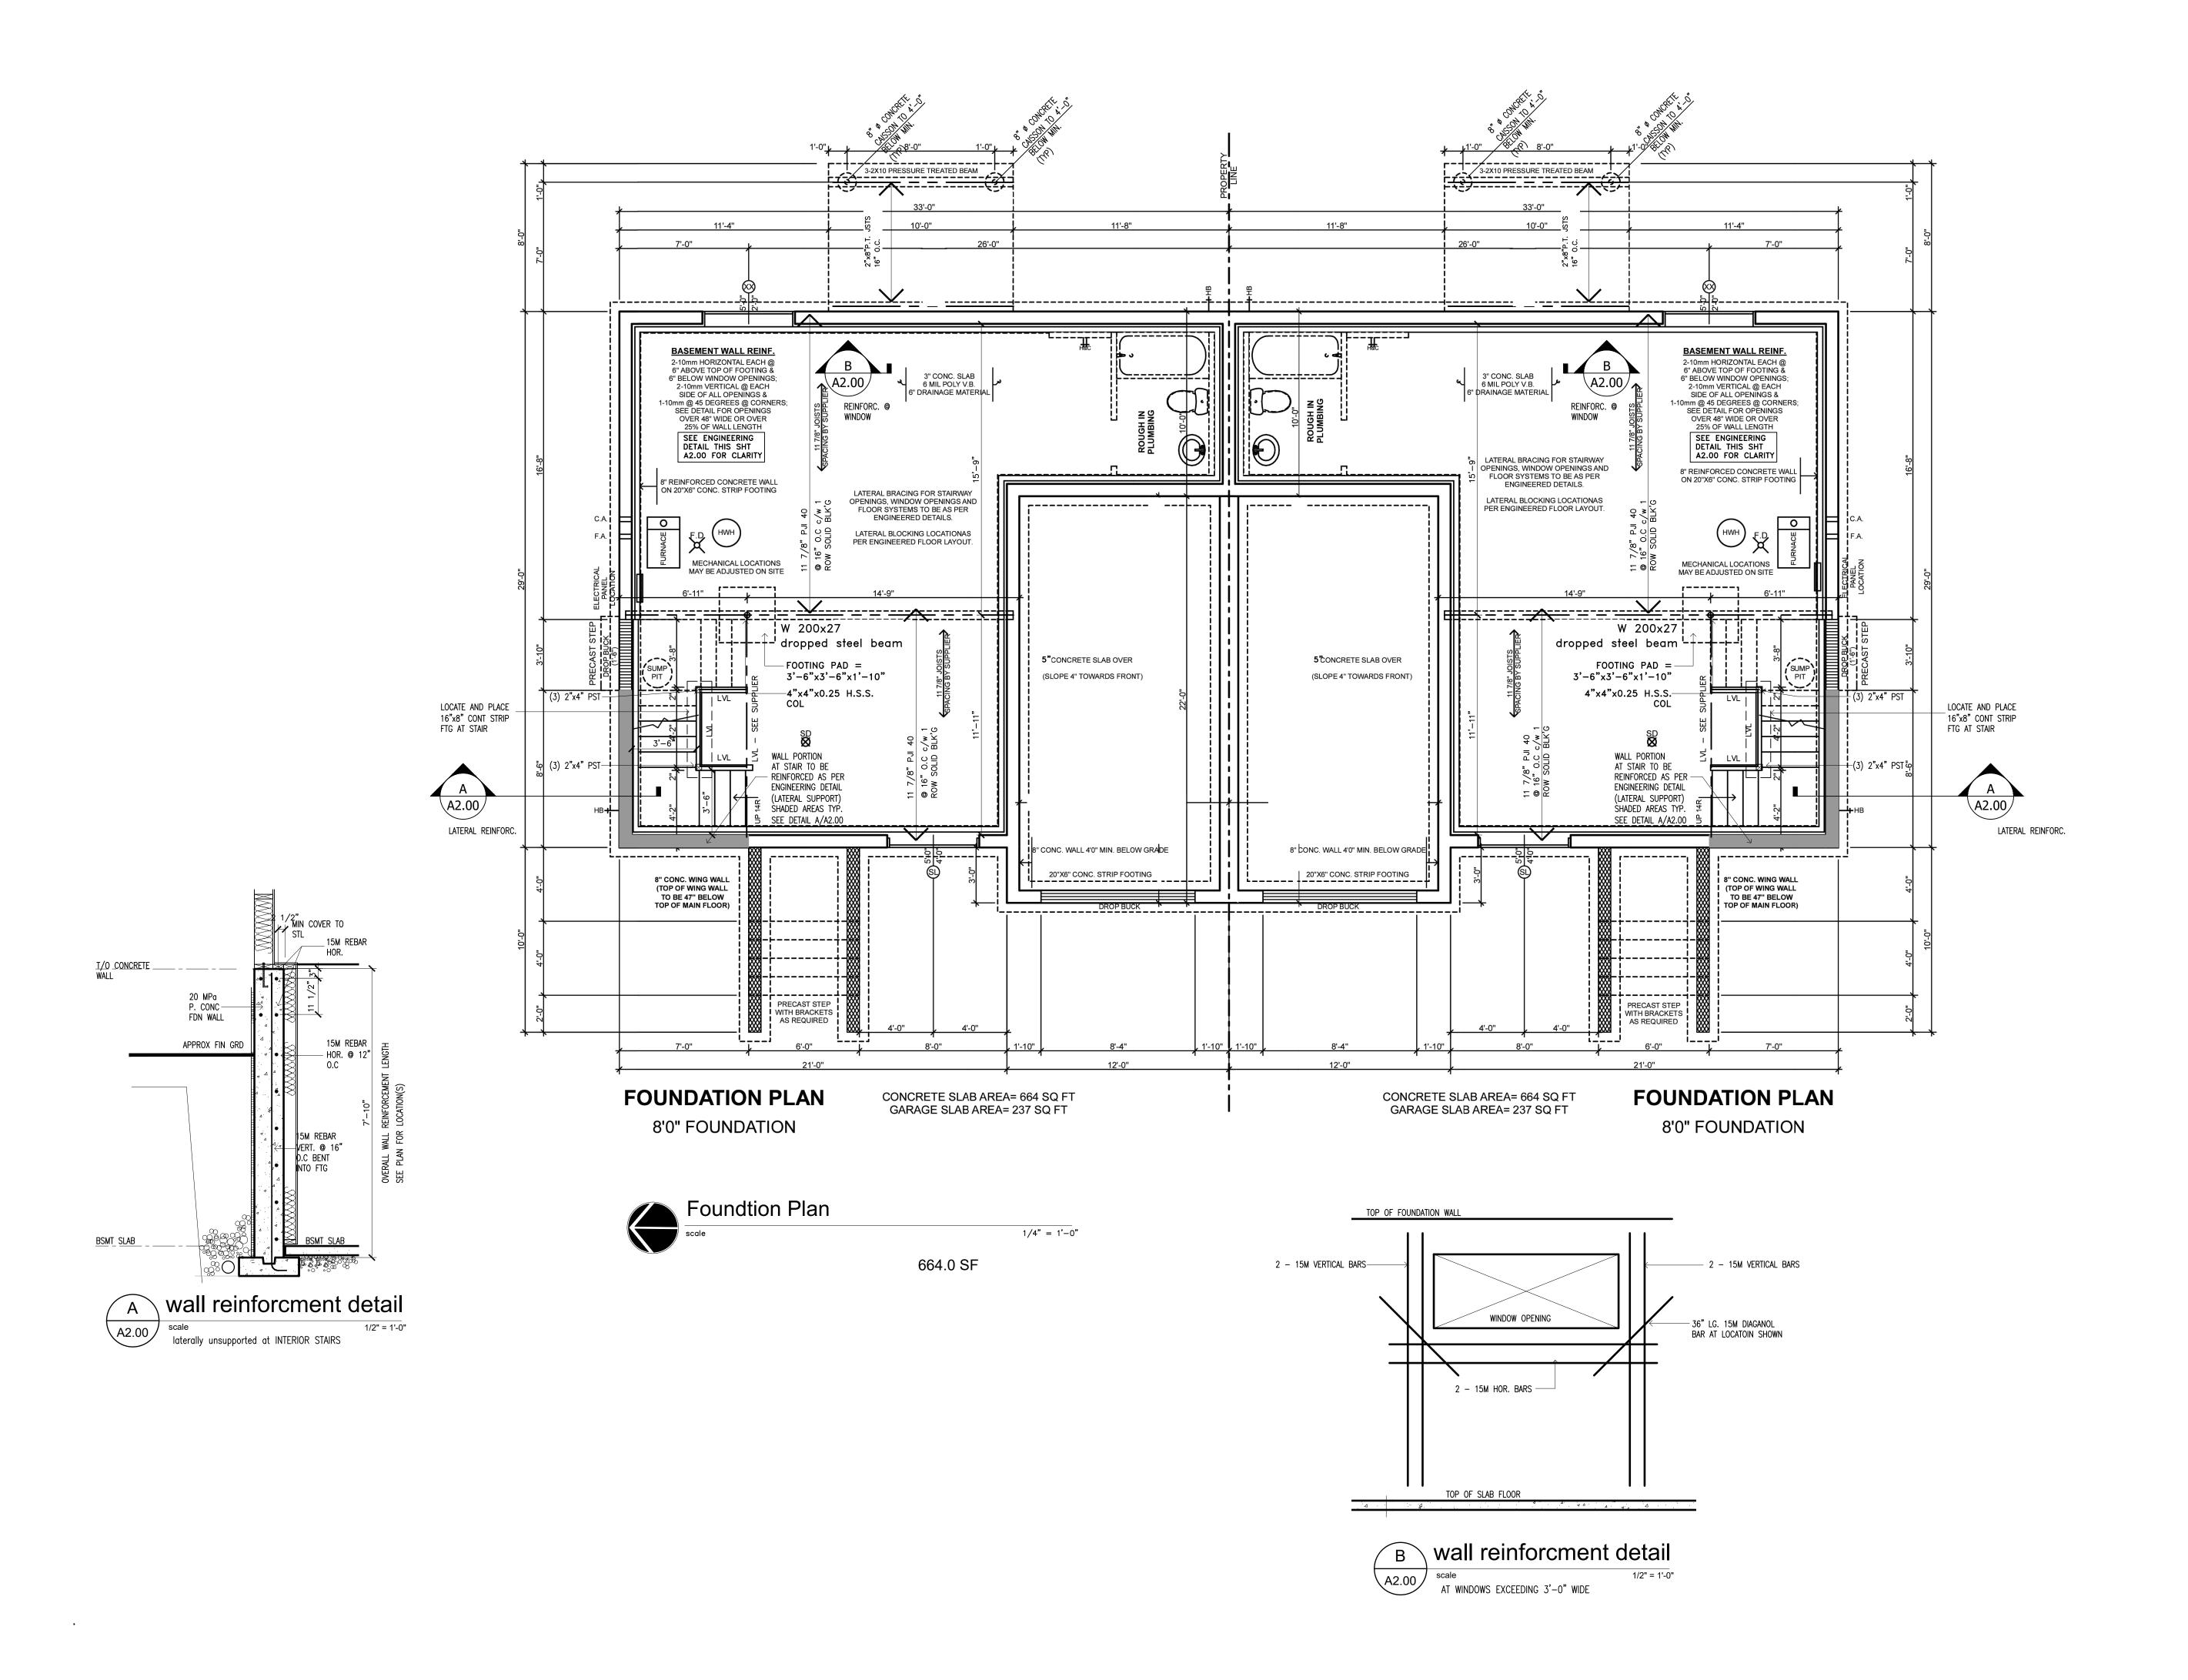







drawing

Foundation Basement Plan

disclaimer

do not scale drawings, verify all dimensions and information prior to construction report any errors and/or descrepancies to the maker of these plans immediately. All construction must meet or exceed all applicable current building codes including all revisions. Contractor shall be responsible for proceeding with work not fully checked or verified on site to ensure intent of the drawings are fully adhered to in regard to the basic design intent.

copyright

all designs are the sole property of "andrew allen hellwig design consultants inc." reproduction, copying of this document shall not be considered in any way unless permission is granted by "andrew allen hellwig" (Designer)

date of issues and revisions


A- ISSUED FOR BUILDING PERMIT 2023-08-25 AAH

drawn drawing no.

reviewed

plot A

A2.00

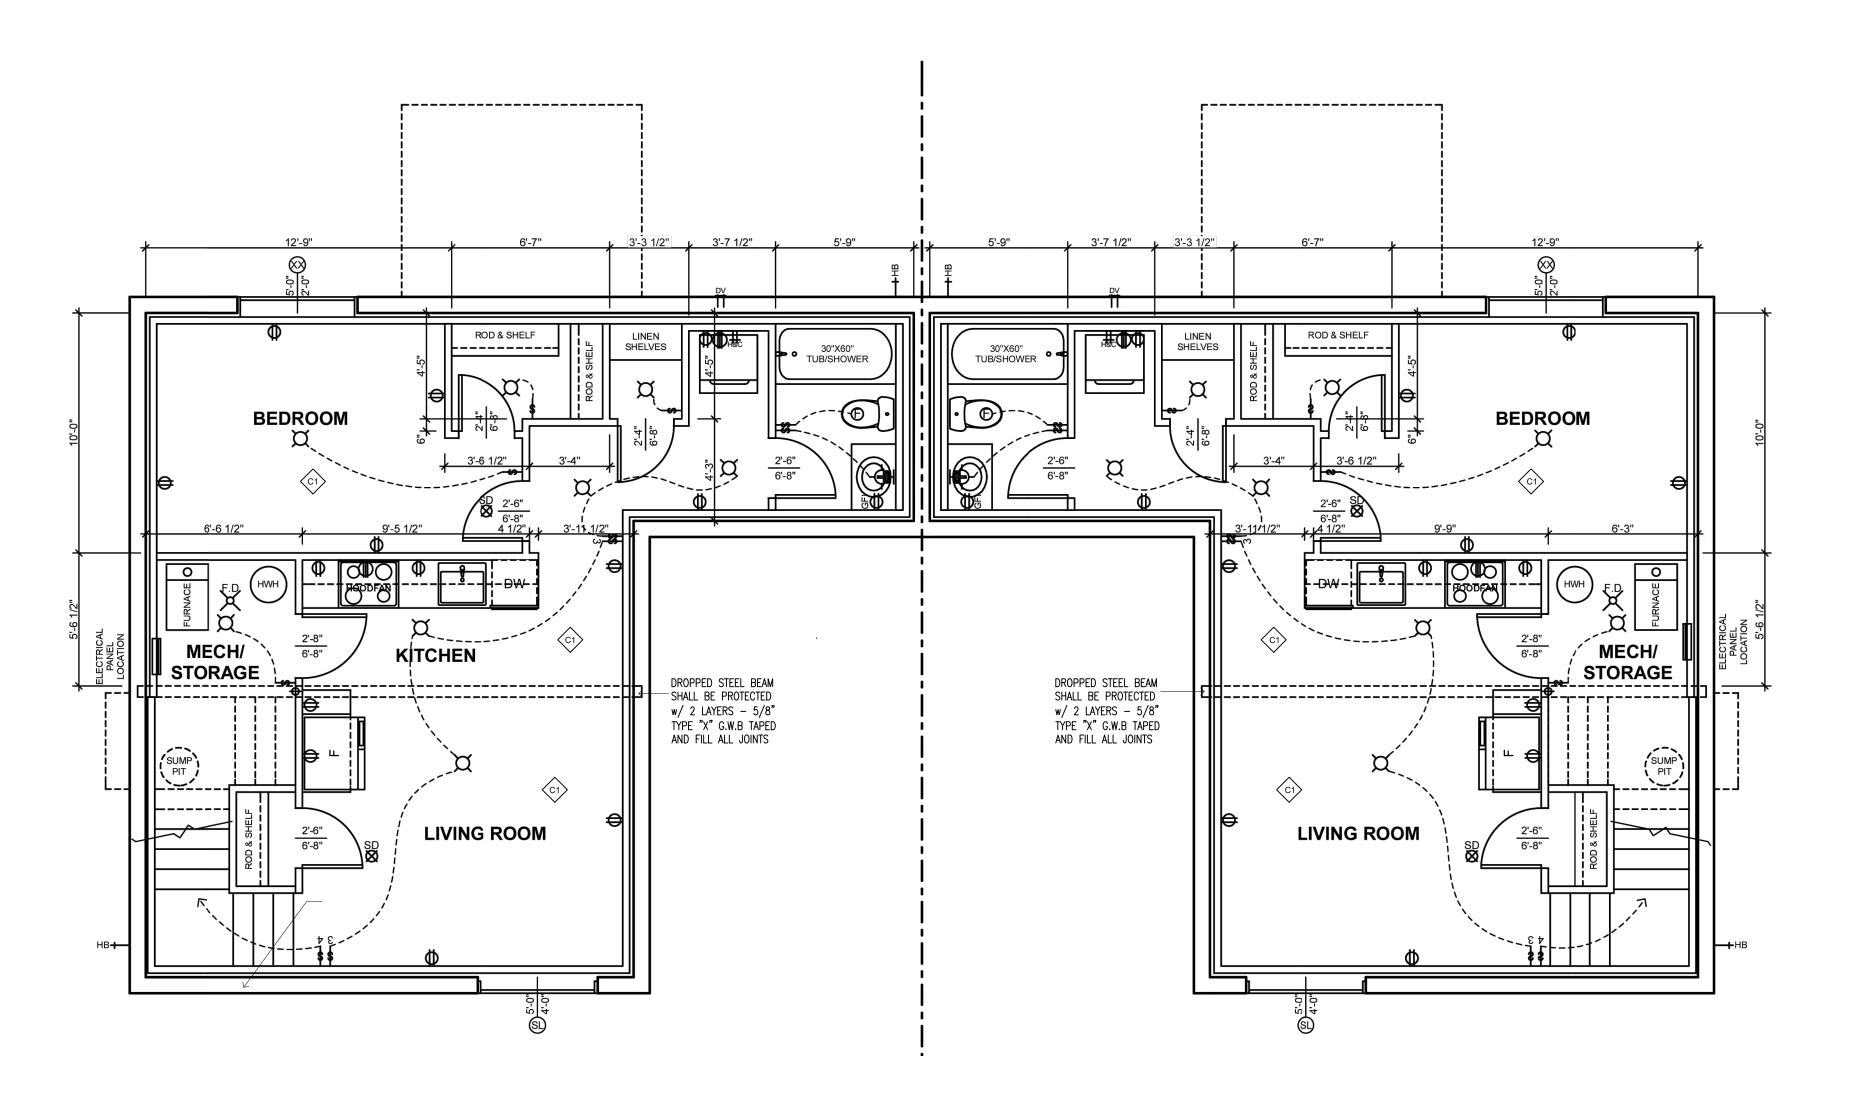



Floor/Ceiling Schedule

SEPARATION REQUIREMENT BETWEEN "ADU" + PRIMARY DWELLING - SEE DESCRIPTION AND FLOOR/ASSEMBLY TYPE INDICATED IN SCHEDULE BELOW

FLOOR/CEILING ASSEMBLY 30MIN F.R.R.

1/4" FIN FLOORING (PLYWD.)
3/4" T+G SPRUCE PLY SUB-FLOOR
PRE-ENGINEERED FLOOR JSTS (12"DP.) @ 16" O.C.
SOUND ATTENUATION BATTS IN CAVITY 2.8KG/M2 DENSITY
1 LAYER 5/8" TYPE "X" GYP. WALL BOARD

	Tabl Rise for Rectangular Treads, Tapered Tread Forming Part of Sentence			ectangular Trea	ads
Item	Column 1 Stair Type	Column 2 Max. Rise, mm, for All Steps	Column 3 Min. Rise, mm, for All Steps	Column 4 Max. <i>Run</i> , mm, for Rectangular Treads	Column 5 Min. Run, mm, for Rectangular Treads
1.	Private stairs ⁽¹⁾	200	125	355	255
2. 3.	Public stairs ⁽²⁾	180	125	no limit	280
3.	Service stairs ⁽³⁾	no limit	125	355	no limit
4.	Stairs to unoccupied attic space ⁽⁴⁾	no limit	125	355	no limit
5.	Stairs to crawl spaces	no limit	125	355	no limit
5.	Stairs that serve <i>mezzanines</i> not exceeding 20 m ² within <i>live/work units</i>	no limit	125	355	no limit
otes to	Table 9.8.4.1.:				
) Priva	te stairs are:				
(a) i	nterior stairs within a house or an individual dwelling	unit			
(b) e	xterior stairs serving a house or an individual dwellin	g unit, and			
	xterior stairs serving a garage that serves a <i>house</i> or a				

7859 MULHERN



no





drawing

Accessory Dwelling Basement Plan

disclaimer

do not scale drawings, verify all dimensions and information prior to construction report any errors and/or descrepancies to the maker of these plans immediately. All construction must meet or exceed all applicable current building codes including all revisions. Contractor shall be responsible for proceeding with work not fully becked or verified on site to ensure intent of the drawings are fully adhered to in regards to the basic design intent.

copyright

all designs are the sole property of "andrew allen hellwig design consultants inc." reproduction, copying of this document shall not be considered in any way unless permission is granted by "andrew allen hellwig" (Designer)

date of issues and revisions

A- ISSUED FOR BUILDING PERMIT 2023-08-25 AAH


drawn

drawing no.

reviewed

A2.00B

 $_{\mathsf{plot}}$ A

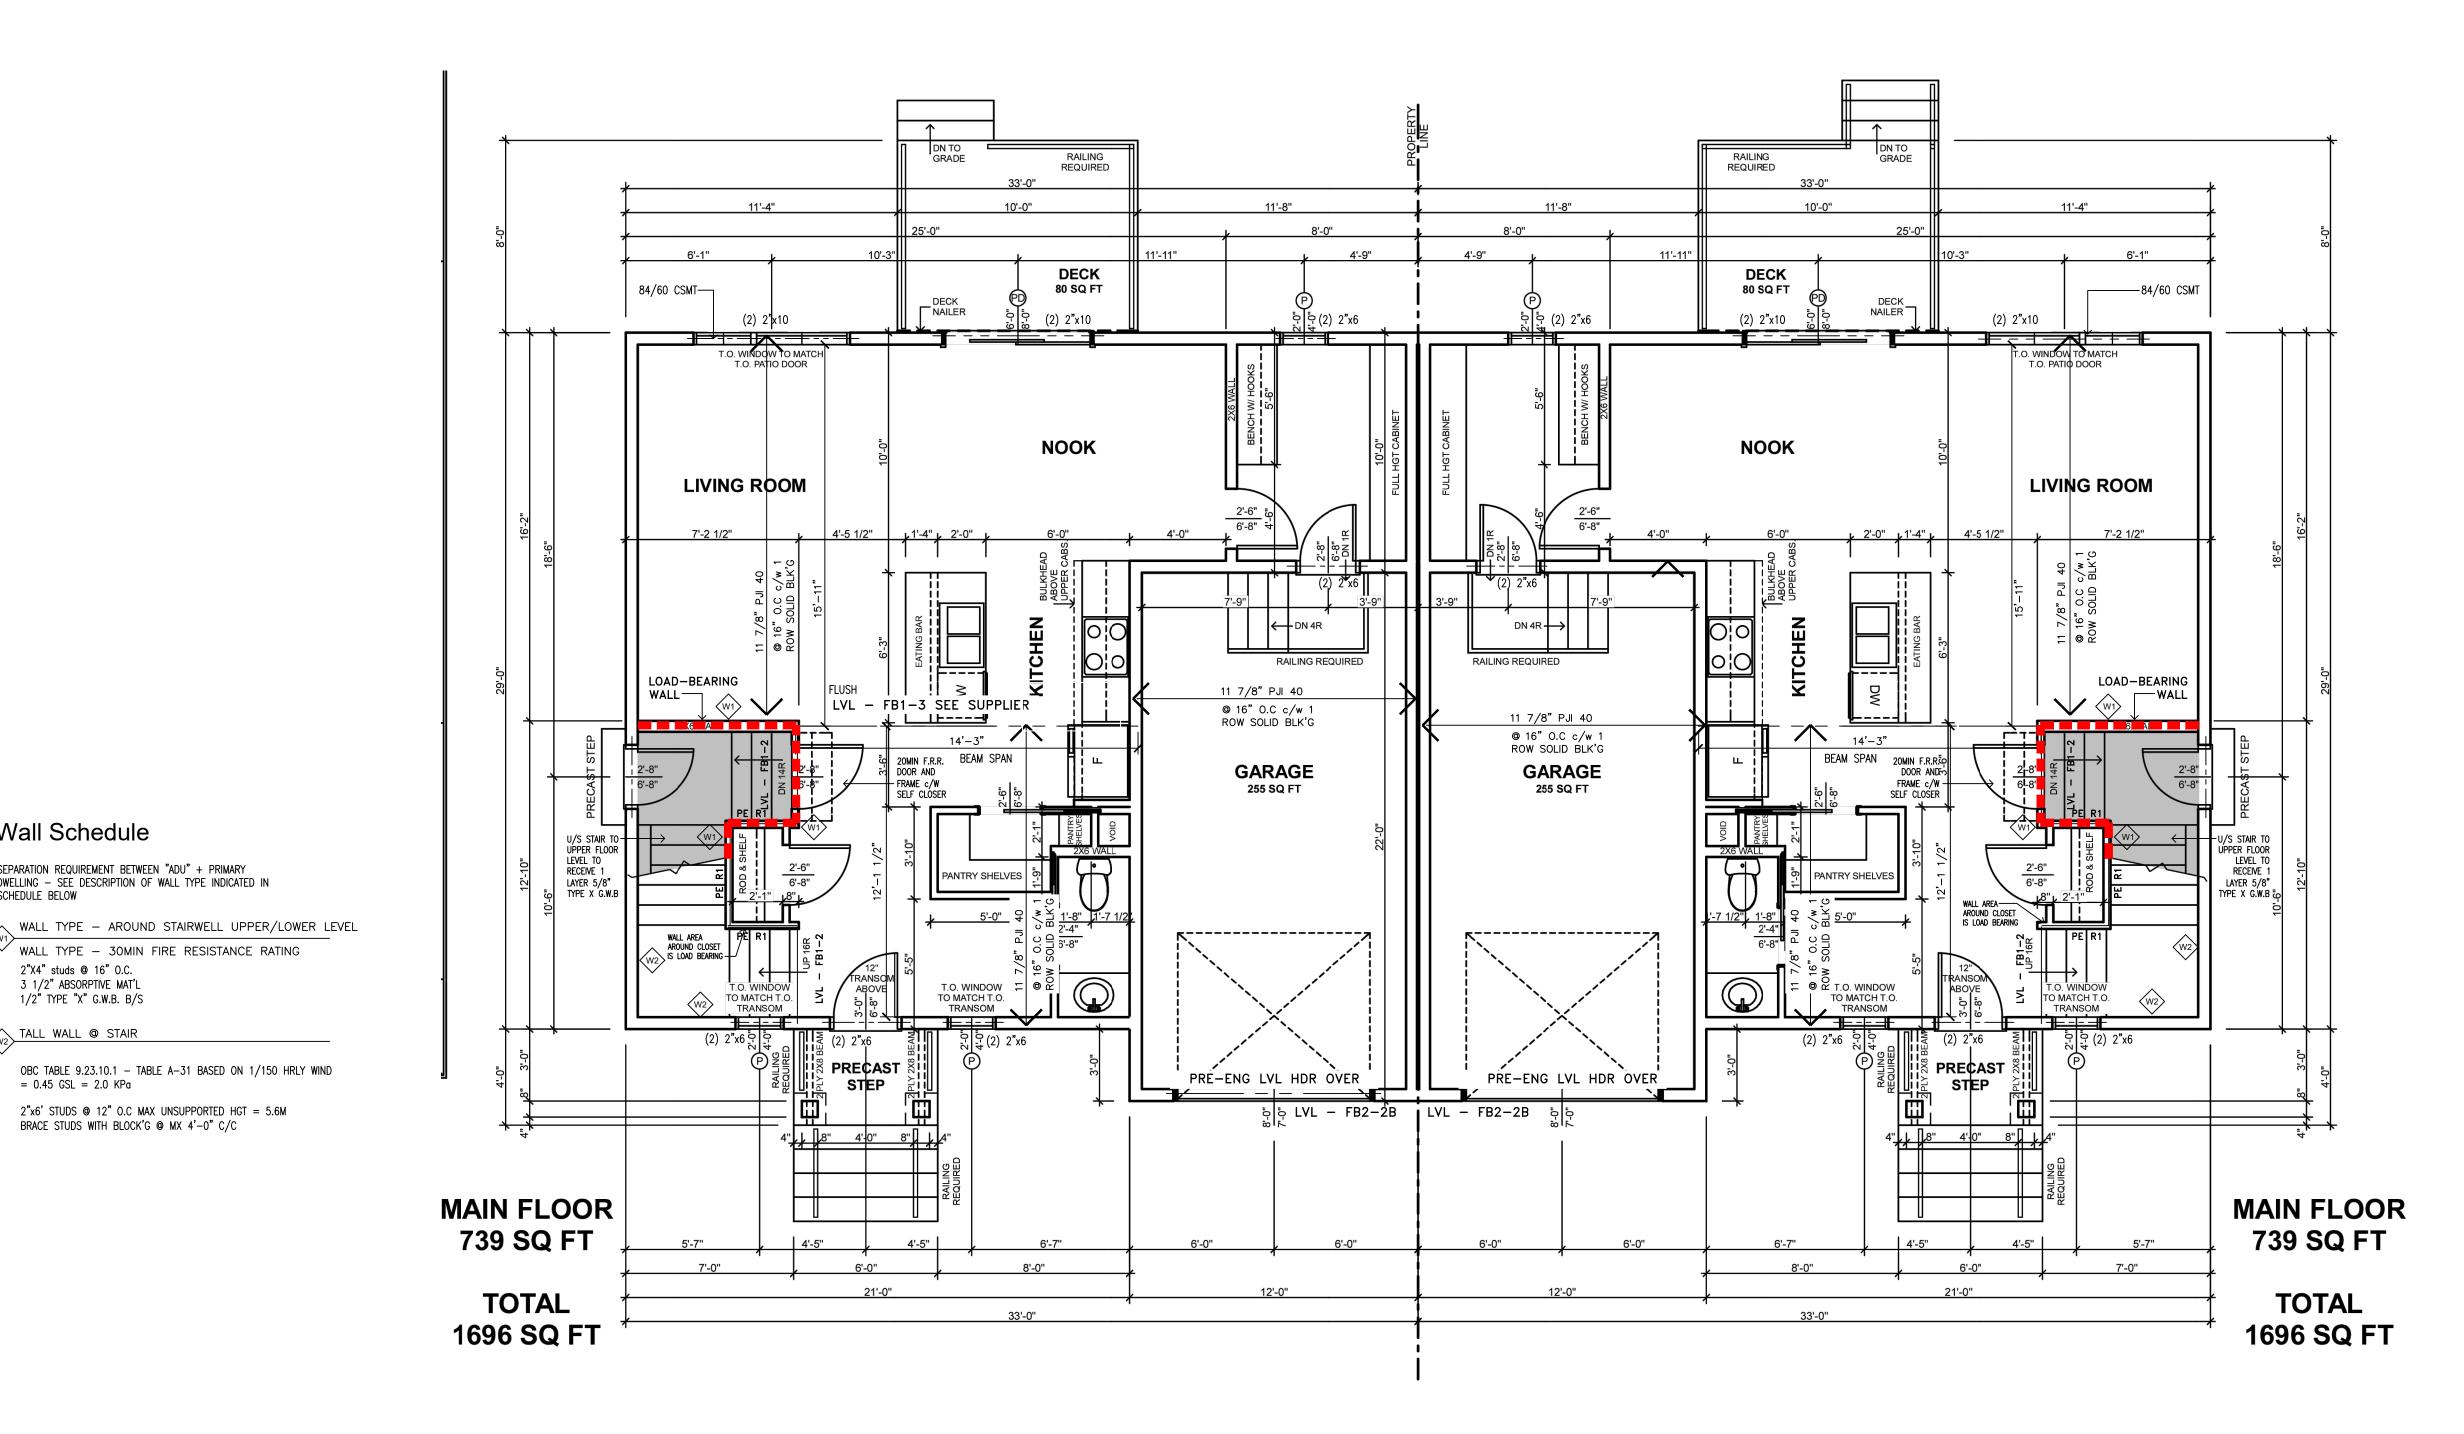



739.0 SF

PROVIDE NECESSARY IN WALL SOLID BLOCKING IN BATHROOMS TO ACCEPT FUTURE GRAB BARS AND MOBILITY ASSISTANT FIXURES

Wall Schedule

2"X4" studs @ 16" O.C. 3 1/2" ABSORPTIVE MAT'L 1/2" TYPE "X" G.W.B. B/S

= 0.45 GSL = 2.0 KPa

TALL WALL @ STAIR

SEPARATION REQUIREMENT BETWEEN "ADU" + PRIMARY DWELLING - SEE DESCRIPTION OF WALL TYPE INDICATED IN SCHEDULE BELOW

WALL TYPE - 30MIN FIRE RESISTANCE RATING

OBC TABLE 9.23.10.1 - TABLE A-31 BASED ON 1/150 HRLY WIND

2"x6' STUDS @ 12" O.C MAX UNSUPPORTED HGT = 5.6M BRACE STUDS WITH BLOCK'G @ MX 4'-0" C/C

	Forming Part of Sentence			C-1 4	Calarra 5
tem	Column 1 Stair Type	Column 2 Max. Rise, mm,	Column 3 Min. Rise, mm,	Column 4 Max. <i>Run</i> , mm,	Column 5 Min. Run, mm,
	2) [0	for All Steps	for All Steps	for Rectangular Treads	for Rectangular Treads
	Private stairs ⁽¹⁾	200	125	355	255
	Public stairs ⁽²⁾	180	125	no limit	280
	Service stairs ⁽³⁾	no limit	125	355	no limit
	Stairs to unoccupied attic space ⁽⁴⁾	no limit	125	355	no limit
	Stairs to crawl spaces	no limit	125	355	no limit
	Stairs that serve <i>mezzanines</i> not exceeding 20 m ² within <i>live/work units</i>	no limit	125	355	no limit
tes to	Table 9.8.4.1.:				
Priva	te stairs are:				
(a) i	nterior stairs within a <i>house</i> or an individual <i>dwelling</i>	unit			
(a) I	menor stans within a nouse of an individual awening	unu,			
(1)	xterior stairs serving a house or an individual dwelling	ig unit, and			
(b) e					

7859 MULHERN







drawing

Main Floor Plan

disclaimer

do not scale drawings, verify all dimensions and information prior to construction report any errors and/or descrepancies to the maker of these plans immediately. All construction must meet or exceed all applicable current building codes including all revisions. Contractor shall be responsible for proceeding with work not fully checked or verified on site to ensure intent of the drawings are fully adhered to in regards to the basic design intent.

copyright


all designs are the sole property of "andrew allen hellwig design consultants inc." reproduction, copying of this document shall not be considered in any way unless permission is granted by "andrew allen hellwig" (Designer)


date of issues and revisions A- ISSUED FOR BUILDING PERMIT 2023-08-25 AAH

drawing no. drawn

A2.01 reviewed

2023-70 plot A

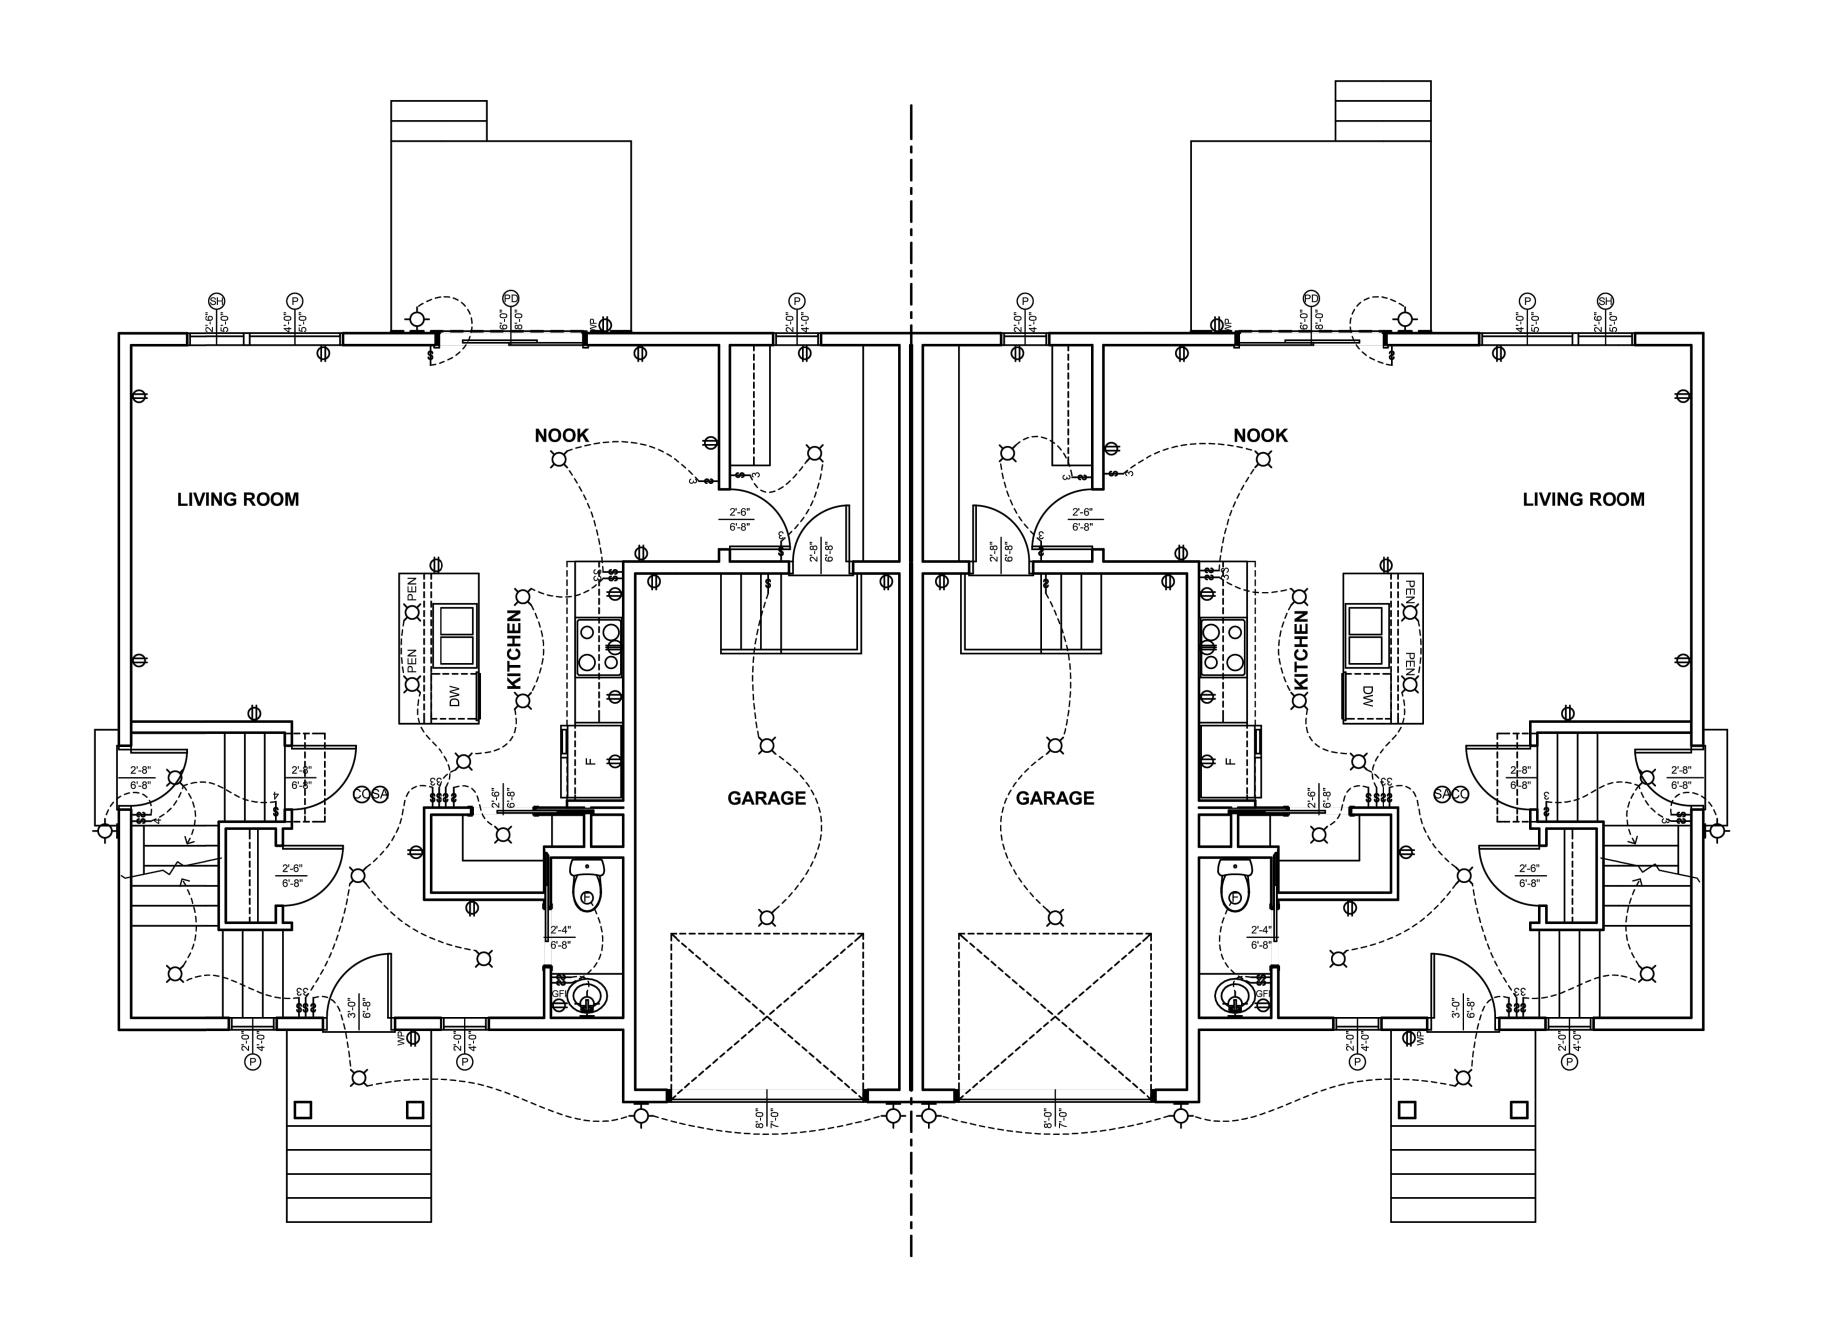

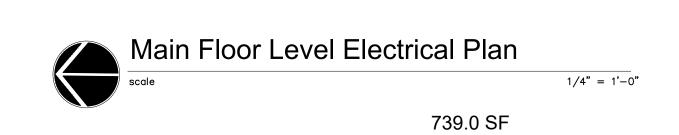







drawing

Main Floor Plan Electrical Layout

disclaimer

do not scale drawings, verify all dimensions and information prior to construction report any errors and/or descrepancies to the maker of these plans immediately. All construction must meet or exceed all applicable current building codes including all revisions. Contractor shall be responsible for proceeding with work not fully checked or verified on site to ensure intent of the drawings are fully adhered to in regards to the basic design intent.

copyright

all designs are the sole property of "andrew allen hellwig design consultants inc." reproduction, copying of this document shall not be considered in any way unless permission is granted by "andrew allen hellwig" (Designer)

date of issues and revisions

A- ISSUED FOR BUILDING PERMIT 2023-08-25 AAH


drawn

drawing no.

reviewed

A2.01E

 $_{\mathsf{plot}}$ A

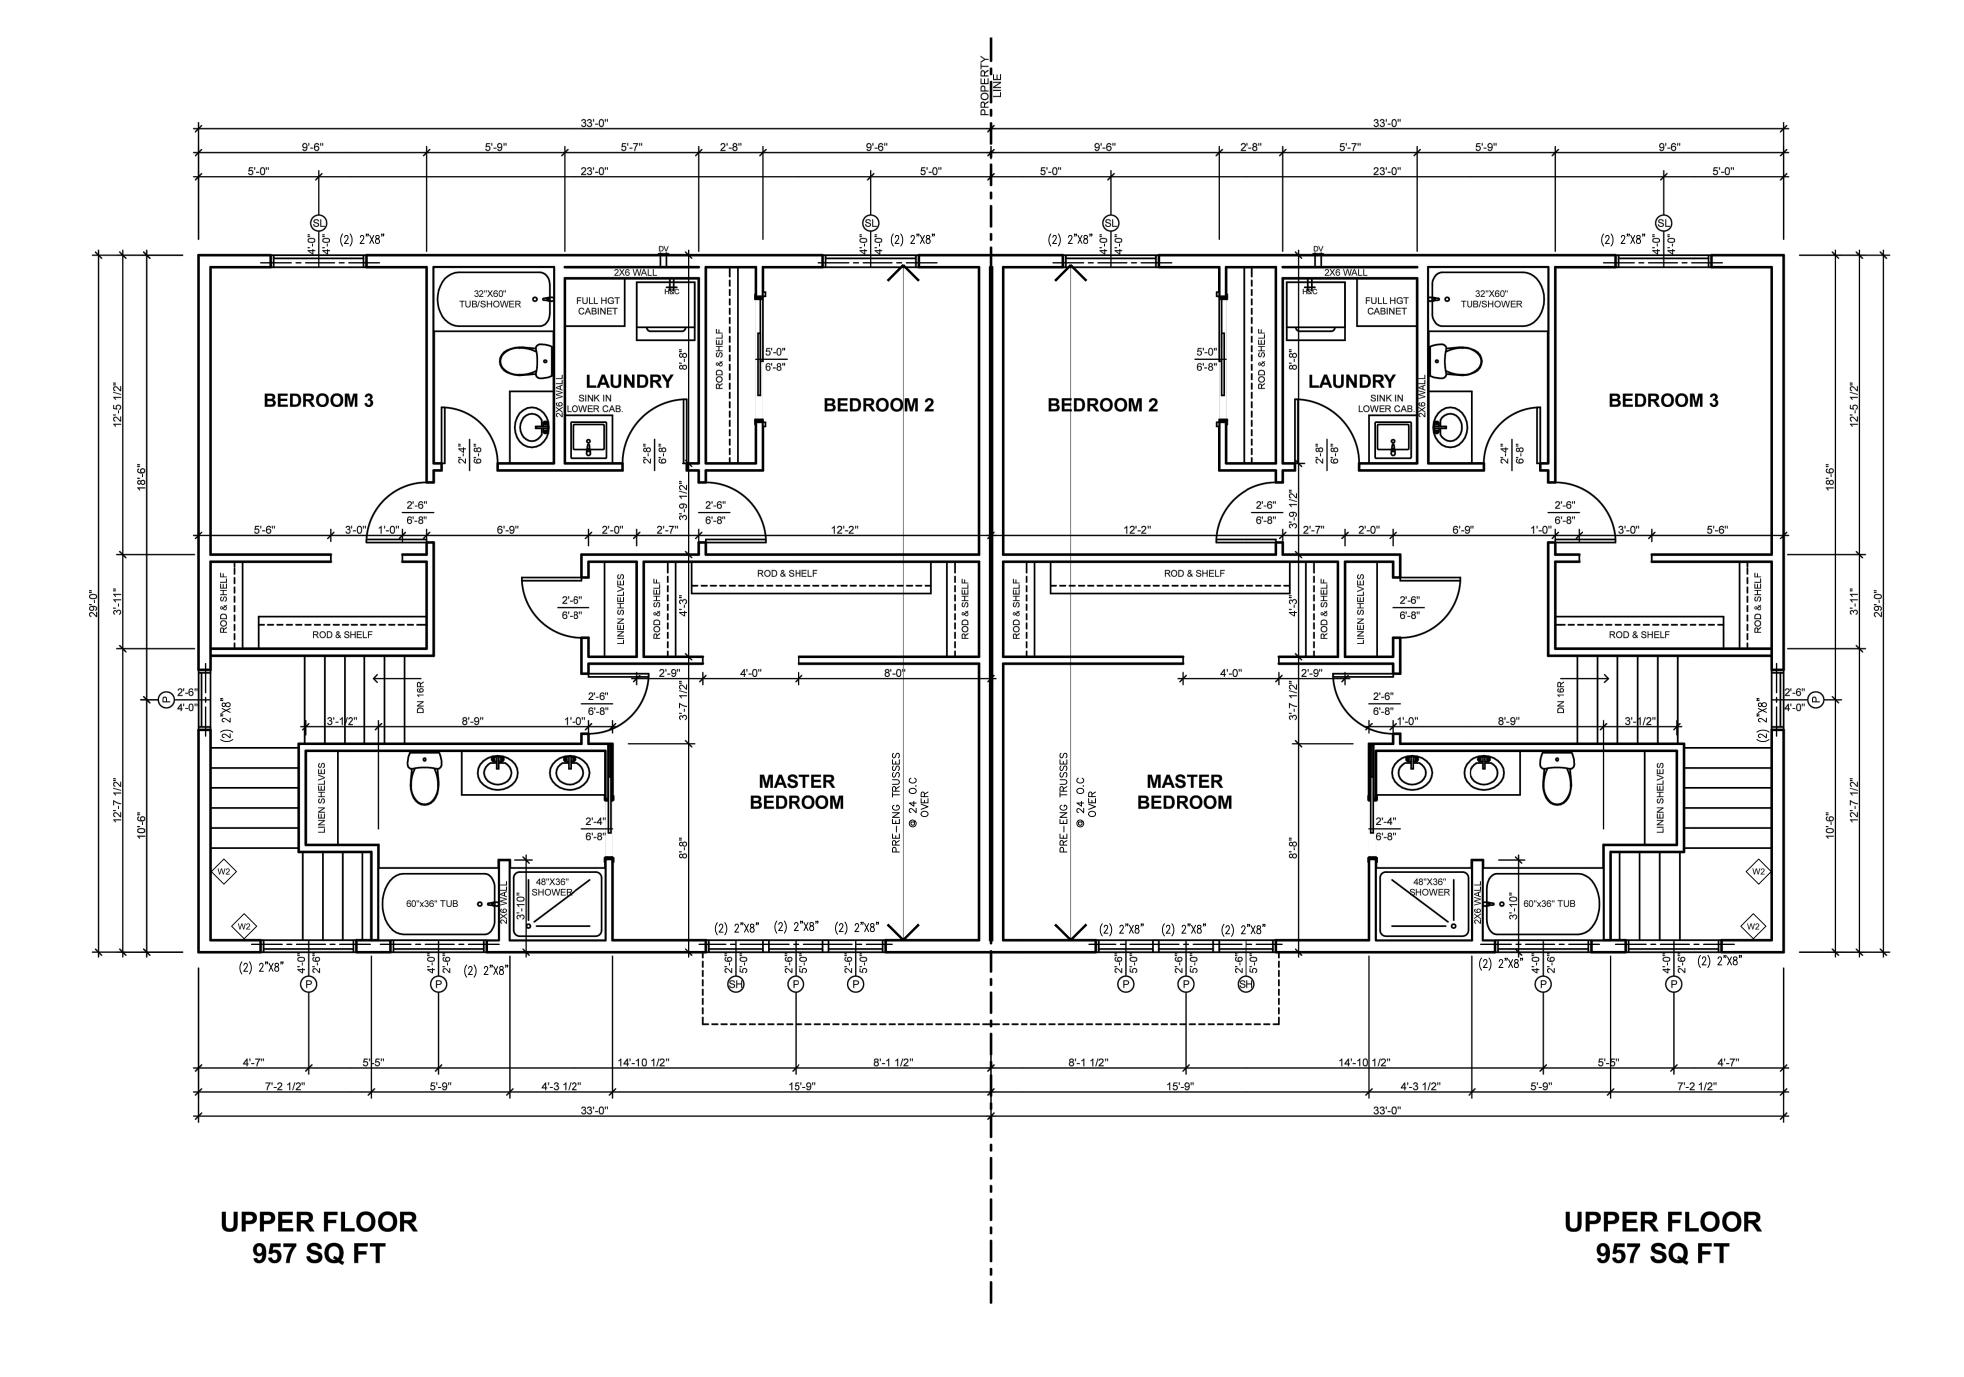

OBC TABLE 9.23.10.1 - TABLE A-31 BASED ON 1/150 HRLY WIND = 0.45 GSL = 2.0 KPa

W2 TALL WALL @ STAIR

2"x6' STUDS @ 12" O.C MAX UNSUPPORTED HGT = 5.6M BRACE STUDS WITH BLOCK'G @ MX 4'-0" C/C



	Tabl Rise for Rectangular Treads, Tapered Tread	le 9.8.4.1. Is and Winders	and Run for R	ectangular Trea	ads
Item	Forming Part of Sentence Column 1 Stair Type	ces 9.8.4.1.(1) an Column 2 Max. Rise, mm, for All Steps	Column 3	Column 4 Max. <i>Run</i> , mm, for Rectangular Treads	Column 5 Min. Run, mm, for Rectangular Treads
1. 2.	Private stairs ⁽¹⁾ Public stairs ⁽²⁾	200 180	125 125	355 no limit	255 280
3. 4.	Service stairs ⁽³⁾ Stairs to unoccupied attic space ⁽⁴⁾	no limit no limit	125 125	355 355	no limit no limit
5. 6.	Stairs to crawl spaces Stairs that serve <i>mezzanines</i> not exceeding 20 m ² within <i>live/work units</i>	no limit no limit	125 125	355 355	no limit no limit
lotes to	Table 9.8.4.1.:				
1) Priva	ate stairs are:				
(a) i	nterior stairs within a house or an individual dwelling	unit,			
(b) 6	exterior stairs serving a house or an individual dwellin	ng unit, and			
(c) (exterior stairs serving a garage that serves a house or	an individual dw	elling unit		

7859 MULHERN







drawing

Upper Floor Plan

disclaimer

do not scale drawings, verify all dimensions and information prior to construction report any errors and/or descrepancies to the maker of these plans immediately. All construction must meet or exceed all applicable current building codes including all revisions. Contractor shall be responsible for proceeding with work not fully checked or verified on site to ensure intent of the drawings are fully adhered to in regards to the basic design intent.

copyright

all designs are the sole property of "andrew allen hellwig design consultants inc." reproduction, copying of this document shall not be considered in any way unless permission is granted by "andrew allen hellwig" (Designer)

date of issues and revisions

A- ISSUED FOR BUILDING PERMIT 2023-08-25 AAH


drawn


reviewed

drawing no.

A2.02

plot A2023-70

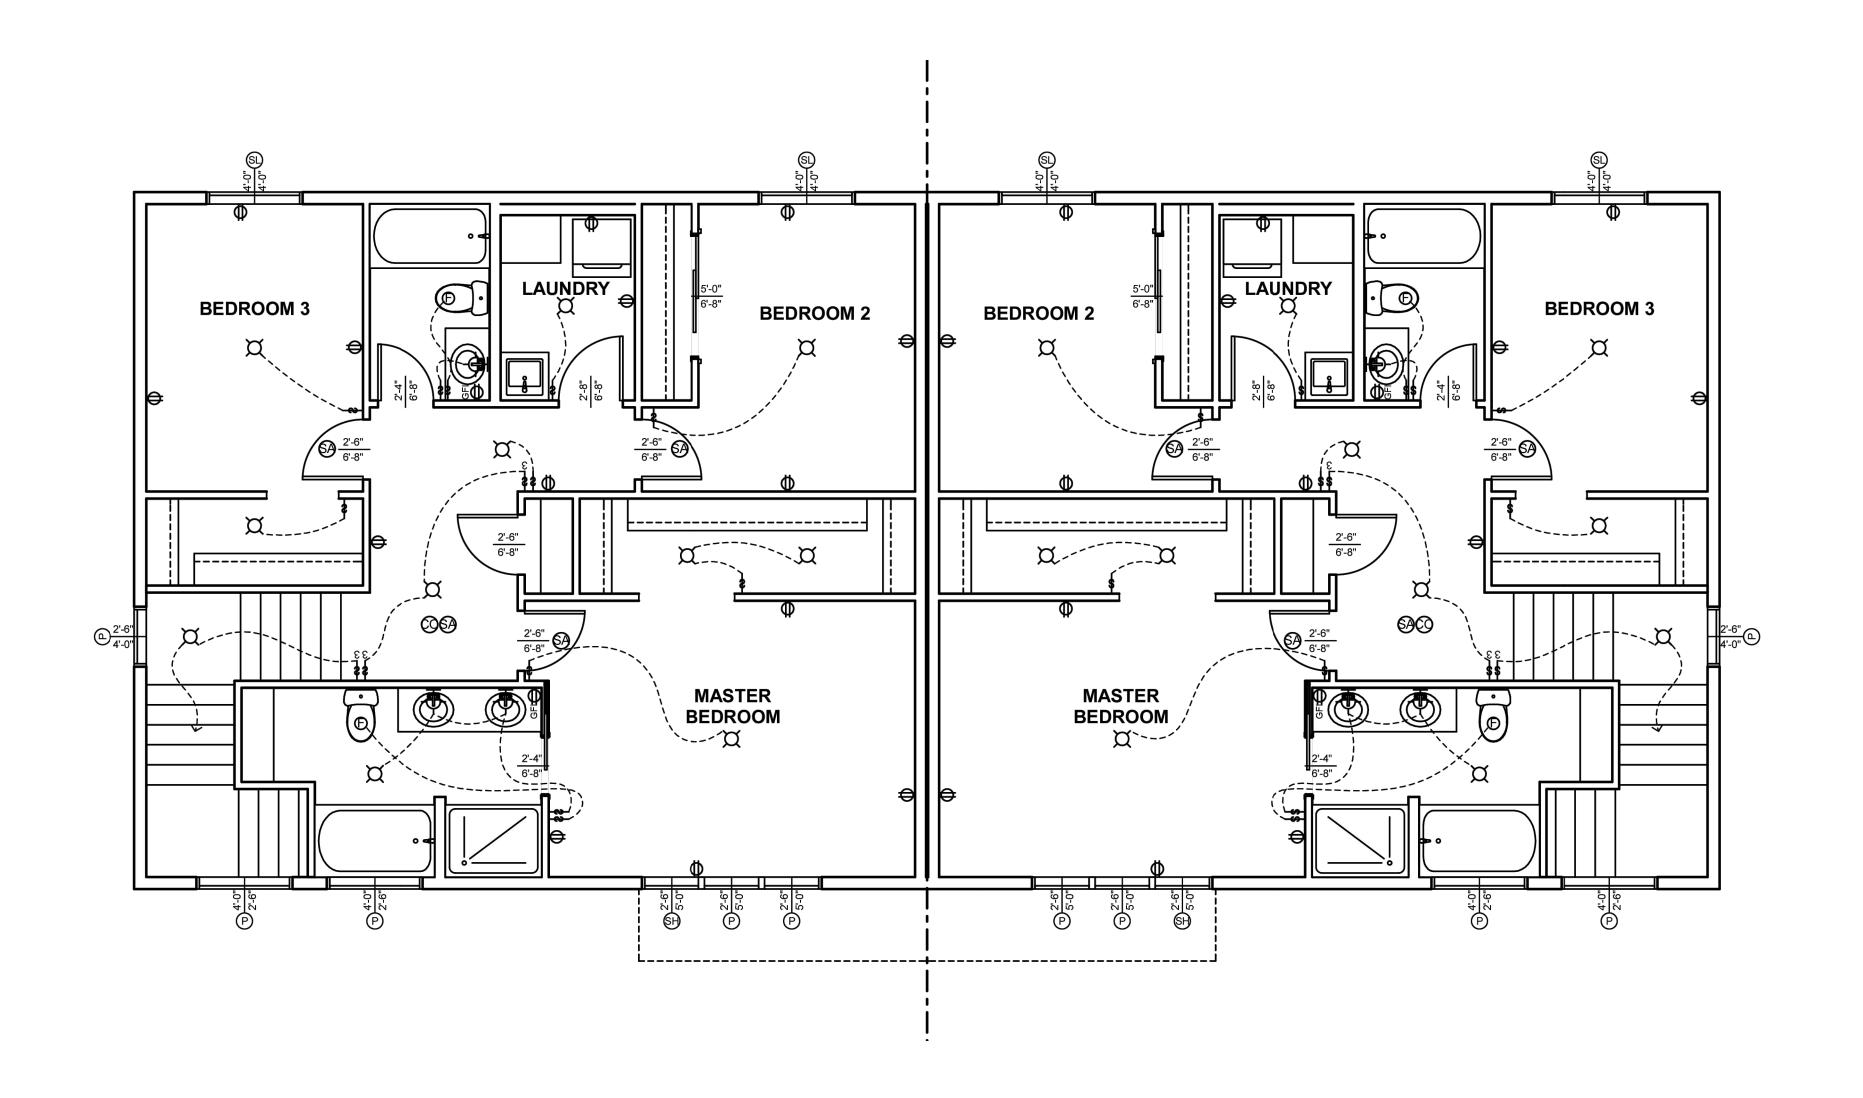

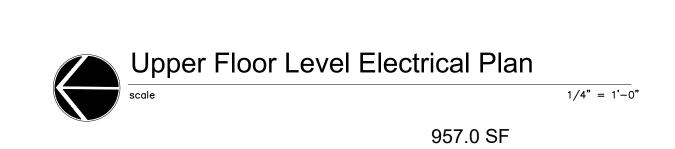



consultant

no





drawing

Upper Floor Plan electrical Layout

disclaimer

do not scale drawings, verify all dimensions and information prior to construction report any errors and/or descrepancies to the maker of these plans immediately. All construction must meet or exceed all applicable current building codes including all revisions. Contractor shall be responsible for proceeding with work not fully checked or verified on site to ensure intent of the drawings are fully adhered to in regards to the basic design intent.

copyright

all designs are the sole property of "andrew allen hellwig design consultants inc." reproduction, copying of this document shall not be considered in any way unless permission is granted by "andrew allen hellwig" (Designer)

date of issues and revisions

A- ISSUED FOR BUILDING PERMIT 2023-08-25 AAH


drawn


drawing no.

reviewed

A2.02E

plot A

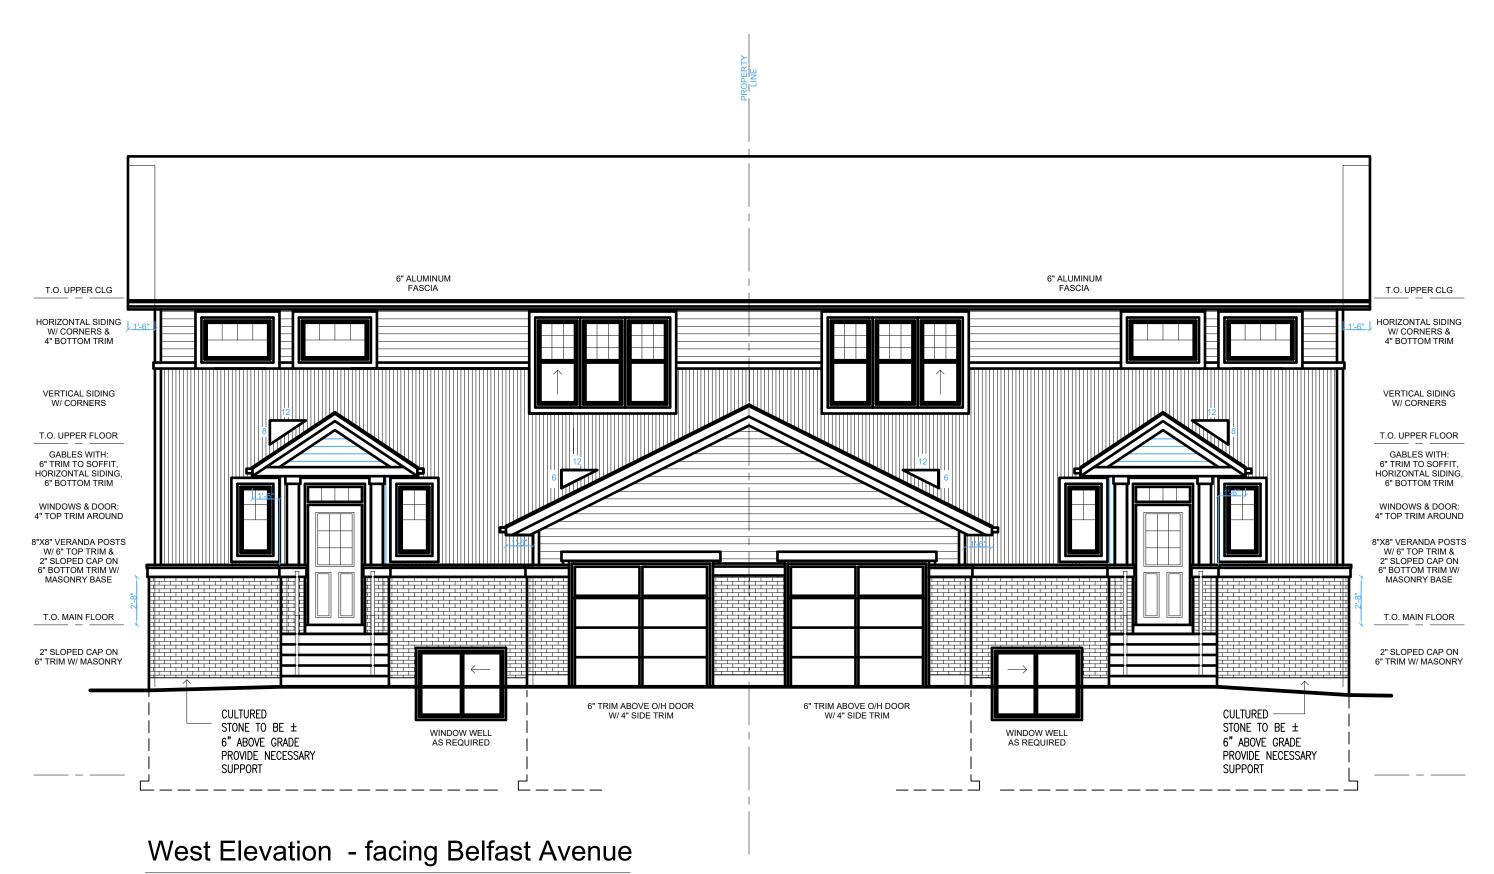


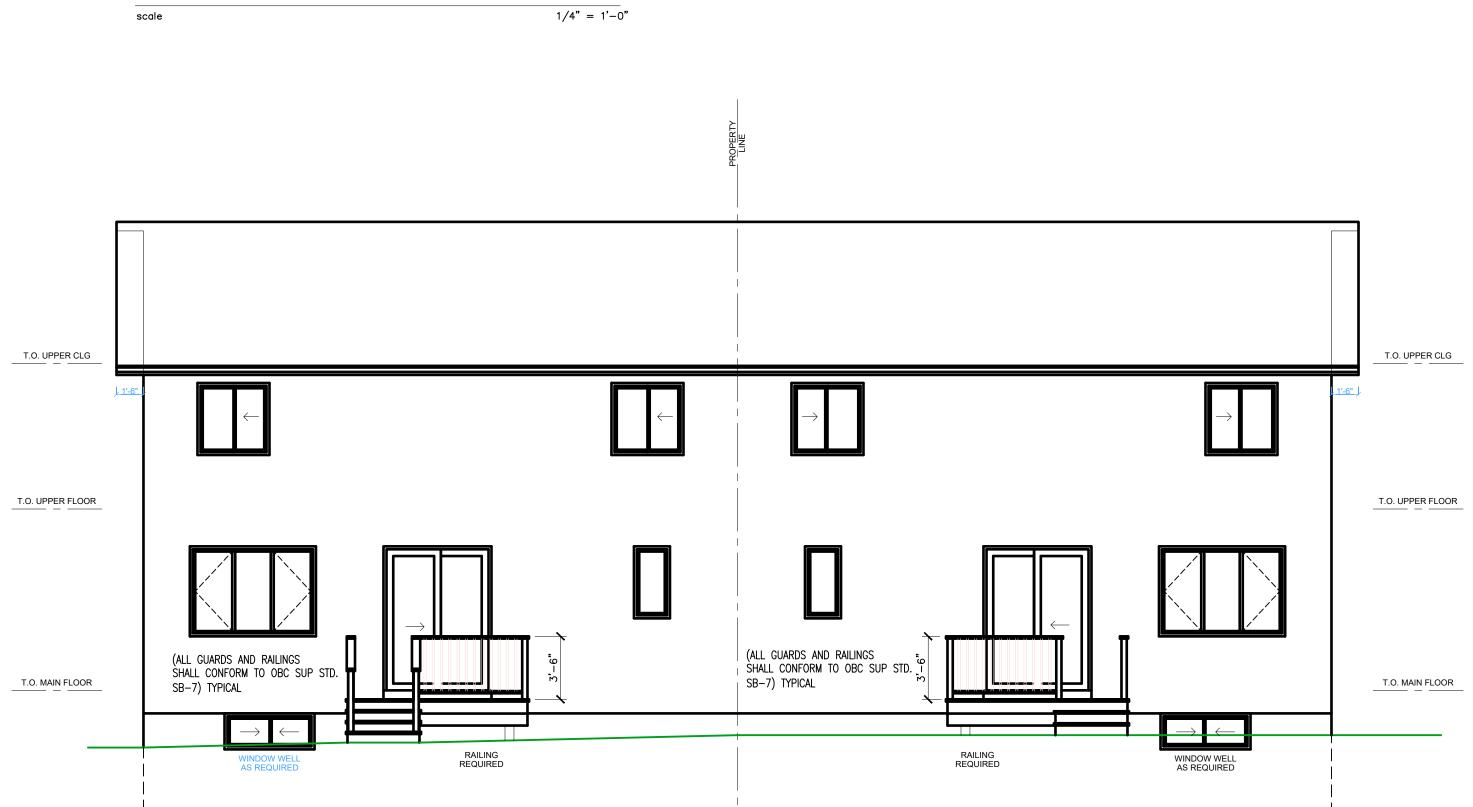

L-----


East Elevation - facing Rear Yard

1/4" = 1'-0"

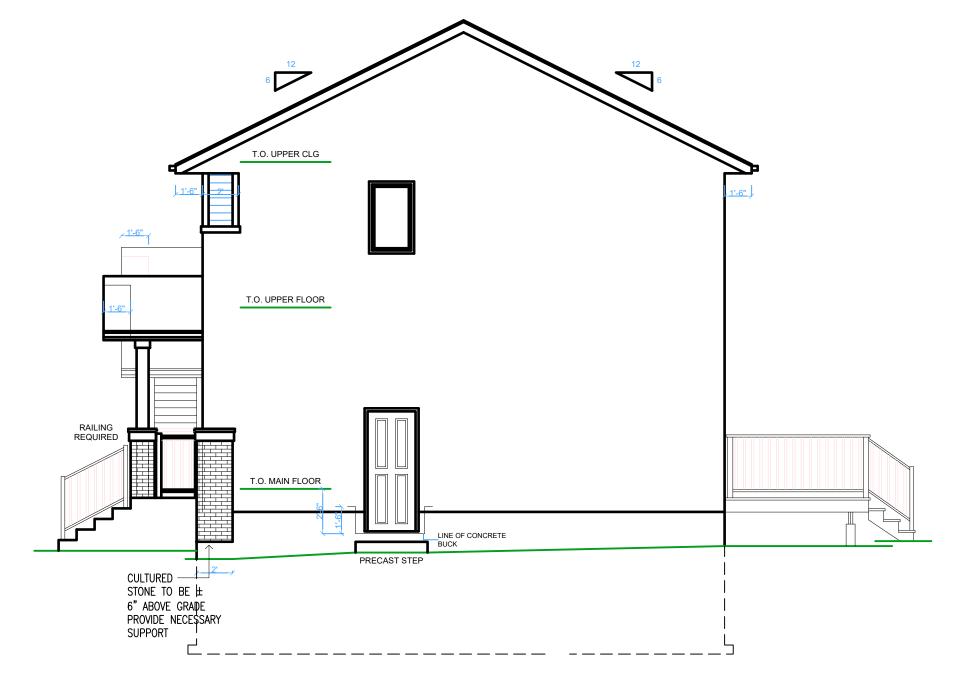

South Elevation - facing Mulhern

| Scale | 1/4" = 1'-0"

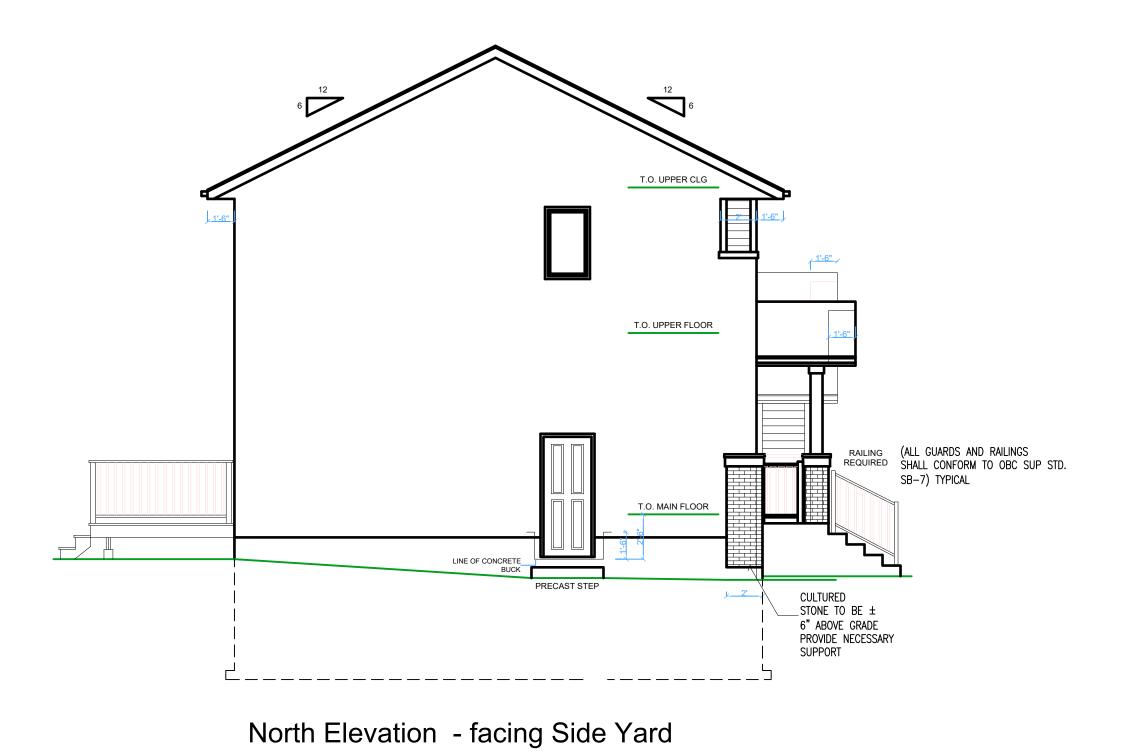

1/4" = 1'-0"

7859 MULHERN





design, and has the qua	eviewed and takes responsit alifications and meets the re ng Code to be a designer.	
QUALIFIC	ATION INFORMAT	TION
Required unless design the Building Code	is exempt under Div. C, Art	icle 3.2.5.1 of
ANDREW HELLWIG	7400	1877
NAME	SIGNATURE	BCI
REGISTR	ATION INFORMAT	ION
Required unless design the Building Code	is exempt under Div. C, Art	icle 3.2.4.1 of
Andrew Allen Hellwig D	esign Consultants Inc.	11435
FIRM NAME		BCI

drawing

Elevations

disclaimer
do not scale drawings, verify all dimensions and information prior to construction report any errors ar descrepancies to the maker of these plans immediately . All construction must meet or exceed all
applicable current building codes including all revisions. Contractor shall be responsible for proceed

copyright


all designs are the sole property of "andrew allen hellwig design consultants inc." reproduction, copying of this document shall not be considered in any way unless permission is granted by "andrew allen hellwig" (Designer)

date of issues and revisions

A- ISSUED FOR BUILDING PERMIT 2023-08-25 AAH

drawn drawing no.
reviewed A3.01

plot A 2023-70

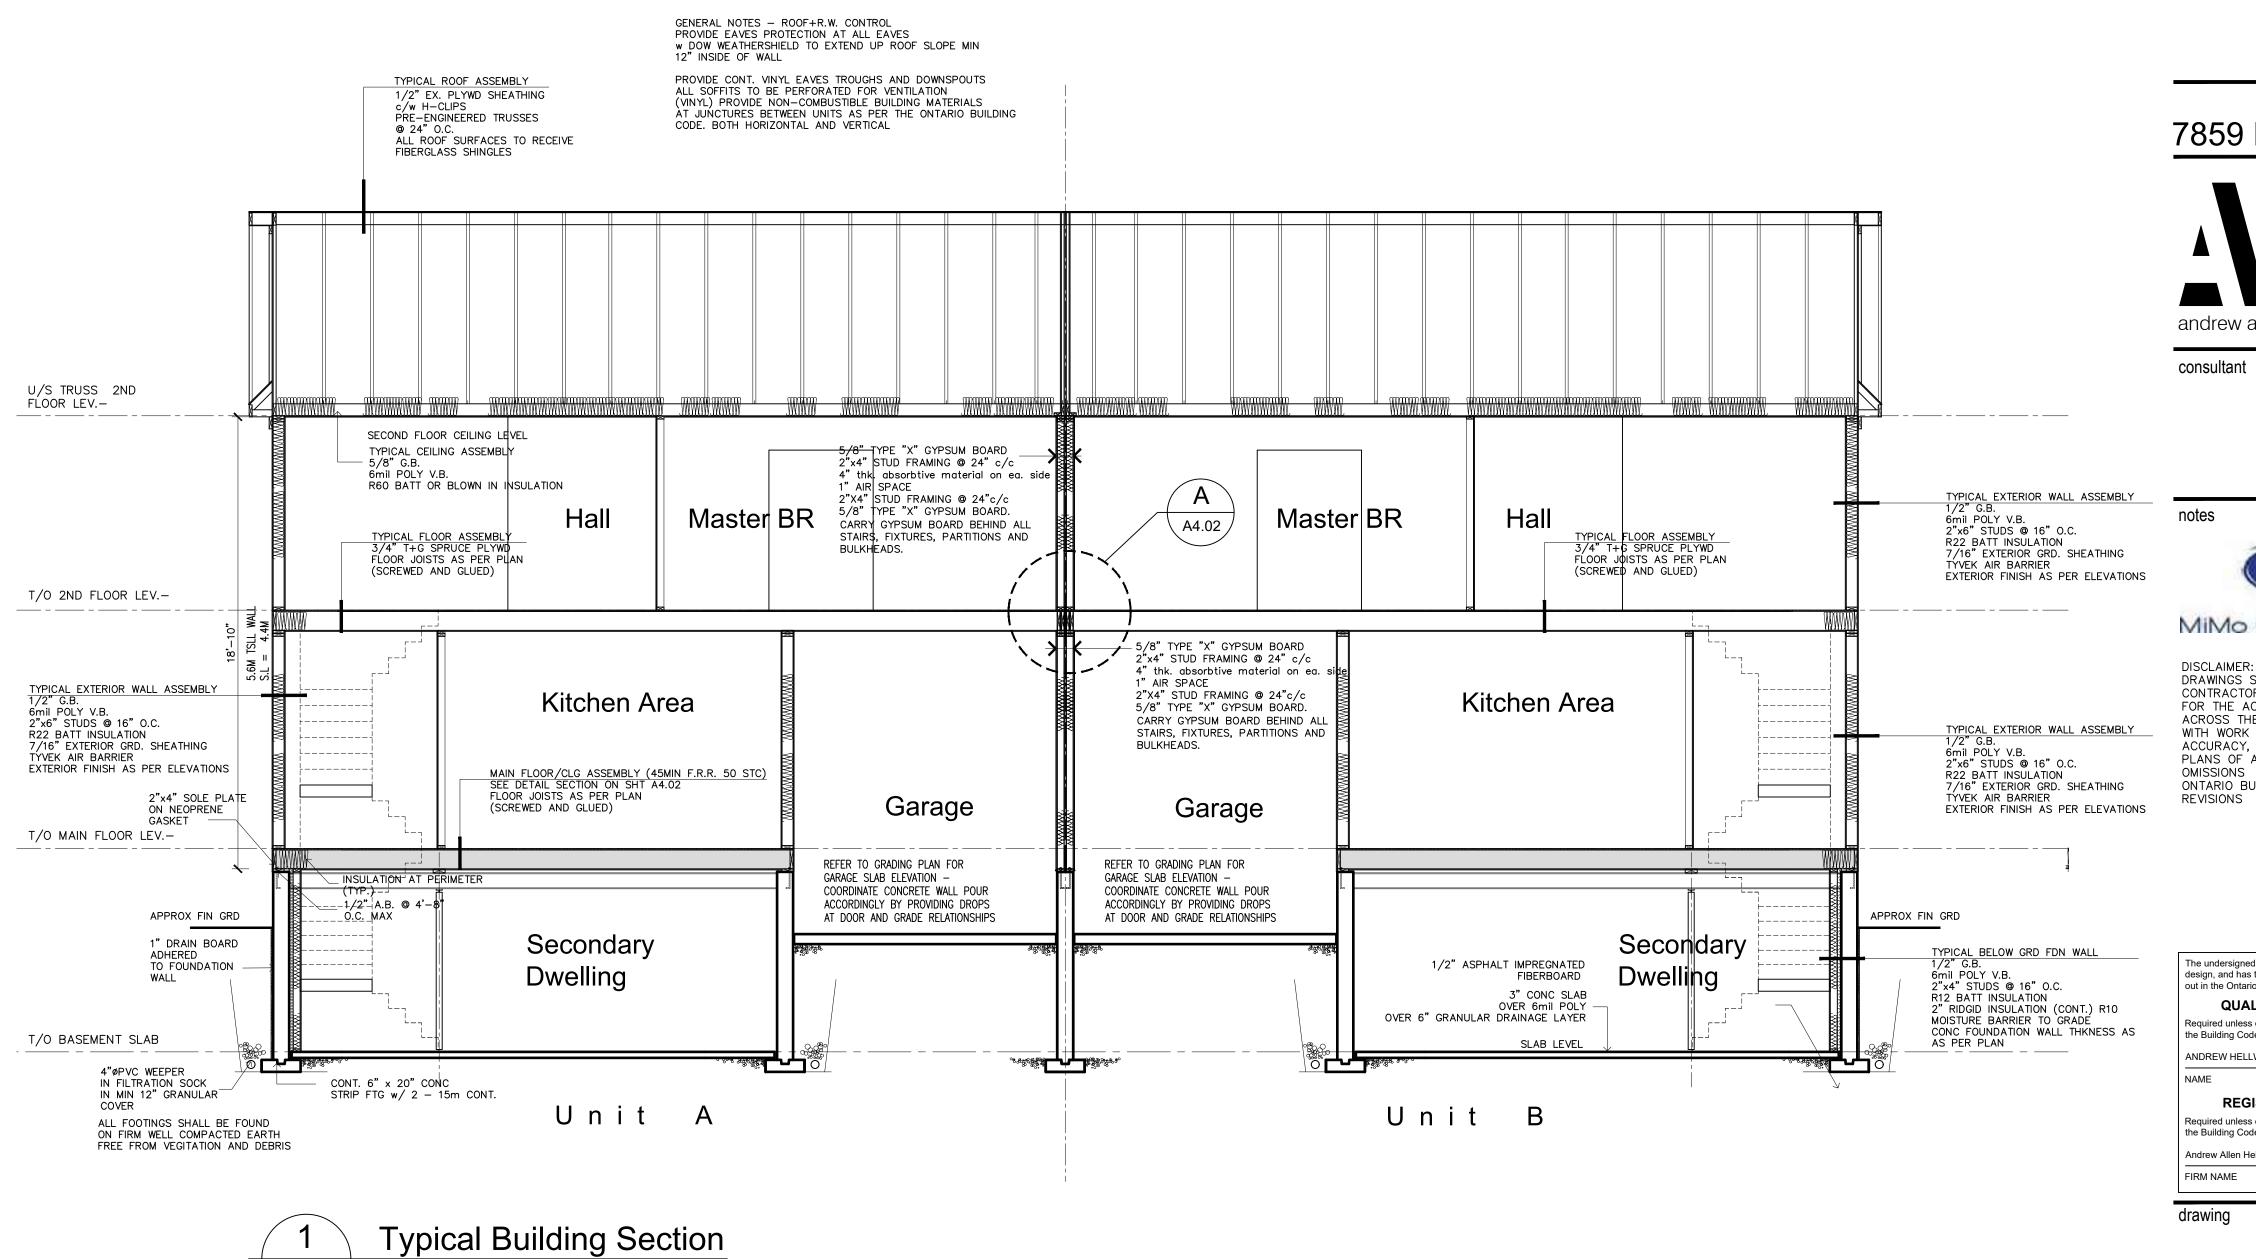

andrew allen hellwig | design inc



DISCLAIMER: DRAWINGS SHALL NOT BE SCALED CONTRACTOR SHALL BE RESPONSIBLE FOR THE ACCURACY AND COORDINATION ACROSS THE TRADES. DO NOT PROCEED WITH WORK THAT MAY BE QUESTIONED FOR ACCURACY, INFORM THE MAKER OF THESE PLANS OF ANY ERRORS INCONSISTENCIES OR OMISSIONS ALL WORK MUST CONFORM TO THE ONTARIO BUILDING CODE LATEST EDITIONS AND



drawing

Building Details

disclaimer

do not scale drawings, verify all dimensions and information prior to construction report any errors and/or descrepancies to the maker of these plans immediately. All construction must meet or exceed all applicable current building codes including all revisions. Contractor shall be responsible for proceeding with work not fully checked or verified on site to ensure intent of the drawings are fully adhered to in regards to the basic design intent.

copyright

all designs are the sole property of "andrew allen hellwig design consultants inc." reproduction, copying of this document shall not be considered in any way unless permission is granted by "andrew allen hellwig" (Designer)


date of issues and revisions


A- ISSUED FOR BUILDING PERMIT 2023-08-25 AAH


drawing no. drawn

A4.01 reviewed


2023-70 plot A

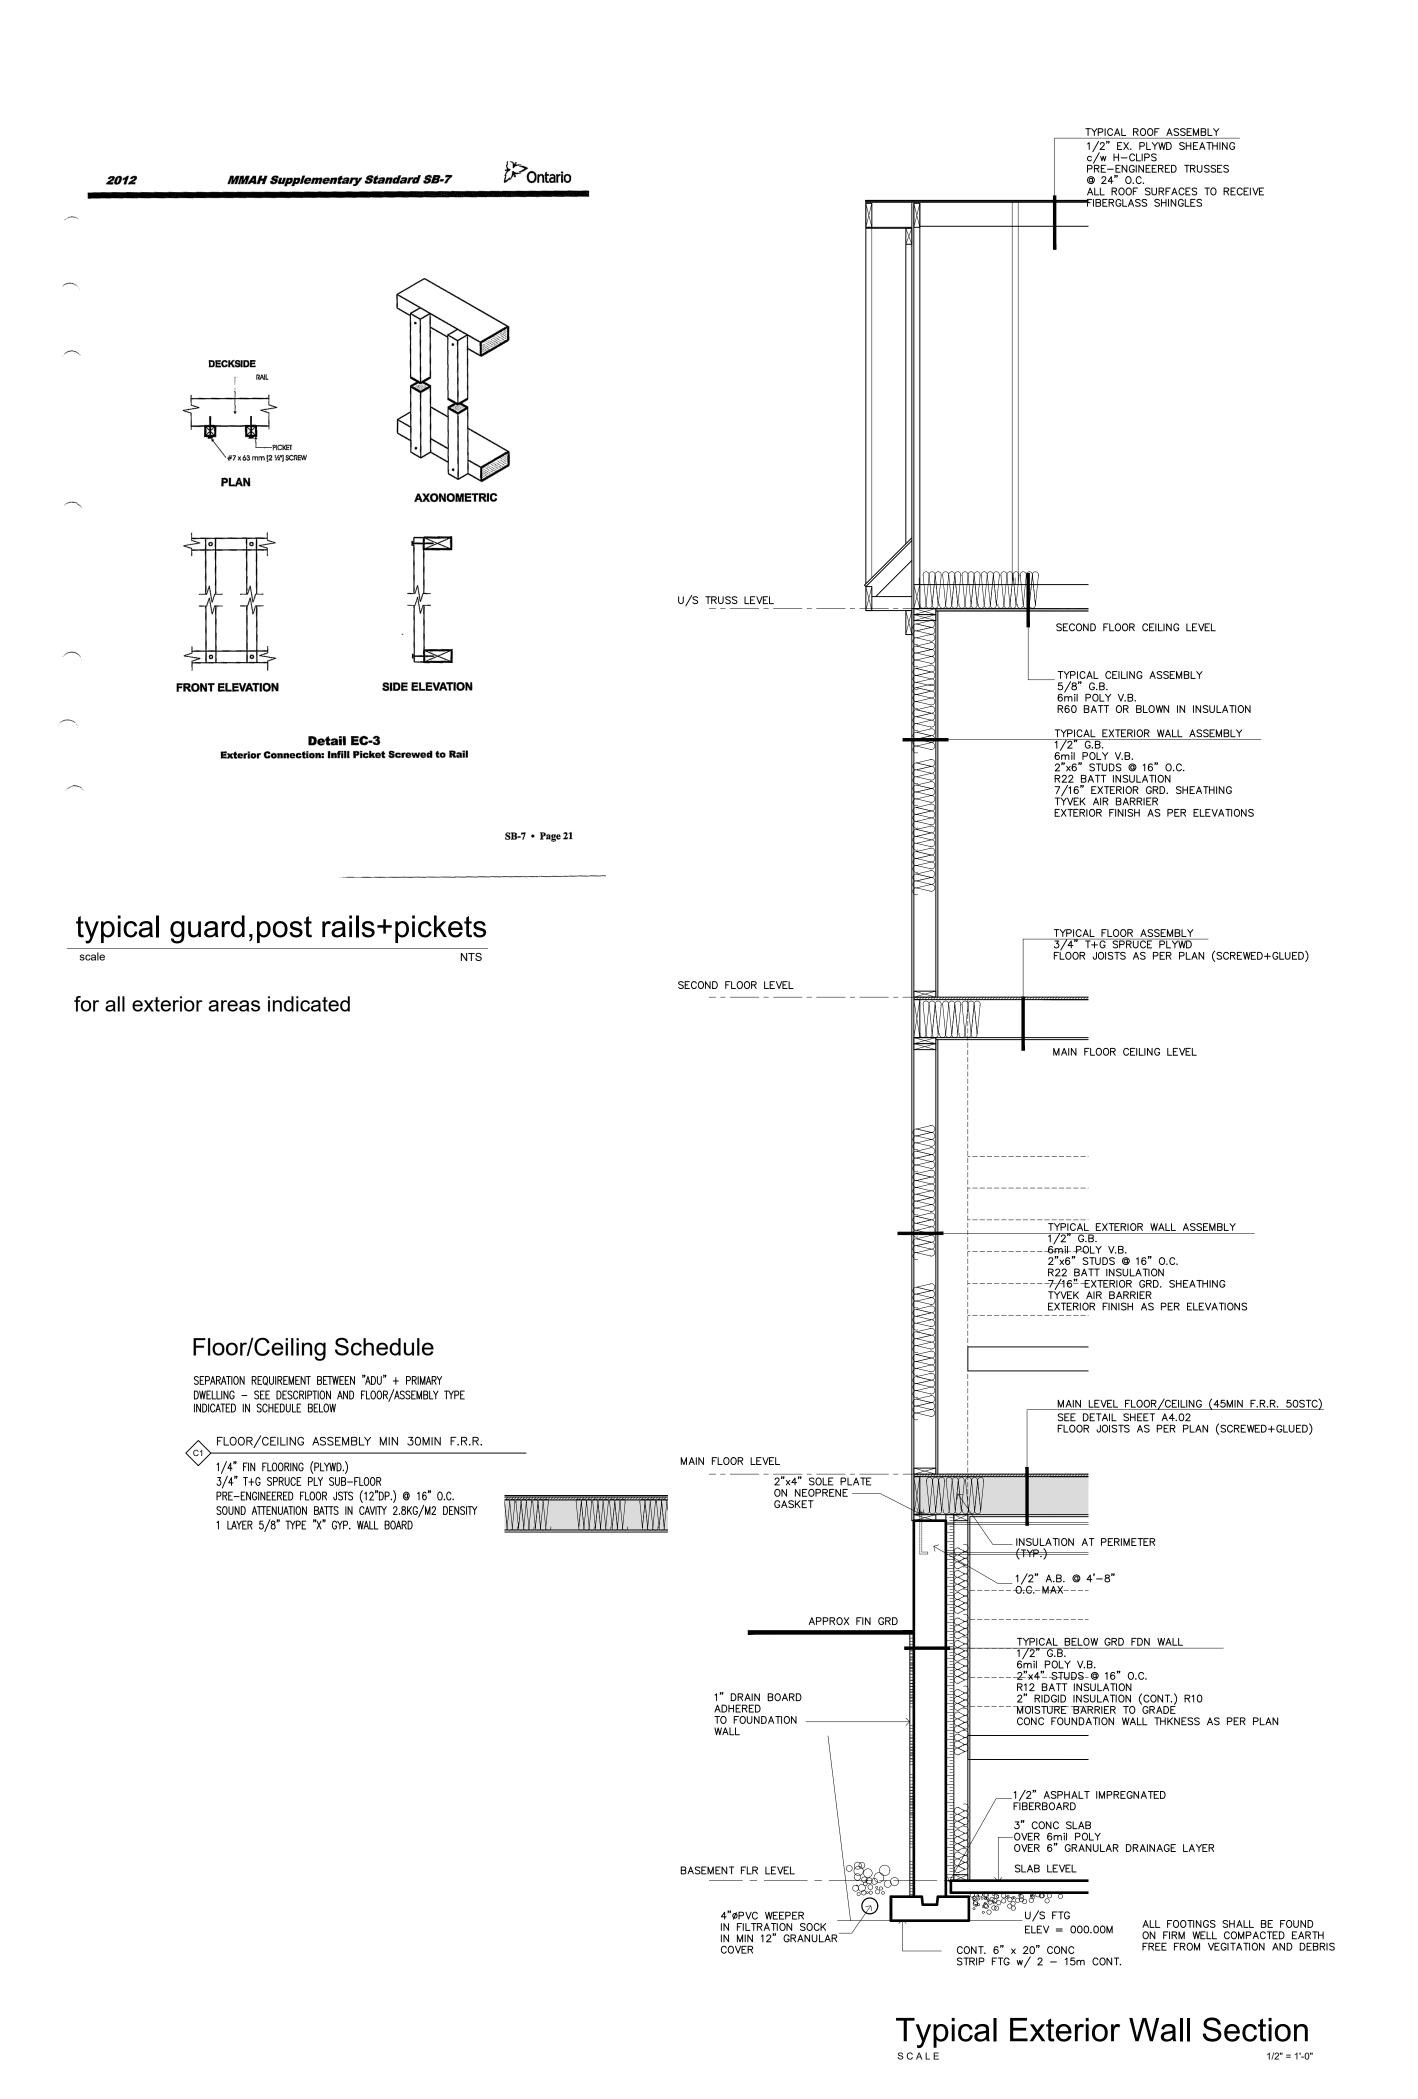

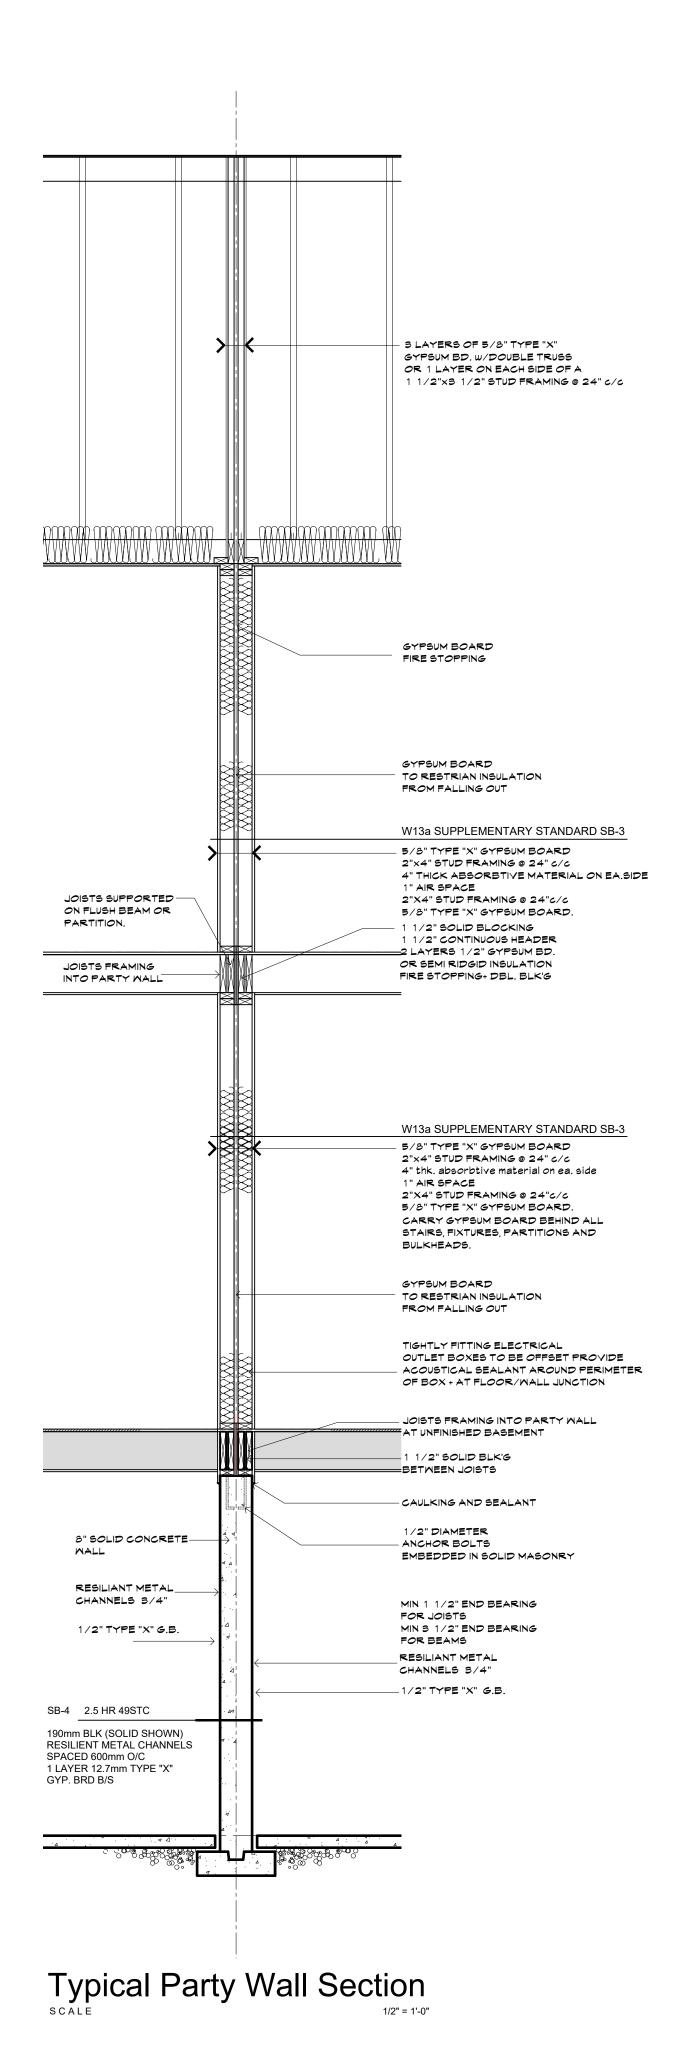

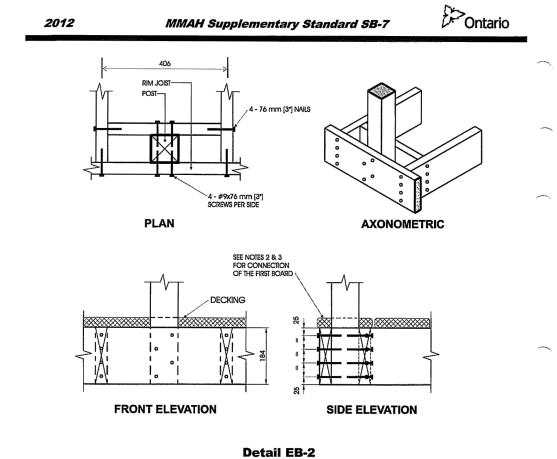

Notes:				
 Decking is omitted from the plan view and the axonometric view for 	r clarity.			
 Fasten 25 mm x 140 mm (5½" x 6" nominal) outer deck board to rim joist with 63 mm (2½") nails at 300 mm (12"). Fasten 25 mm x 140 mm (5½" x 6" nominal) outer deck board to floor joist with 1 - 63 mm (2½") nail at each joist. 				
				. The post may be positioned anywhere between the joists.
#9 screws may be replaced by #8 screws if the maximum spacing	between posts is not more than 1.20 m (3'-11").			
 Dimensions shown are in mm unless otherwise specified. 	, ,			
. Dinibilation another are in this unicas outerwise specified.				
Dimonolosio anomirale il trimi anicos calestrise openica.				
MAXIMUM SPAN OF RA	AIL BETWEEN POSTS			
	AIL BETWEEN POSTS Maximum Span, m (ft-in)			
MAXIMUM SPAN OF RA				
MAXIMUM SPAN OF RA	Maximum Span, m (ft-in)			

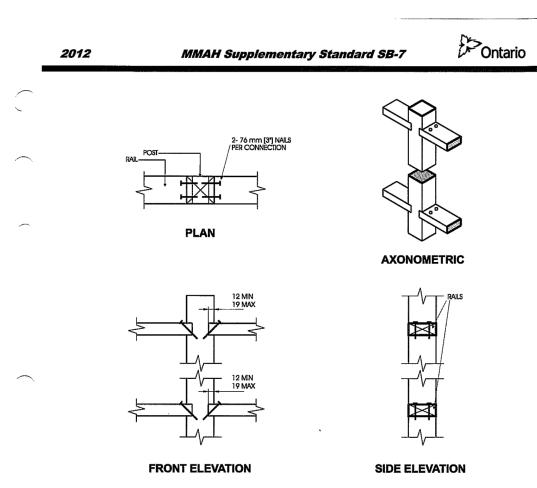

Notes: 1. The maximum span is more often governed by post spacing. 2. Provide support to bottom rail at intervals not more than 2.0 m (6'-7). 3. The bottom rail may be bevelled as detailed in Figure 2.1.2. 4. Dimensions shown are in mm unless otherwise specified.	7").
MAXIMUM SPAN OF RA	IL BETWEEN POSTS
Species	Maximum Span, m (ft-in)
Douglas Fir-Larch, Hem-Fir, Spruce-Pine-Fir	2.72 (8'-11")
Northern Species	2.18 (7'-2")
Column 1	2

typical guard, post rails+pickets

for all exterior areas indicated

7859 MULHERN



consultant

MiMo Construction Inc.

DISCLAIMER: DRAWINGS SHALL NOT BE SCALED CONTRACTOR SHALL BE RESPONSIBLE FOR THE ACCURACY AND COORDINATION ACROSS THE TRADES. DO NOT PROCEED WITH WORK THAT MAY BE QUESTIONED FOR ACCURACY, INFORM THE MAKER OF THESE PLANS OF ANY ERRORS INCONSISTENCIES OR OMISSIONS ALL WORK MUST CONFORM TO THE ONTARIO BUILDING CODE LATEST EDITIONS AND REVISIONS

The undersigned has reviewed and takes responsibility for this design, and has the qualifications and meets the requirements set out in the Ontario Building Code to be a designer.				
QUALIFIC	CATION INFORMA	TION		
Required unless designate Building Code	n is exempt under Div. C, A	rticle 3.2.5.1 of		
ANDREW HELLWIG	AHA	18776		
NAME	SIGNATURE	BCIN		
REGISTR	RATION INFORMA	ΓΙΟΝ		
Required unless designate Building Code	n is exempt under Div. C, A	rticle 3.2.4.1 of		
Andrew Allen Hellwig [Design Consultants Inc.	114357		
•				

drawing

Building Details

disclaimer

do not scale drawings, verify all dimensions and information prior to construction report any errors and/or descrepancies to the maker of these plans immediately. All construction must meet or exceed all applicable current building codes including all revisions. Contractor shall be responsible for proceeding with work not fully checked or verified on site to ensure intent of the drawings are fully adhered to in regards to the basic design intent.

copyright

all designs are the sole property of "andrew allen hellwig design consultants inc." reproduction, copying of this document shall not be considered in any way unless permission is granted by "andrew allen hellwig" (Designer)


date of issues and revisions

A- ISSUED FOR BUILDING PERMIT 2023-08-25 AAH

drawing no. drawn A4.02

2023-70 plot A

reviewed

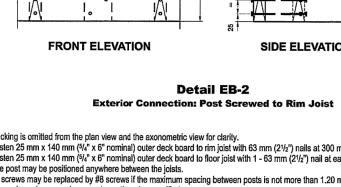

Page 14 • SB-7

