	Sheet List
Sheet Number	Sheet Name
A00	COVER SHEET
A01	SITE PLAN
A02	BASEMENT & FIRST FLOOR PLAN
A03	SECOND FLOOR & ROOF PLAN
A04	FRONT & RIGHT SIDE ELEVATION
A05	REAR & LEFT SIDE ELEVATION
A06	HOUSE SECTIONS & LINTEL SCHEDULES
A07	TYPICAL WALL SECTION & WALL SCHEDULES
A08	TYPICAL DETAILS
A09	GENERAL NOTES
A10	DOOR & WINDOW SCHEDULE



(ARTISTIC EXPRESSION VIEW)

PERFOMANCE COMPLIANCE		
	SPACE HEA	TING FUEL
	GAS	OIL
	ELECTRIC	PROPANE
	EARTH	SOLID FUEL
BUILDING COMPONENT	REQUIRED	PROPOSED
INSULATION RSI (R) VALUE		
CEILING W/ ATTIC SPACE	10.56 (R60)	10.56 (R60)
CEILING W/O ATTIC SPACE	5.46 (R31)	5.46 (R31)
EXPOSED FLOOR	5.46 (R31)	5.46 (R31)
WALLS ABOVE GRADE	3.87 (R22)	3.87 (R22)
BASEMENT WALLS	3.52 ci (R20 ci)	3.52 ci (R20 ci)
BELOW GRADE SLAB ENTIRE SURFACE >600mm BELOW GRADE	-	¥
EDGE OF BELOW GRADE SLAB < 600mm BELOW GRADE	1.76 (R10)	1.76 (R10)
HEATED SLAB < 600mm BELOW GRADE	1.76 (R10)	1.76 (R10)
WINDOWS & DOORS		
WINDOWS SLIDING GLASS DOORS (MAX U-VALUE / MIN. ER)	1.6	1.6
SKYLIGHTS (MAX. U-VALUE)	2.8	2.8
APPLIANCE EFFICIENCY		
SPACE HEATING EQUIP. (AFUE%)	96%	96%
HRV. EFFICIENCY (%)	75%	75%
DHW HEATER (EF)	0.80	0.80

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NILAMRAJ (RAJ) PATEL

10062

REGISTRATION INFORMATION REQUIRED UNLESS THE DESIGN IS EXEMPT UNDER DIVISION C - 3.2.4.1 OF THE 2012 ONTARIO BUILDING CODE.

RPDS 111189
FIRM NAME BCIN



TRANSPORT TRANSPORT

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FOR REVIEW PERMIT

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No.: Issued For:

Drawing Title:

Client Name:

Date:

COVER SHEET

CARNIVAL

LOT 5, DOMINION ROAD, TOWN OF FORT ERIE, PROPOSED TWO STOREY HOUSE

Drawn by:


MJ
Checked by:
RP
Project No.:

Date:
2022/07/23
Drawing No.:

A00

-DOMINION ROAD-**DRIVEWAY** 9' - 10 1/2' (6.06 m) 3.00 M FROM FRONT 4' 0 1/2" (1,23 m) 4' - 0 1/2"_ (1.23 m) MIN. SET BACK LINE (FRONT) GARAGE PROPOSED TWO STOREY HOUSE F.F.E. = 182.66 M (8.51 m) 4' - 0 1/2"<u>|</u> (1.23 m) | 4' - 0 1/2" (1.23 m) MIN. SET BACK LINE (REAR) 10.97M 1 SITE PLAN 1/8" = 1'-0"

PLEASE REFER TO GRADING PLAN FOR GRADING ELEVATIONS.

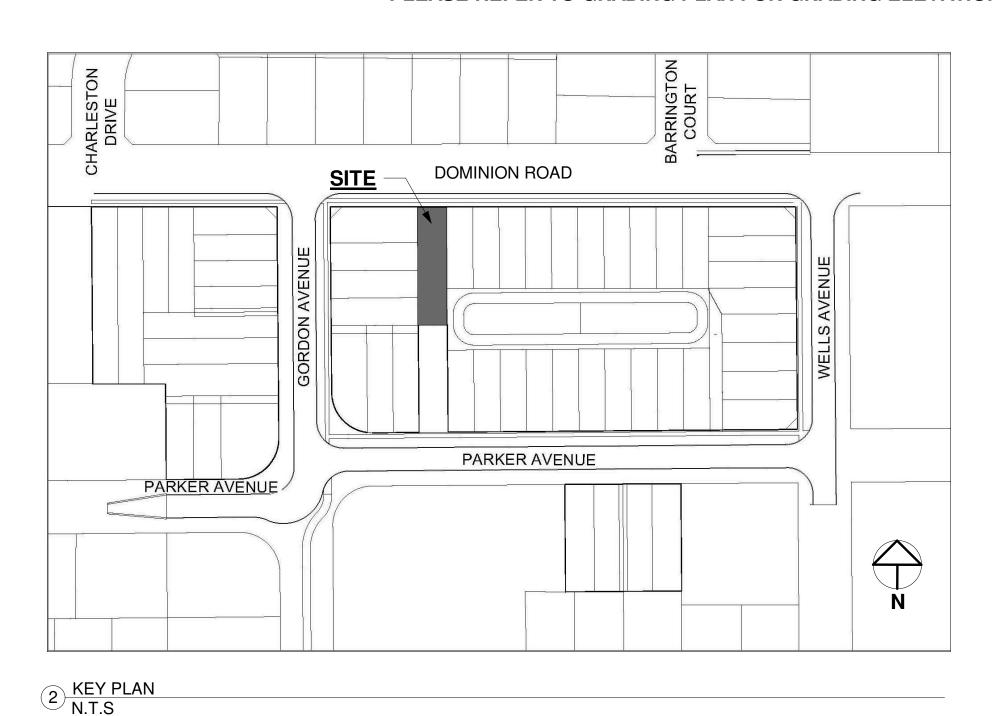

182.66 M. = +/- 0'-0'' F.F.E.

182.66 METER REFERS TO +/- 0'-0" OF FINISHED FIRST FLOOR LEVEL OF THE HOUSE, REFER GRADING PLAN FOR GRADING LEVELS

SITE BASE INFORMATION TAKEN FROM GRADING PLAN - DOMINION ROAD, TOWN OF FORT ERIE BY UPPER CANADA CONSULTANTS.

LOCATION LOT 5

TOWN OF FORT ERIE

SITE DATA				
LOT AREA	490.52 SQM	5279.96 SQFT		
ZONING	R3-	645		
FRONT SET BACK	6.01 M	19'-8 1/2"		
REAR SET BACK	25.24 M	82'-9 1/2"		
RIGHT SIDE SET BACK	1.23 M	4'-0 1/2"		
LEFT SIDE SET BACK	1.23 M	4'-0 1/2"		
HEIGHT OF BUILDING	8.24 M	27'-0"		
MAXIMUM ALLOWED COVERAGE	40% (21	11.98 SQFT)		
PROPOSED COVERAGE	23.60% (1	246.11 SQFT)		
FLOOR AREA				
FIRST FLOOR	69.86 SQM	752.00 SQFT		
SECOND FLOOR	104.95 SQM	1129.68 SQFT		
TOTAL AREA	174.81 SQM	1881.68 SQFT		

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NILAMRAJ (RAJ) PATEL

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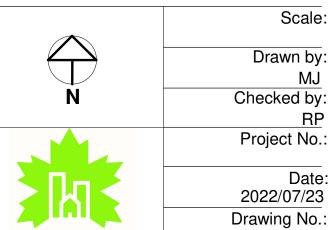
Drawing Title:

A01

SITE PLAN

CARNIVAL

LOT 5, DOMINION ROAD, TOWN OF FORT ERIE, PROPOSED TWO STOREY HOUSE



	COLUMN/POST
COLUMN TYPE	COLUMN SIZE
C1	HSC 102DIA.X6.4 (FOR BASE PLATE AND ANCHOR BOLT SPECS, REFER TO STRUCTURAL DRAWINGS)
C2	HSS 102X102X4.8 (FOR BASE PLATE AND ANCHOR BOLT SPECS, REFER TO STRUCTURAL DRAWINGS)
C3	HSS 127X127X4.8(5"X5"X3/16") (FOR BASE PLATE AND ANCHOR BOLT SPECS, REFER TO STRUCTURAL DRAWINGS)
P1	6X6 S-P-F NO.2
P2	2-2X6 S-P-F
P3	3-2X6 S-P-F
P4	4-2X6 S-P-F
P5	4-2X4 S-P-F

• STRIP FOOTING UNDER LOAD BEARING WALLS MUST HAVE A 6" PROJECTION ON EACH SIDE, AND 8" OR 10" THICK AND 20 MPa POURED CONC. W/ CONT. KEY TO BEAR ON UNDISTURBED SOIL W/ BEARING CAPACITY 150 kPa (3000 psf) MIN -• ALL FOOTING TO BEAR ON UNDISTURBED SOIL, ROCK OR ENGINEERED FILL CERTIFIED BY SOIL ENGINEER • MIN. SOIL BEARING CAPACITY = SLS 150 kPA (3000 psf) & TO BE VERIFIED BY SOIL ENGINEER PRIOR TO POURING THE FOOTING


(*) - SPECIFICATIONS PROVIDED BY MANUFACTURER

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SUPPLIER TAKES RESPONSIBILITY FOR FRAMING OF ALL ENGINEERED LUMBER PRODUCTS INCLUDING FLOOR JOIST, TRUSSES, Pre-ENG.LVL, BEAM AND LINTEL (IF DIFFERENT, FROM THE PROPOSED SIZE) AND WILL PROVIDE APPROVED LAYOUT, REVIEWED AND STAMPED BY ENGINEER. (*) JOIST AS PER SUPPLIER'S SPECIFICATION AND APPROVED DRAWINGS. MAXIMUM JÓIST SIZES MENTIONED ON FLOOR PLAN.

FOR STEEL & WOOD LINTEL SCHEDULE : SEE SHEET A06

SF1 20"X8" STRIP FTG. WITH 2-15M BARS	FOOTING TYPE	FOOTING SIZE
	F1	48"X48"X10" c/w 5-10M BARS EA WAY BOTTO
SF2 22"X8" STRIP FTG. WITH 2-15M BARS	SF1	20"X8" STRIP FTG. WITH 2-15M BARS
	SF2	22"X8" STRIP FTG. WITH 2-15M BARS

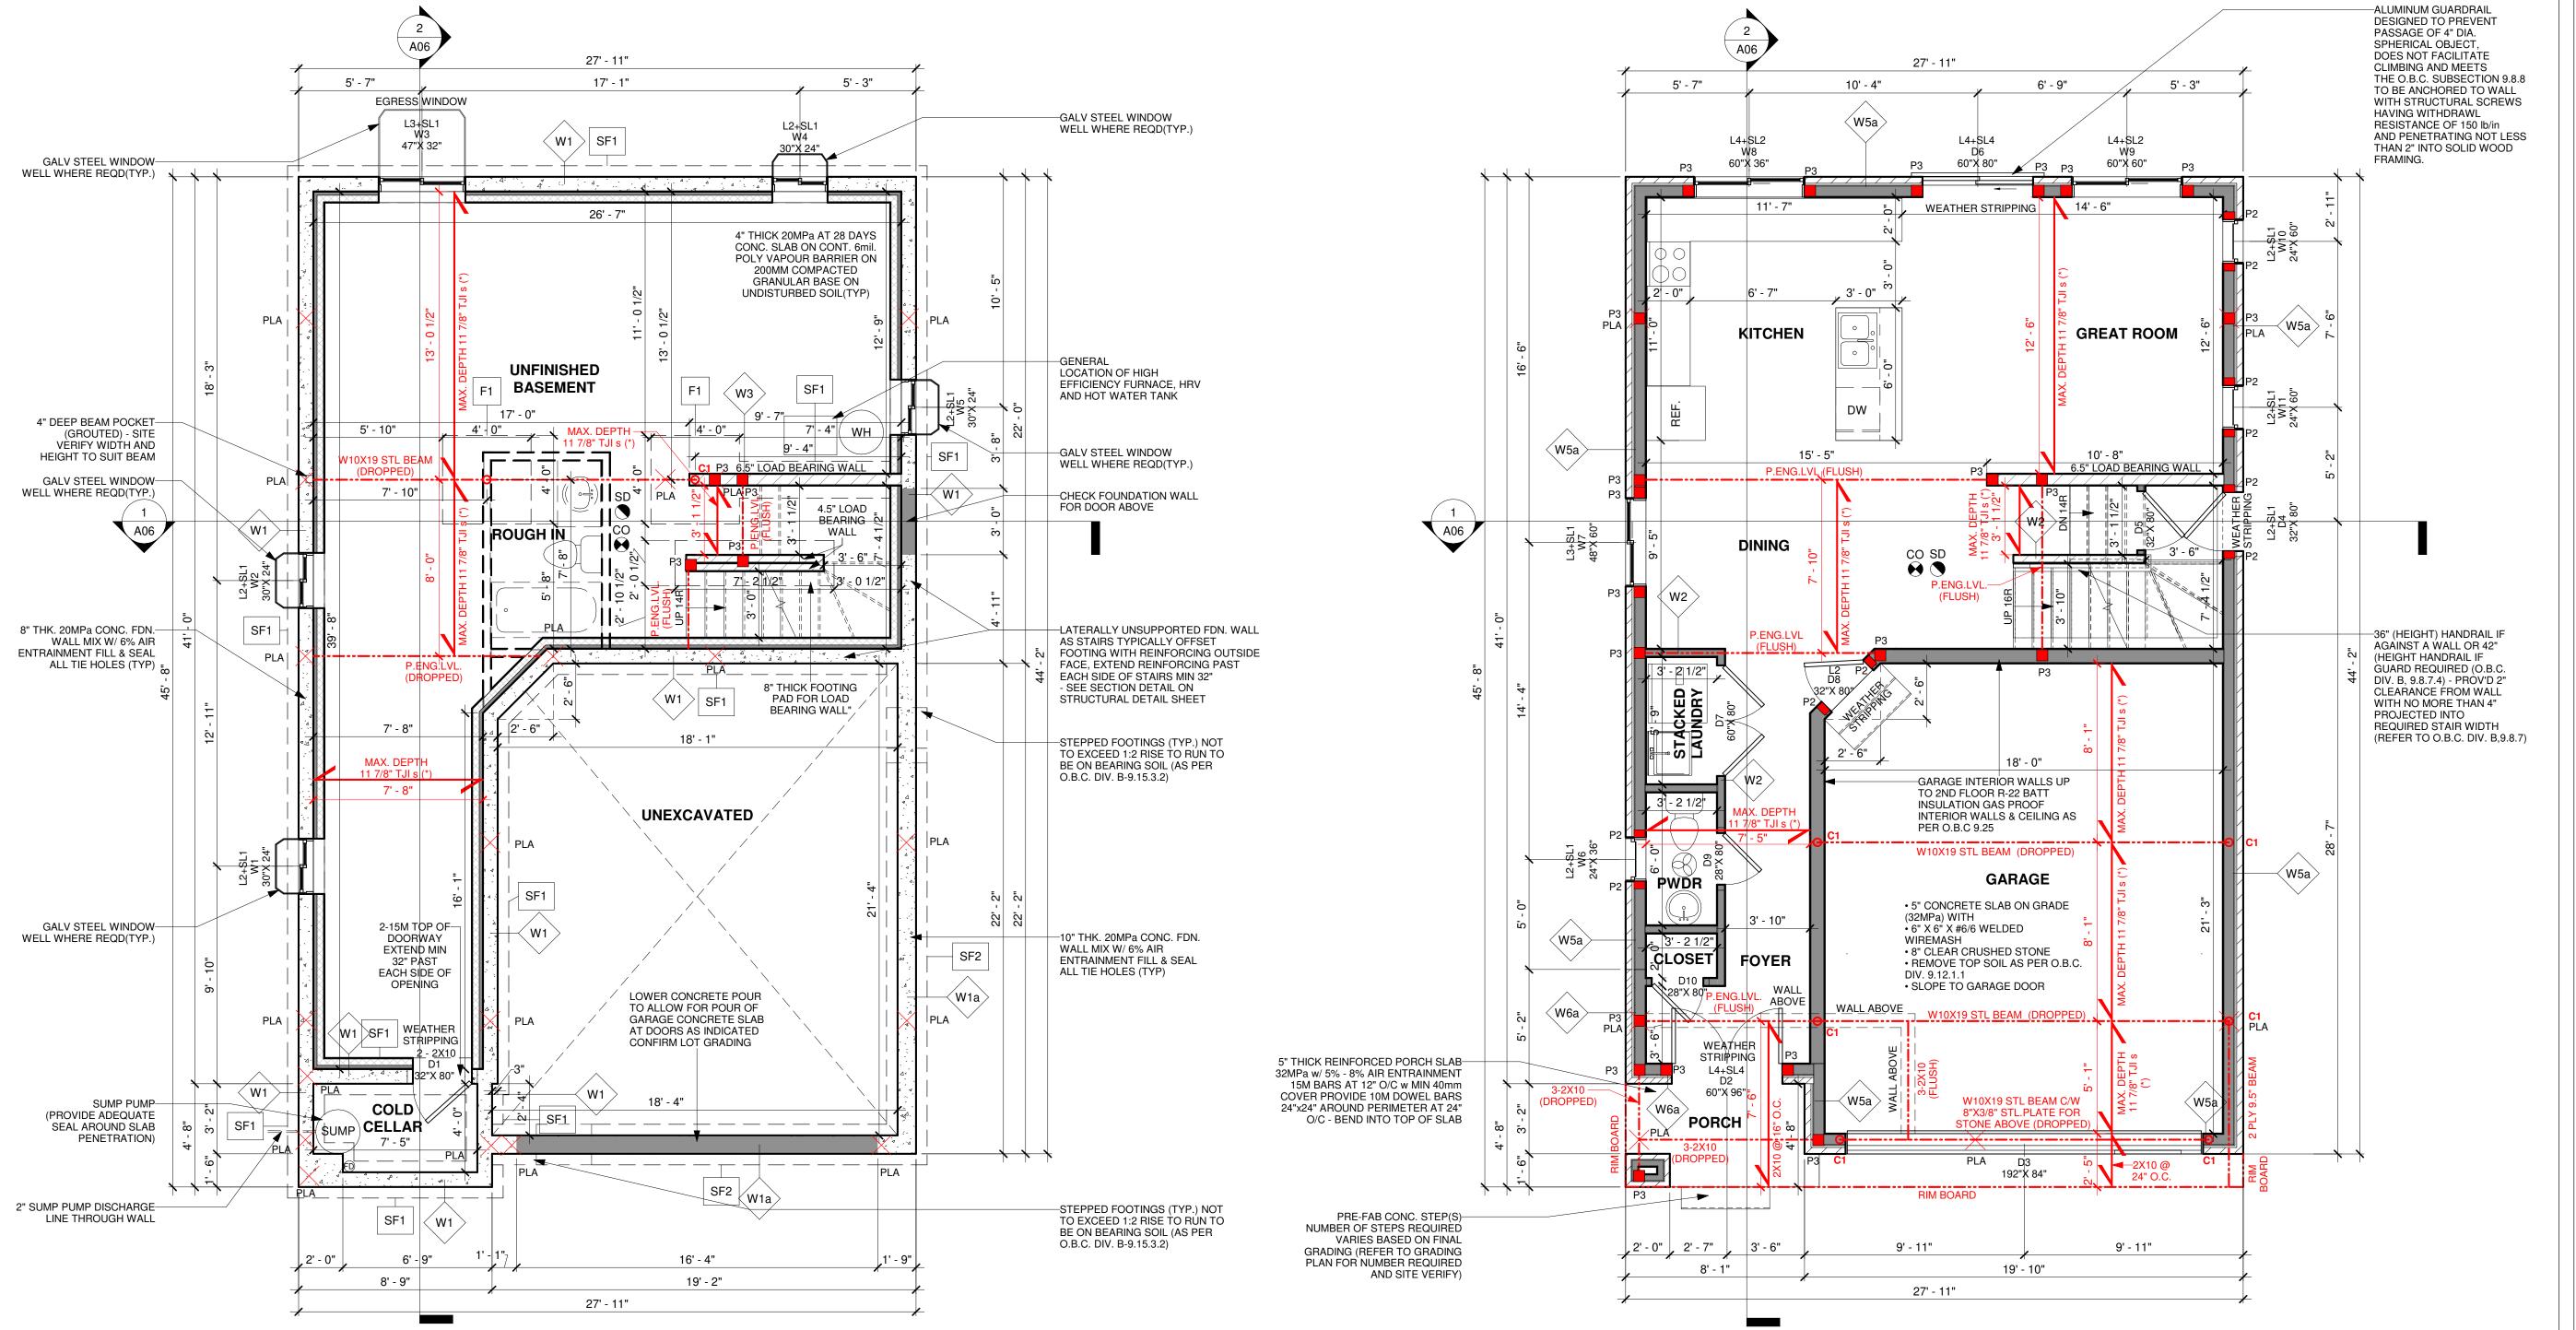

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NILAMRAJ (RAJ) PATEL NAME SIGNATURE BCIN REGISTRATION INFORMATION REQUIRED UNLESS THE DESIGN IS

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A02


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BASEMENT & FIRST FLOOR PLAN

CARNIVAL

LOT 5, DOMINION ROAD, TOWN OF FORT ERIE PROPOSED TWO STOREY HOUSE



BASEMENT PLAN 1/4" = 1'-0"

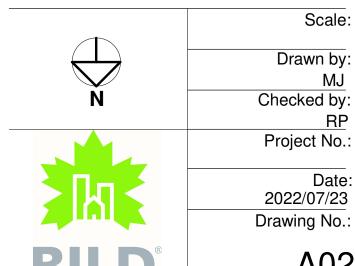
2 FIRST FLOOR PLAN
1/4" = 1'-0"

	COLUMN/POST
COLUMN TYPE	COLUMN SIZE
C1	HSC 102DIA.X6.4 (FOR BASE PLATE AND ANCHOR BOLT SPECS, REFER TO STRUCTURAL DRAWINGS)
C2	HSS 102X102X4.8 (FOR BASE PLATE AND ANCHOR BOLT SPECS, REFER TO STRUCTURAL DRAWINGS)
C3	HSS 127X127X4.8(5"X5"X3/16") (FOR BASE PLATE AND ANCHOR BOLT SPECS, REFER TO STRUCTURAL DRAWINGS)
P1	6X6 S-P-F NO.2
P2	2-2X6 S-P-F
P3	3-2X6 S-P-F
P4	4-2X6 S-P-F
P5	4-2X4 S-P-F

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FOR STEEL & WOOD LINTEL SCHEDULE: SEE SHEET A06



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Drawing Title:

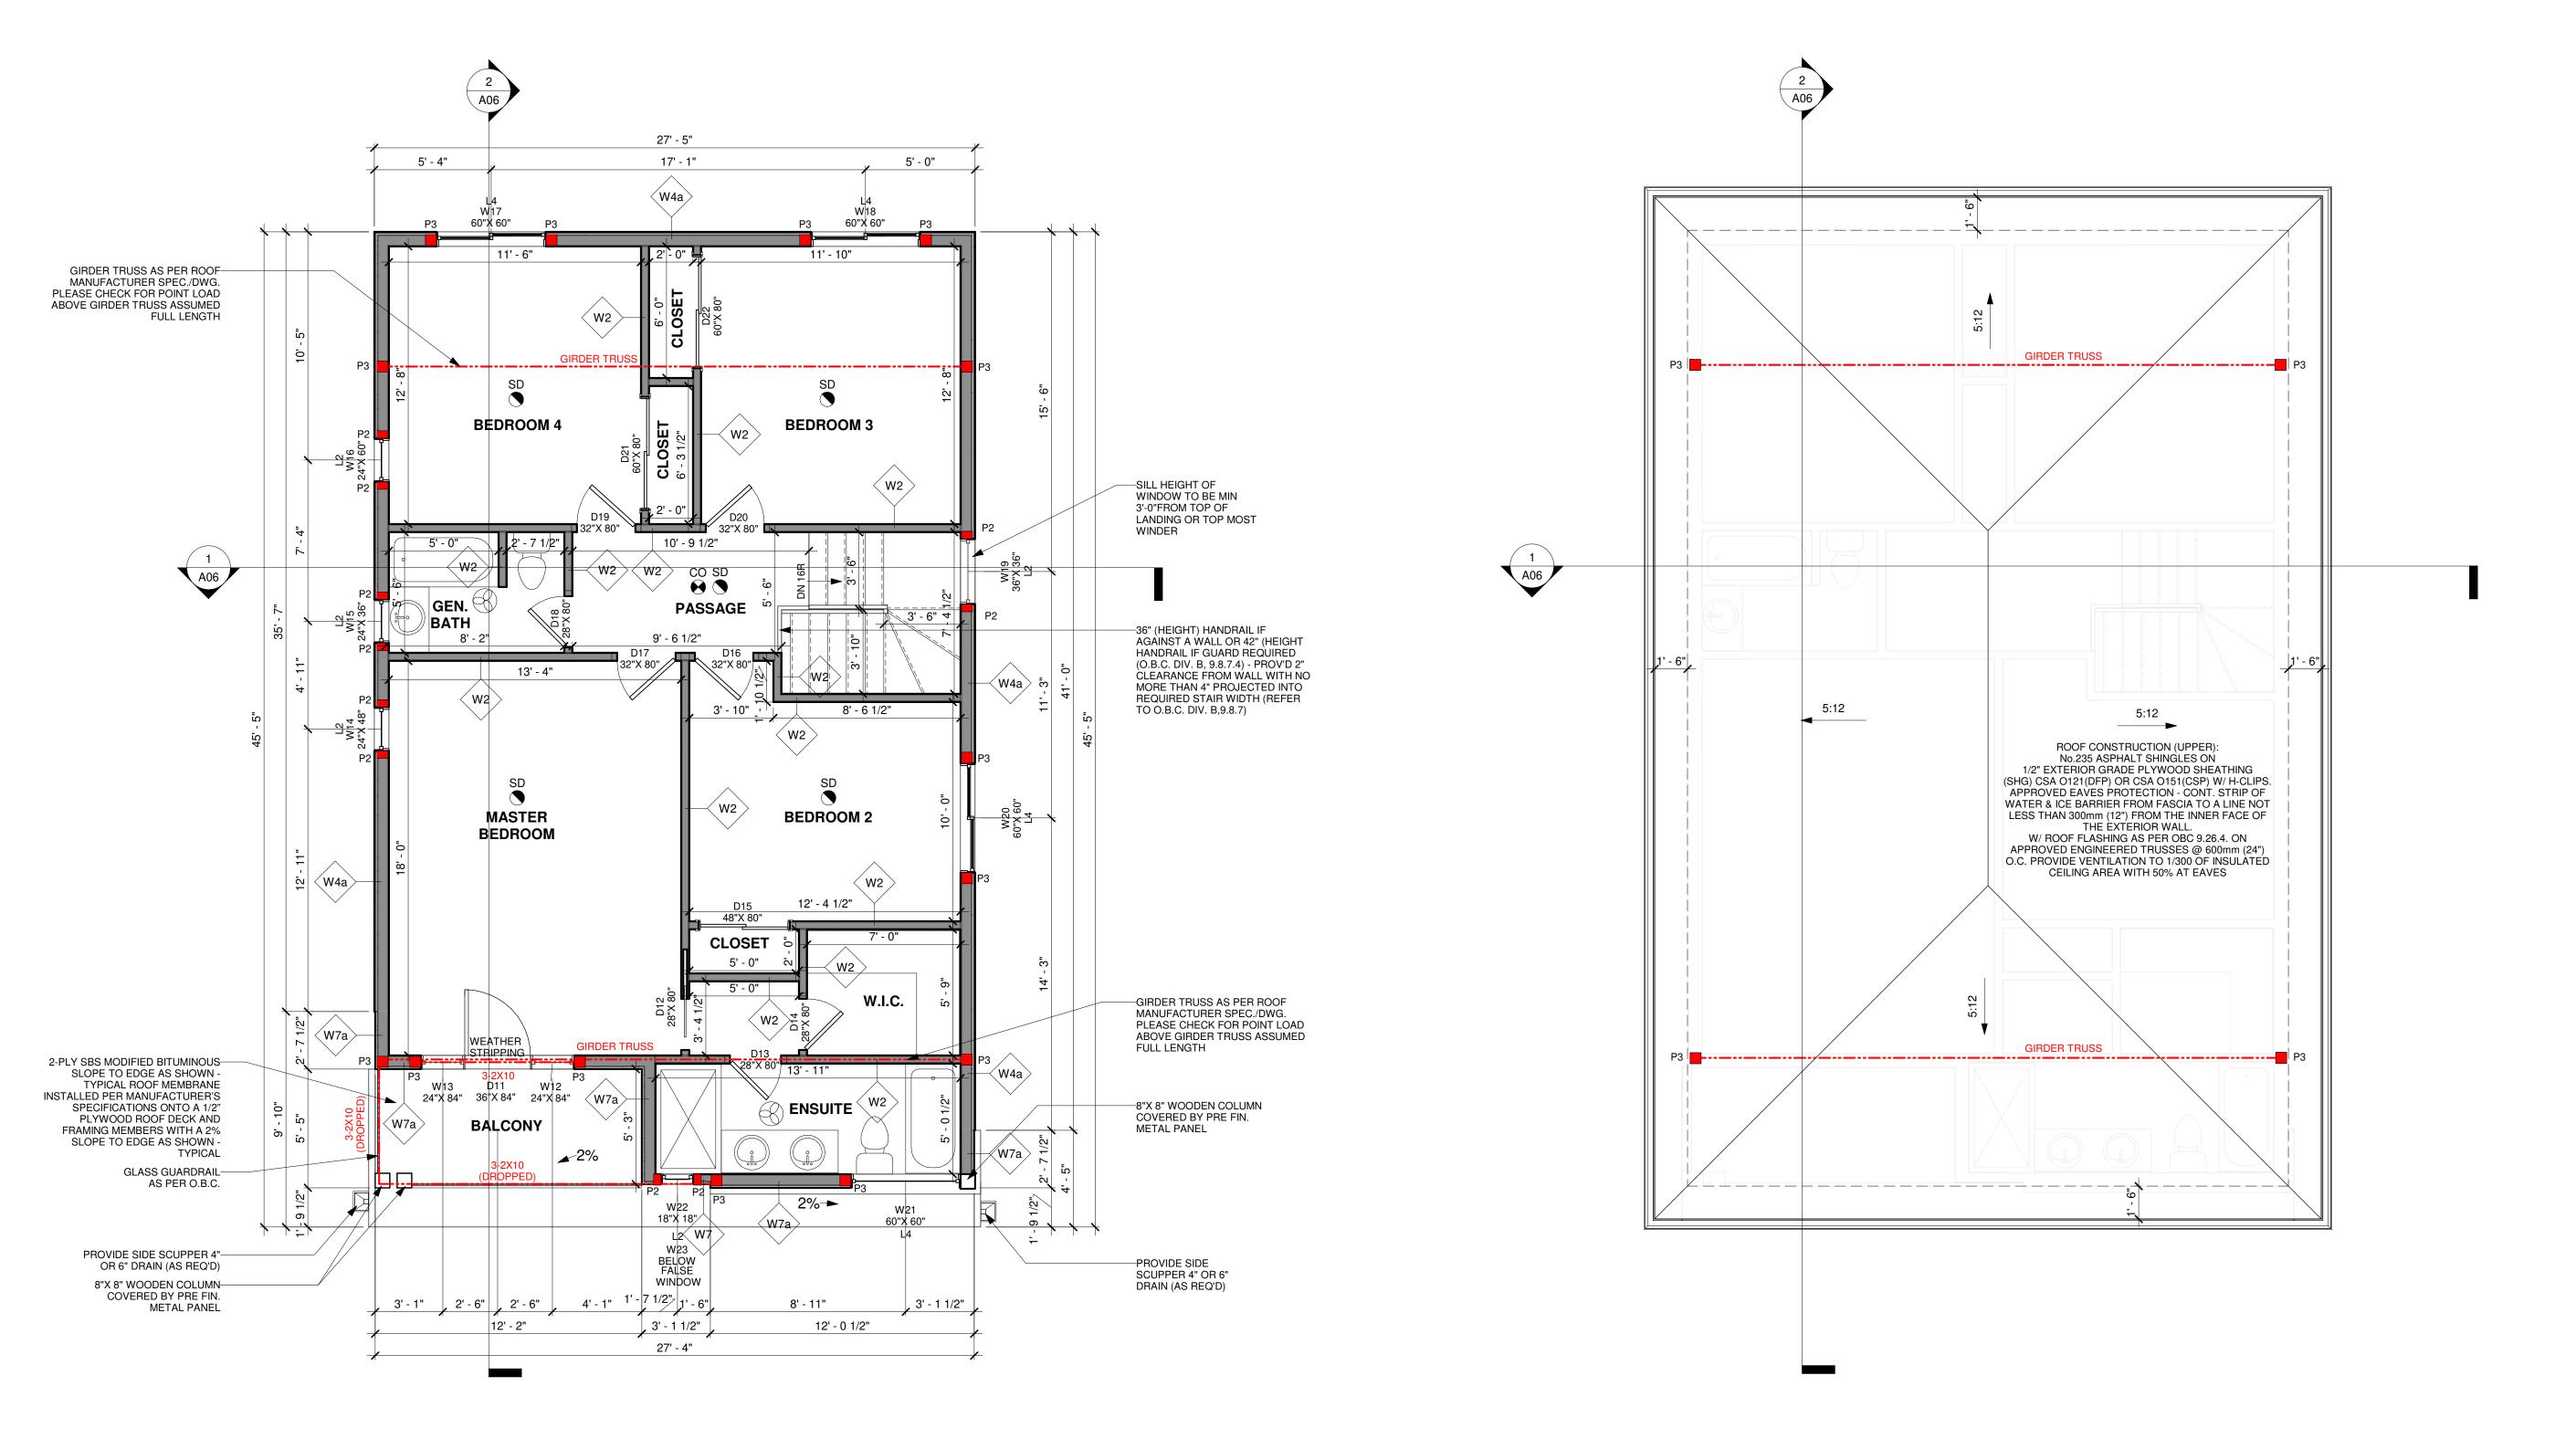A03

Client Name:

SECOND FLOOR & ROOF


CARNIVAL

LOT 5, DOMINION ROAD, TOWN OF FORT ERIE, PROPOSED TWO STOREY HOUSE

	Scale:
	Drawn by:
N	Checked by:
	RP
	Project No.:
—	Date:
	2022/07/23
A INI	Drawing No.:

1 SECOND FLOOR PLAN 1/4" = 1'-0"

2 ROOF PLAN
1/4" = 1'-0"

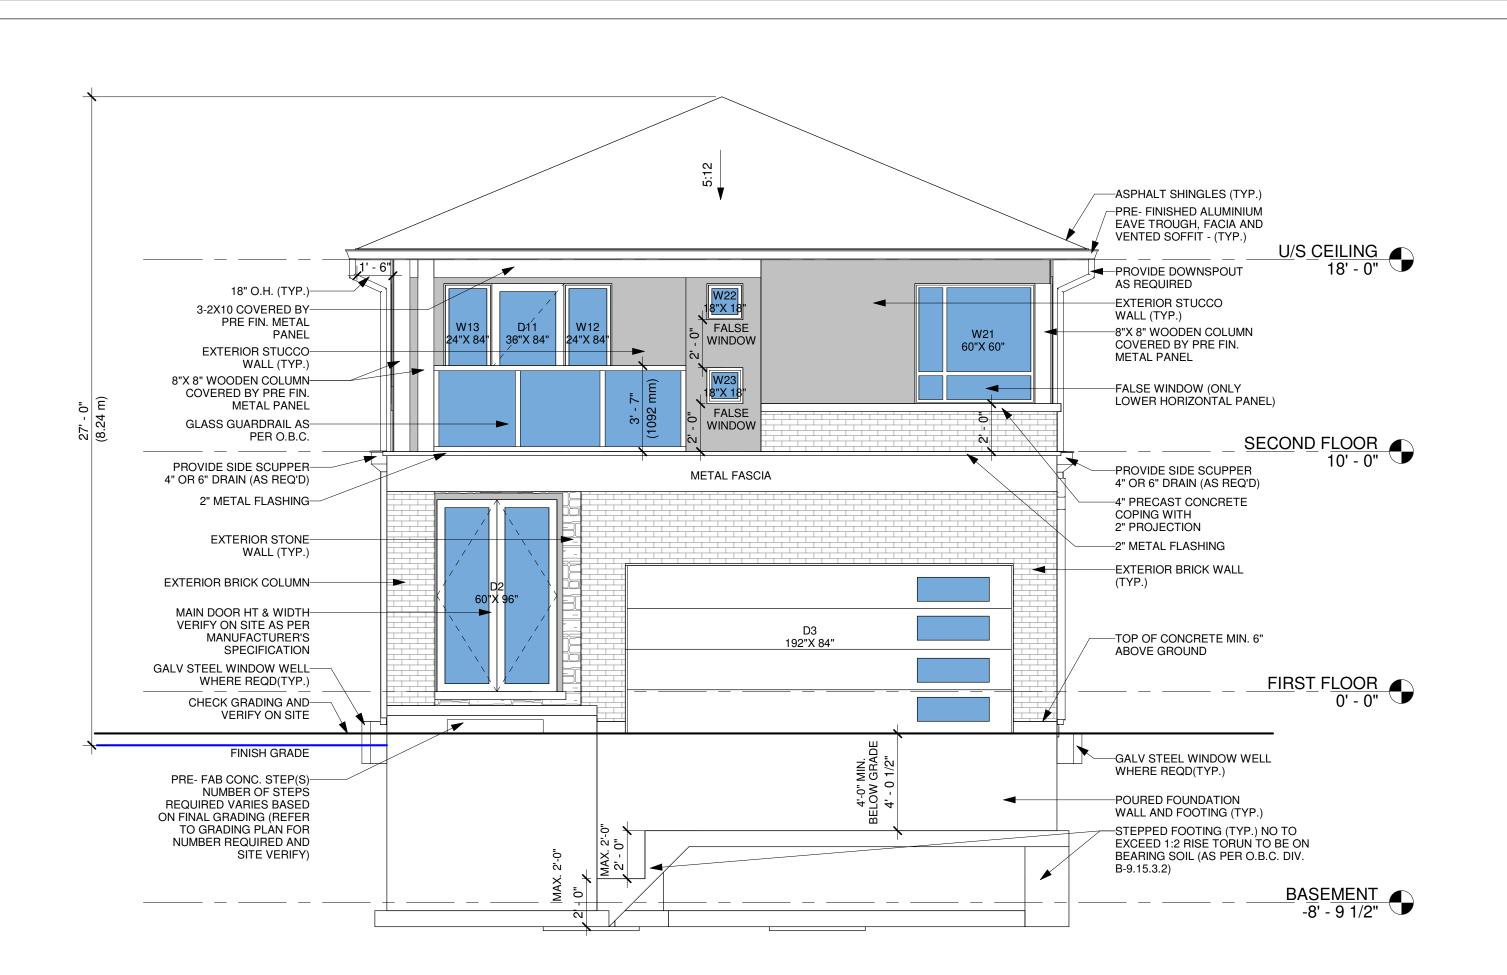

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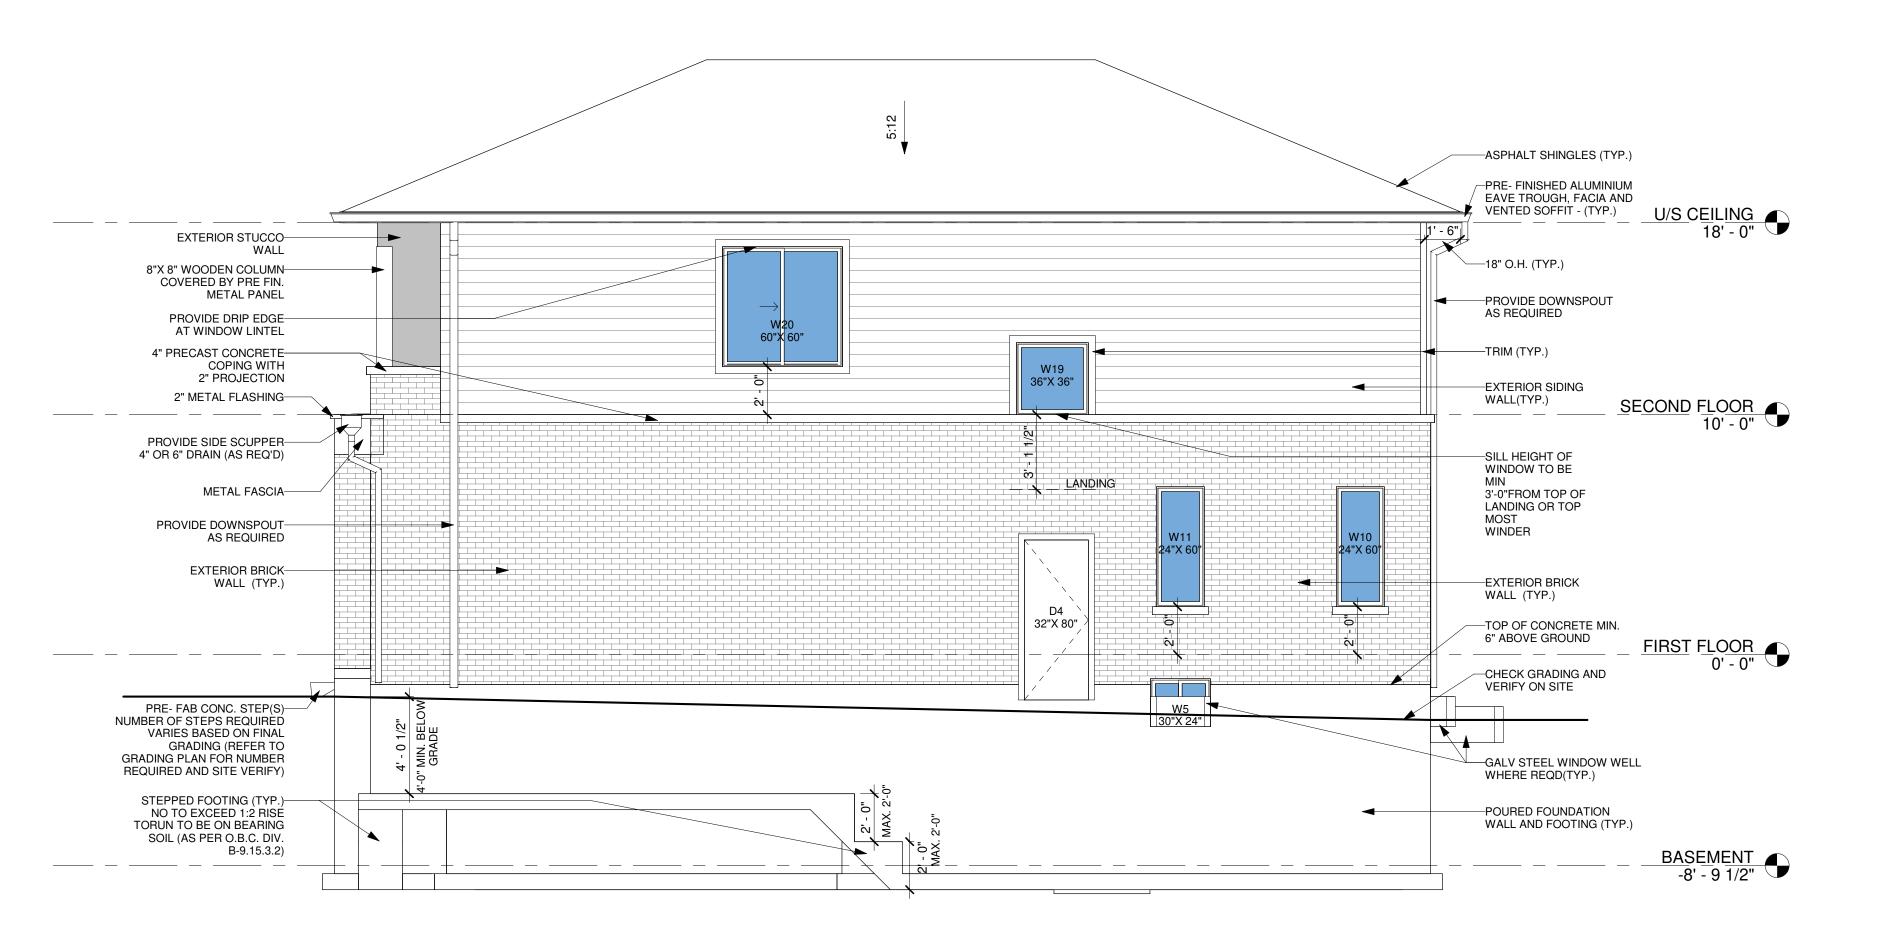


FRONT ELEVATION ¹ 1/4" = 1'-0"

RIGHT SIDE OPENING CALCULAT	ΓΙΟΝ
%UNPROTECTED OPENING	DATA
1. WALL AREA	890.64 SQFT
2. LIMITING DISTANCE	4'-0 1/2" (1.23 M)
3. ALLOWABLE OPENINGS	62.34 SQFT(7%)
4. PROVIDED OPENINGS	57.75 SQFT (6.48%)

FOR GARAGE, BASEMENT, FF AND PORCH GRADING LEVEL REFER TO GRADING PLAN. IN SITUATION OF DISCREPANCY BETWEEN ARCHITECTURAL DRAWING SET AND CIVIL SET, FOLLOW THE CIVIL SET(GRADING PLAN)

WINDOW SUPPLIER TO ENSURE DOORS & WINDOWS ARE AS PER OBC STANDARD INCLUDING MINIMUM OPENABLE OPENINGS



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NILAMRAJ (RAJ) PATEL SIGNATURE NAME

EXEMPT UNDER DIVISION C - 3.2.4.1 OF THE 2012 ONTARIO BUILDING CODE. RPDS

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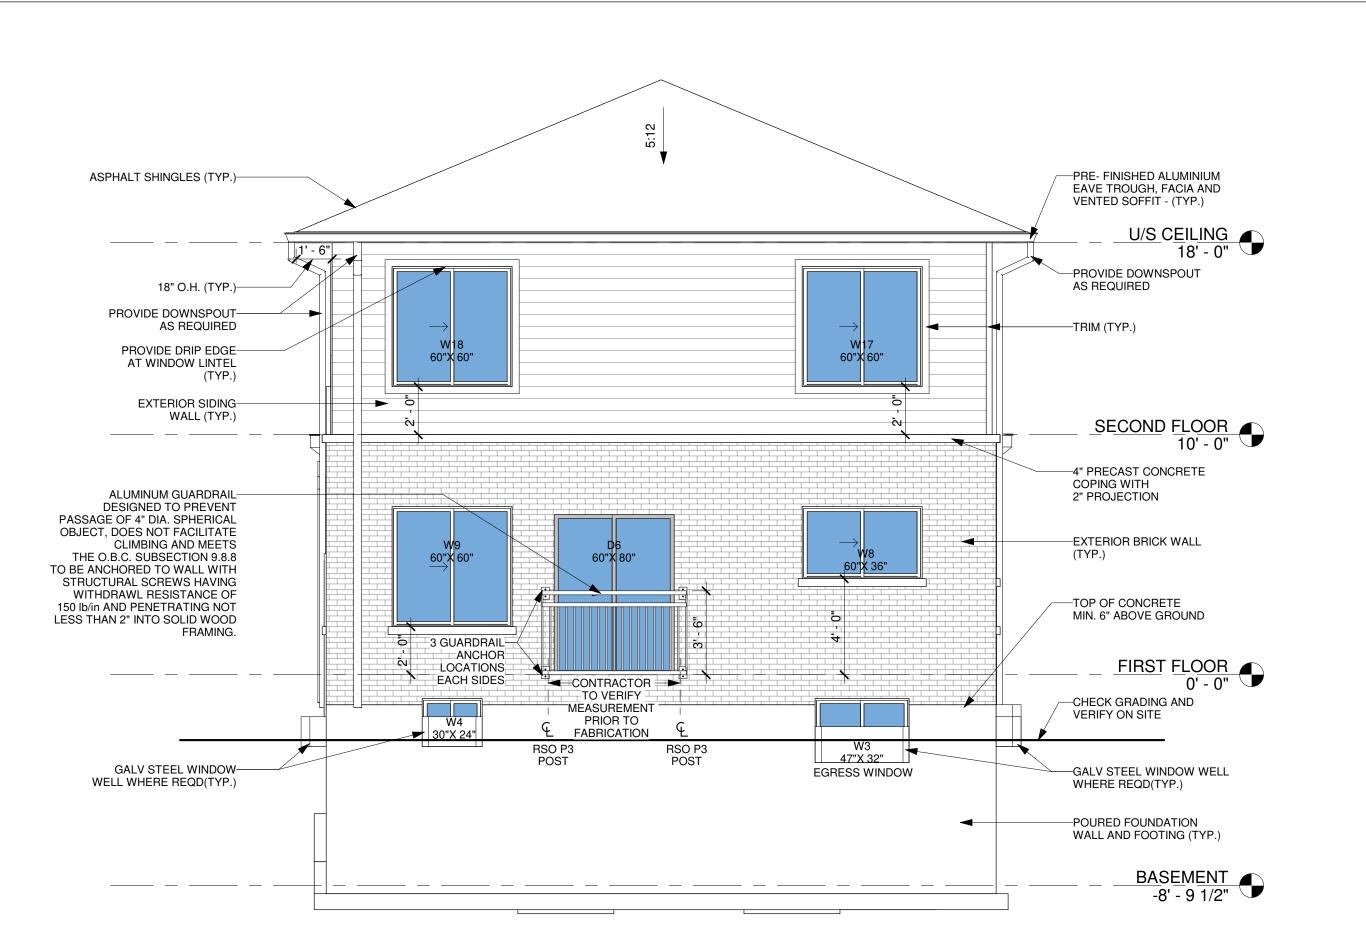
FRONT & RIGHT SIDE **ELEVATION**

CARNIVAL

LOT 5, DOMINION ROAD, TOWN OF FORT ERIE, PROPOSED TWO STOREY HOUSE

Scale: Drawn by: Checked by: Project No.: Date: 2022/07/23 Drawing No.: A04


2 RIGHT SIDE ELEVATION
1/4" = 1'-0"



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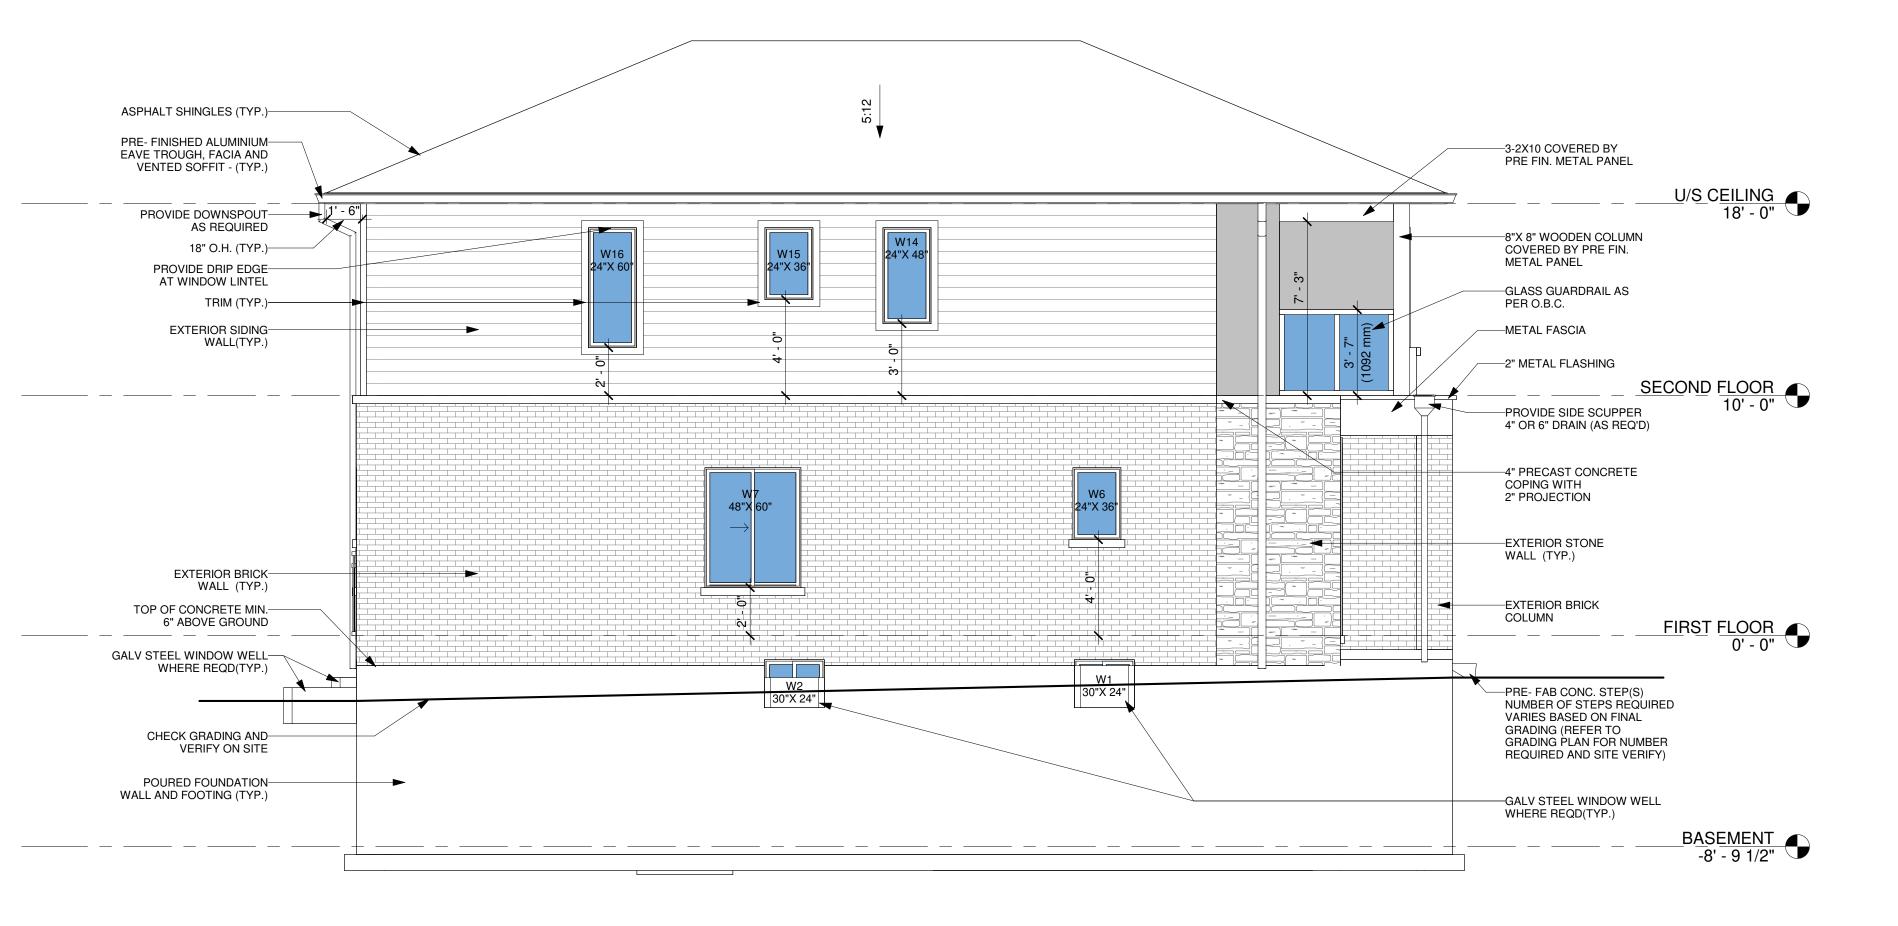


REAR ELEVATION 1/4" = 1'-0"

LEFT SIDE OPENING CALCULA	TION
%UNPROTECTED OPENING	DATA
1. WALL AREA	814.81 SQFT
2. LIMITING DISTANCE	4'-0 1/2" (1.23 M)
3. ALLOWABLE OPENINGS	57.04 SQFT(7%)
4. PROVIDED OPENINGS	55.98 SQFT (6.87%)

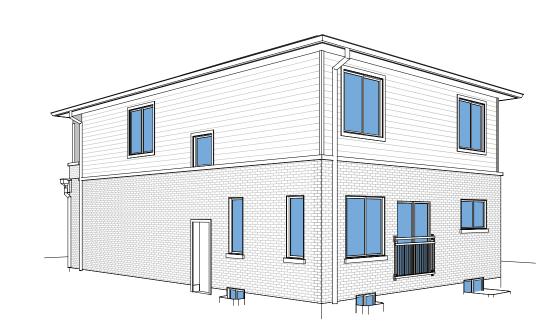FOR GARAGE, BASEMENT, FF AND PORCH GRADING LEVEL REFER TO GRADING PLAN. IN SITUATION OF DISCREPANCY BETWEEN ARCHITECTURAL DRAWING SET AND CIVIL SET, FOLLOW THE CIVIL SET(GRADING PLAN)

WINDOW SUPPLIER TO ENSURE DOORS & WINDOWS ARE AS PER OBC STANDARD INCLUDING MINIMUM OPENABLE OPENINGS



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NILAMRAJ (RAJ) PATEL NAME SIGNATURE

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FIRM NAME

BCIN

Date:



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Drawing Title:


REAR & LEFT SIDE **ELEVATION**

CARNIVAL

LOT 5, DOMINION ROAD, TOWN OF FORT ERIE, PROPOSED TWO STOREY HOUSE

Scale: Drawn by: Checked by: Project No.: Date: 2022/07/23 Drawing No.: A05

2 LEFT SIDE ELEVATION 1/4" = 1'-0"

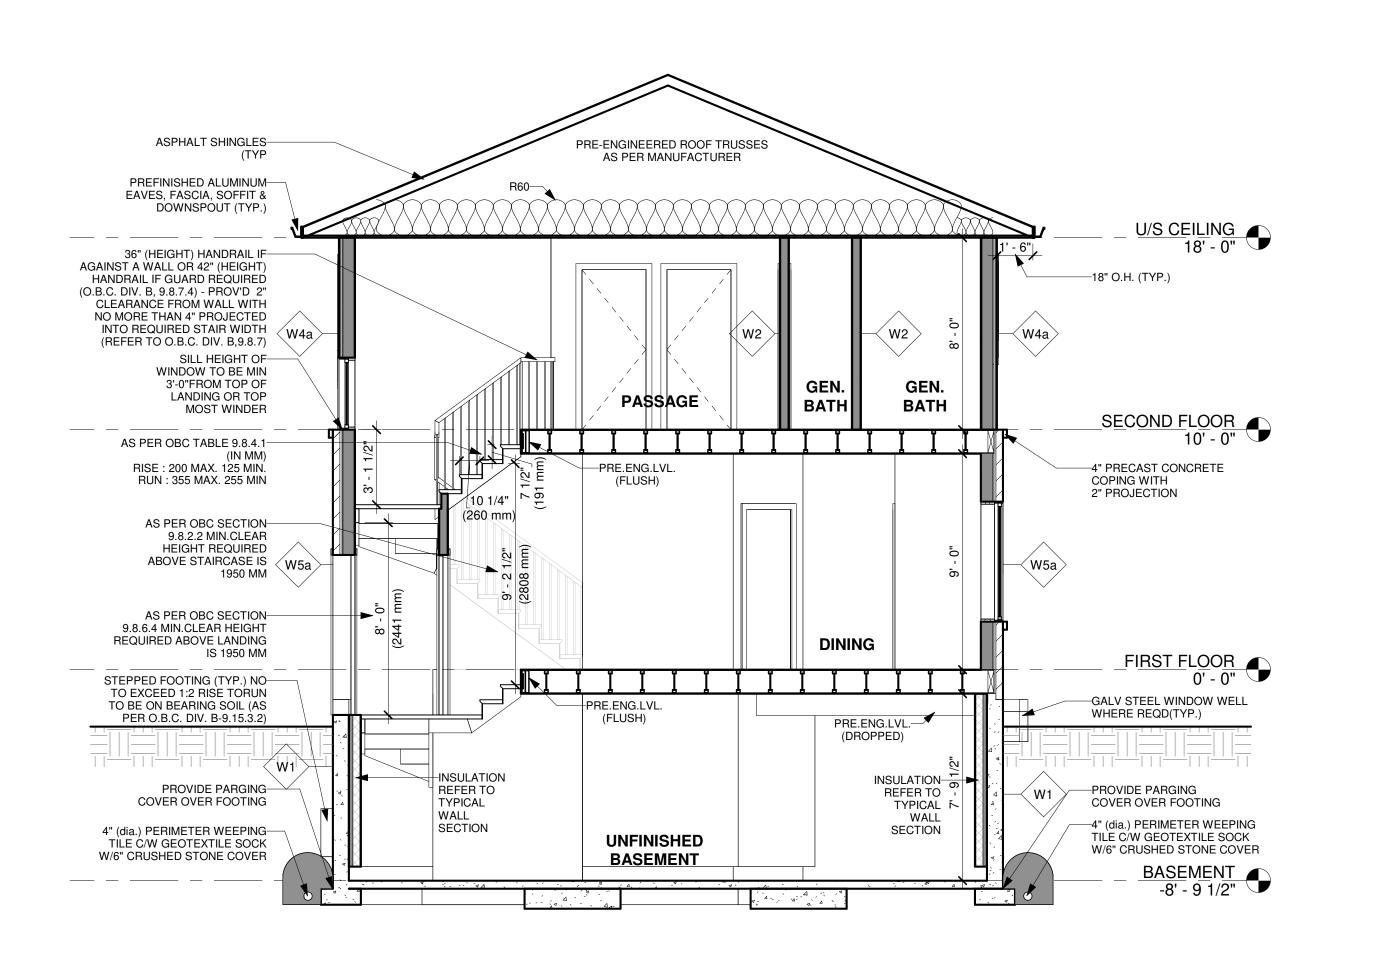





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(*) JOIST AS PER SUPPLIER'S SPECIFICATION AND APPROVED DRAWINGS. MAXIMUM JÓIST SIZES MENTIONED ON FLOOR PLAN.

FOR STEEL & WOOD LINTEL SCHEDULE: SEE SHEET A06

	WOOD LINTEL SCHEDULE	
	MIN. ANGLE SIZE	
L1	2-2X4	
L2	2 - 2 X 6	
L3	2-2X8	
L4	2 - 2 X 10	
L5	2 - 2 X 12	

STEEL ANGLE LINTEL SCHEDULE


FOR STEEL LINTEL SUPPORTING MASONRY VENEER (O.B.C. 9.20.5.2.B)

		MAX. ALLOWABLE SPAN		
	MIN. ANGLE SIZE	FOR BRICK (2 3/4")	FOR BRICK (3 1/2")	FOR STONE
SL1	L-3 1/2" x 3 1/2" x 1/4"	8'-6" OR LESS	8'-1" OR LESS	7'-9" OR LESS
SL2	L-4" x 3 1/2" x 1/4"	9'-2"	8'-9"	8'-2"
SL3	L- 4 7/8" x 3 1/2" x 5/16"	11'-5"	10'-10"	10'-1"
SL4	L- 4 7/8" x 3 1/2" x 3/8"	11'-11"	11'-5"	10"-8"
SL5	L- 4 7/8" x 3 1/2" x 1/2"	12'-7"	11'-9"	10'-11"
SL6	L- 5 7/8" x 3 1/2" x 3/8"	13'-4"	12'-7"	11'-8"
SL7	L- 5 7/8" x 3 1/2" x 1/2"	14'-2"	13'-5"	12'-5"
SL8	L- 5 7/8" x 4" x 1/2"	14'-4"	13'-6"	12'-7"
SL9	L- 7 1/8" x 4" x 3/8"	15'-0"	14'-1"	13'-1"
SL10	L- 7 1/8" x 4" x 13 1/2"	16'-0"	15'-1"	14'-0"

SECTION 1 / 1/4" = 1'-0"

S	STEEL BEAM LINTEL SCHEDULE FOR STEEL BEAMS SUPPORTING MASONARY VENEER O.B.C. 9.20.5.2 (C)			
SECTION	2 3/4" BRICK	3 1/2" BRICK	4" STONE	
W 6 x 15	13'-11"	13'-5"	12'-11"	
W 6 x 20	15'-4"	14'-10"	14'-2"	
W 8 x 18	17'-3"	16'-8"	15'-10"	
W 8 x 21	18'-3"	17'-7"	16'-9"	
W 8 x 24	18'-9"	18'-0"	17'-2"	

WOOD LINTEL SCHEDULE (0.B.C. 9.23.12.3)							
		MAXIMUM SPAN, m.					
LINTEL	LINTEL SIZE	EXTERIOR WALLS					
SUPPORTING		SPECIFIED SNOW LOAD, kPa				INTERIO	
		1.0	1.5	2.0	2.5	3.0	WALLS
LIMITED	2 - 1 1/2 x 3 1/2 (L1-2 - 2 x 4)						4' - 2"
ATTIC	2 - 1 1/2 x 5 1/2 (L2-2 - 2 x 6)						6' - 4"
STORAGE	2 - 1 1/2 x 7 1/4 (L3-2 - 2 x 8)						7' - 9"
AND	2 - 1 1/2 x 9 1/4 (L4-2 - 2 x 10)						9' - 5"
CEILING	2 - 1 1/2 x 11 1/4 (L5-2 - 2 x 12)						11' - 0"
ROOF AND	2 - 1 1/2 x 3 1/2 (L1-2 - 2 x 4)	8' - 4"	7' - 4"	6' - 8"	6' - 2"	5' - 10"	6' - 2"
CEILING ONLY	2 - 1 1/2 x 5 1/2 (L2-2 - 2 x 6)	13' - 1"	11' - 6"	10' - 5"	9' - 9"	9' - 1"	9' - 9"
(TRIBUTARY	2 - 1 1/2 x 7 1/4 (L3-2 - 2 x 8)	17' - 4"	15' - 2"	13' - 9"	12' - 9"	12' - 0"	12' - 9"
WIDTH OF 0.6 M	2 - 1 1/2 x 9 1/4 (L4-2 - 2 x 10)	20' - 11"	18' - 11"	17' - 6"	16' - 3"	15' - 4"	16' - 3"
MAXIMUM) ROOF AND	2 - 1 1/2 x 11 1/4 (L5-2 - 2 x 12)	24' - 2"	21' - 11"	20' - 4"	19' - 3"	18' - 5"	19' - 3"
CEILING	2 - 1 1/2 x 3 1/2 (L1-2 - 2 x 4)	4' - 2"	3' - 8"	3' - 4"	3' - 1"	2' - 10"	3' - 1"
ONLY	2 - 1 1/2 x 5 1/2 (L2-2 - 2 x 6)	6' - 4"	5' - 5"	4' - 10"	4' - 5"	4' - 1"	4' - 5"
(TRIBUTARY WITH	2 - 1 1/2 x 7 1/4 (L3-2 - 2 x 8)	7' - 9"	6' - 8"	5' - 11"	5' - 5"	5' - 0"	5' - 5"
OF 4.9 M	2 - 1 1/2 x 9 1/4 (L4-2 - 2 x 10)	9' - 5"	8' - 1"	7' - 3"	6' - 7"	6' - 0"	6' - 7"
MAXIMUM)	2 - 1 1/2 x 11 1/4 (L5-2 - 2 x 12)	11' - 0"	9' - 5"	8' - 5"	7' - 8"	6' - 10"	7' - 8"
,	2 - 1 1/2 x 3 1/2 (L1-2 - 2 x 4)	3' - 5"	3' - 2"	2' - 11"	2' - 9"	2' - 7"	2' - 5"
ROOF,	2 - 1 1/2 x 5 1/2 (L2-2 - 2 x 6)	4' - 11"	4' - 6"	4' - 2"	3' - 11"	3' - 9"	3' - 4"
CEILING,	2 - 1 1/2 x 7 1/4 (L3-2 - 2 x 8)	6' - 0"	5' - 6"	5' - 1"	4' - 9"	4' - 5"	3' - 11"
AND 1	2 - 1 1/2 x 9 1/4 (L4-2 - 2 x 10)	7' - 3"	6' - 8"	6' - 2"	5' - 8"	5' - 3"	4' - 9"
STOREY	2 - 1 1/2 x 11 1/4 (L5-2 - 2 x 12)	8' - 6"	7' - 9"	7' - 1"	6' - 5"	5' - 11"	5' - 5"
ROOF,	2 - 1 1/2 x 3 1/2 (L1-2 - 2 x 4)	3' - 1"	2' - 11"	2' - 9"	2' - 7"	2' - 6"	2' - 1"
CEILING	2 - 1 1/2 x 5 1/2 (L2-2 - 2 x 6)	4' - 5"	4' - 2"	3' - 11"	3' - 9"	3' - 6"	2' - 11"
AND 2	2 - 1 1/2 x 7 1/4 (L3-2 - 2 x 8)	5' - 4"	5' - 0"	4' - 9"	4' - 5"	4' - 1"	3' - 5"
STOREYS	2 - 1 1/2 x 9 1/4 (L4-2 - 2 x 10)	6' - 6"	6' - 2"	5' - 8"	5' - 3"	4' - 11"	4' - 2"
0.0	2 - 1 1/2 x 11 1/4 (L5-2 - 2 x 12)	7' - 7"	6' - 11"	6' - 5"	6' - 0"	5' - 7"	4' - 9"
ROOF,	2 - 1 1/2 x 3 1/2 (L1-2 - 2 x 4)	2' - 11"	2' - 9"	2' - 8"	2' - 6"	2' - 5"	1' - 11"
CEILING	2 - 1 1/2 x 5 1/2 (L2-2 - 2 x 6)	4' - 1"	3' - 11"	3' - 9" 4' - 5"	3' - 7"	3' - 4"	2' - 8" 3' - 2"
AND 3	2 - 1 1/2 x 7 1/4 (L3-2 - 2 x 8)	5' - 0" 6' - 1"	4' - 9" 5' - 8"	4" - 5" 5' - 4"	4' - 2" 5' - 0"	4' - 0" 4' - 9"	3' - 2"
STOREYS	2 - 1 1/2 x 9 1/4 (L4-2 - 2 x 10) 2 - 1 1/2 x 11 1/4 (L5-2 - 2 x 12)	6' - 1" 6' - 11"	5' - 8" 6' - 5"	5' - 4" 6' - 0"	5' - 0" 5' - 9"	4' - 9" 5' - 5"	3' - 10" 4' - 5"

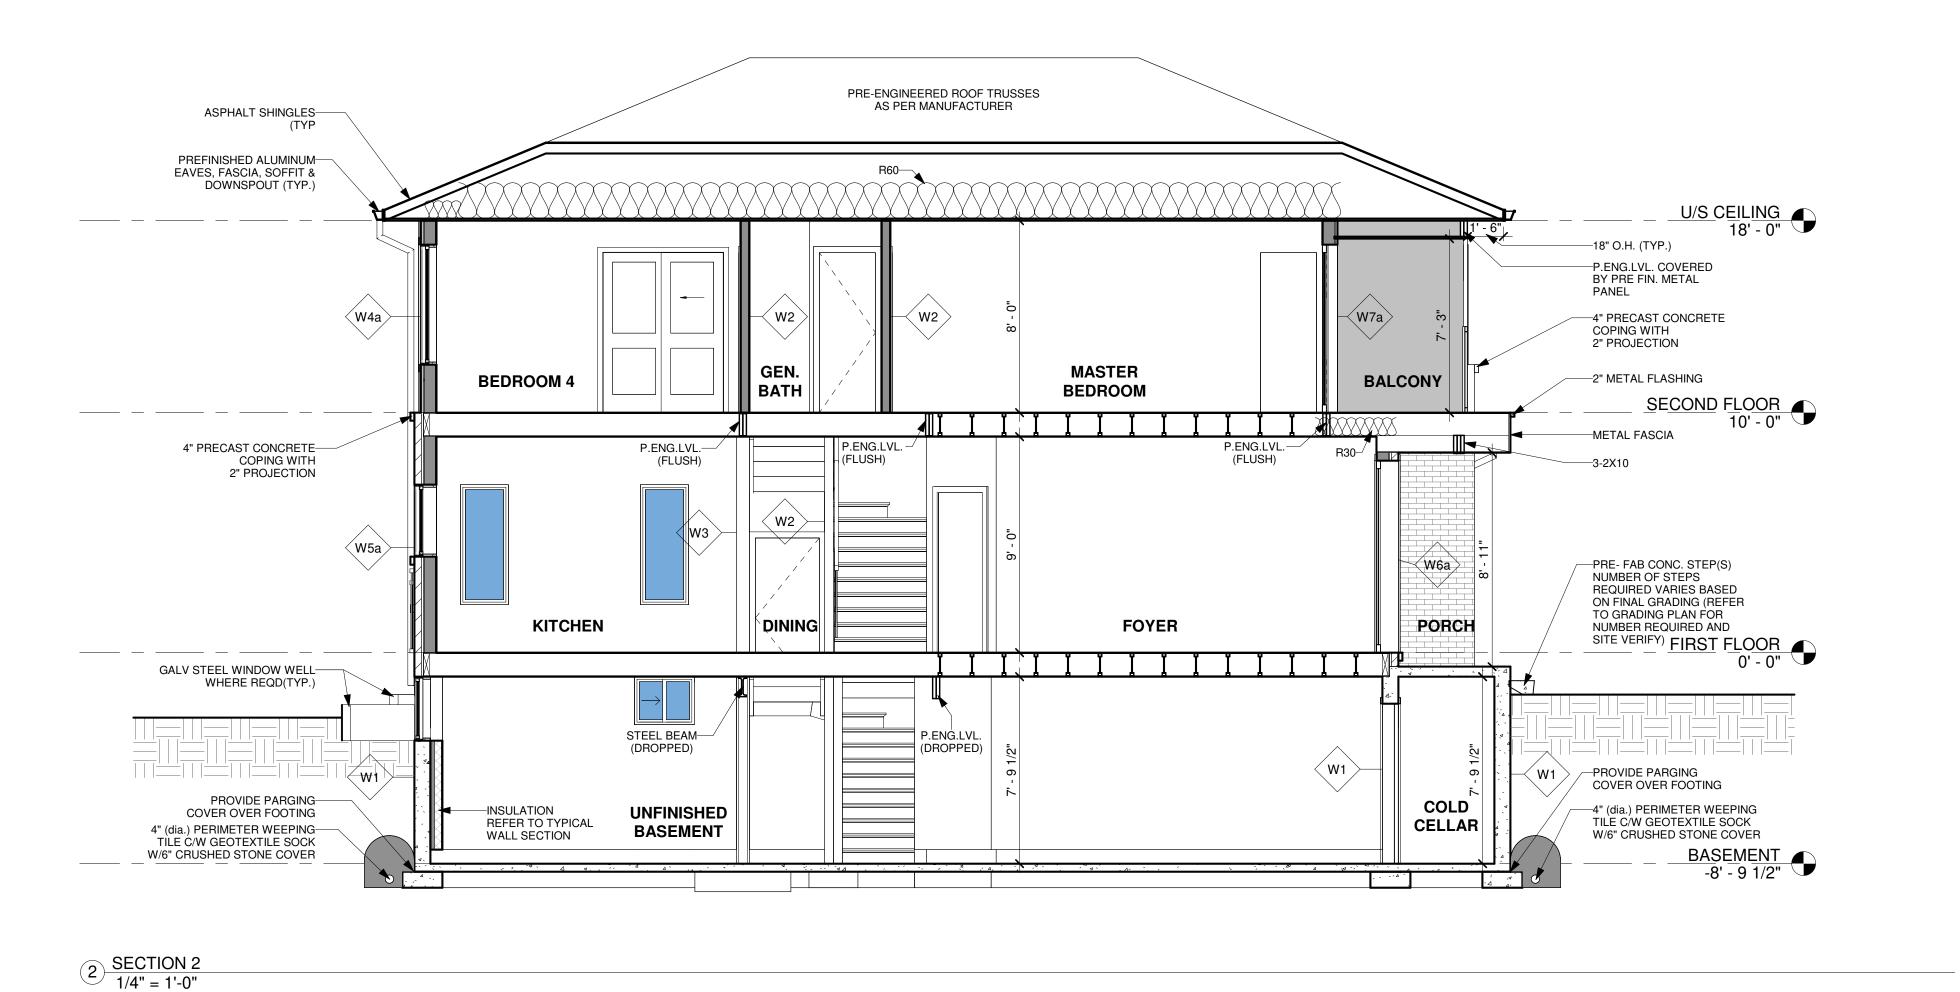

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NILAMRAJ (RAJ) PATEL NAME SIGNATURE REGISTRATION INFORMATION REQUIRED UNLESS THE DESIGN IS

EXEMPT UNDER DIVISION C - 3.2.4.1 OF THE 2012 ONTARIO BUILDING CODE. RPDS FIRM NAME

BCIN

Date:



Phone: 647-556-2596

No.: Revision:

2022/08/09 1 Issued For Review No.: Issued For: Date

Drawing Title:


Client Name:

HOUSE SECTIONS & LINTEL SCHEDULES

CARNIVAL

LOT 5, DOMINION ROAD. TOWN OF FORT ERIE, PROPOSED TWO STOREY HOUSE

	Scale:
	Drawn by:
	MJ
	Checked by:
	RP
	Project No.:
	Date:
	2022/07/23
INI	Drawing No.:
BILD®	A06

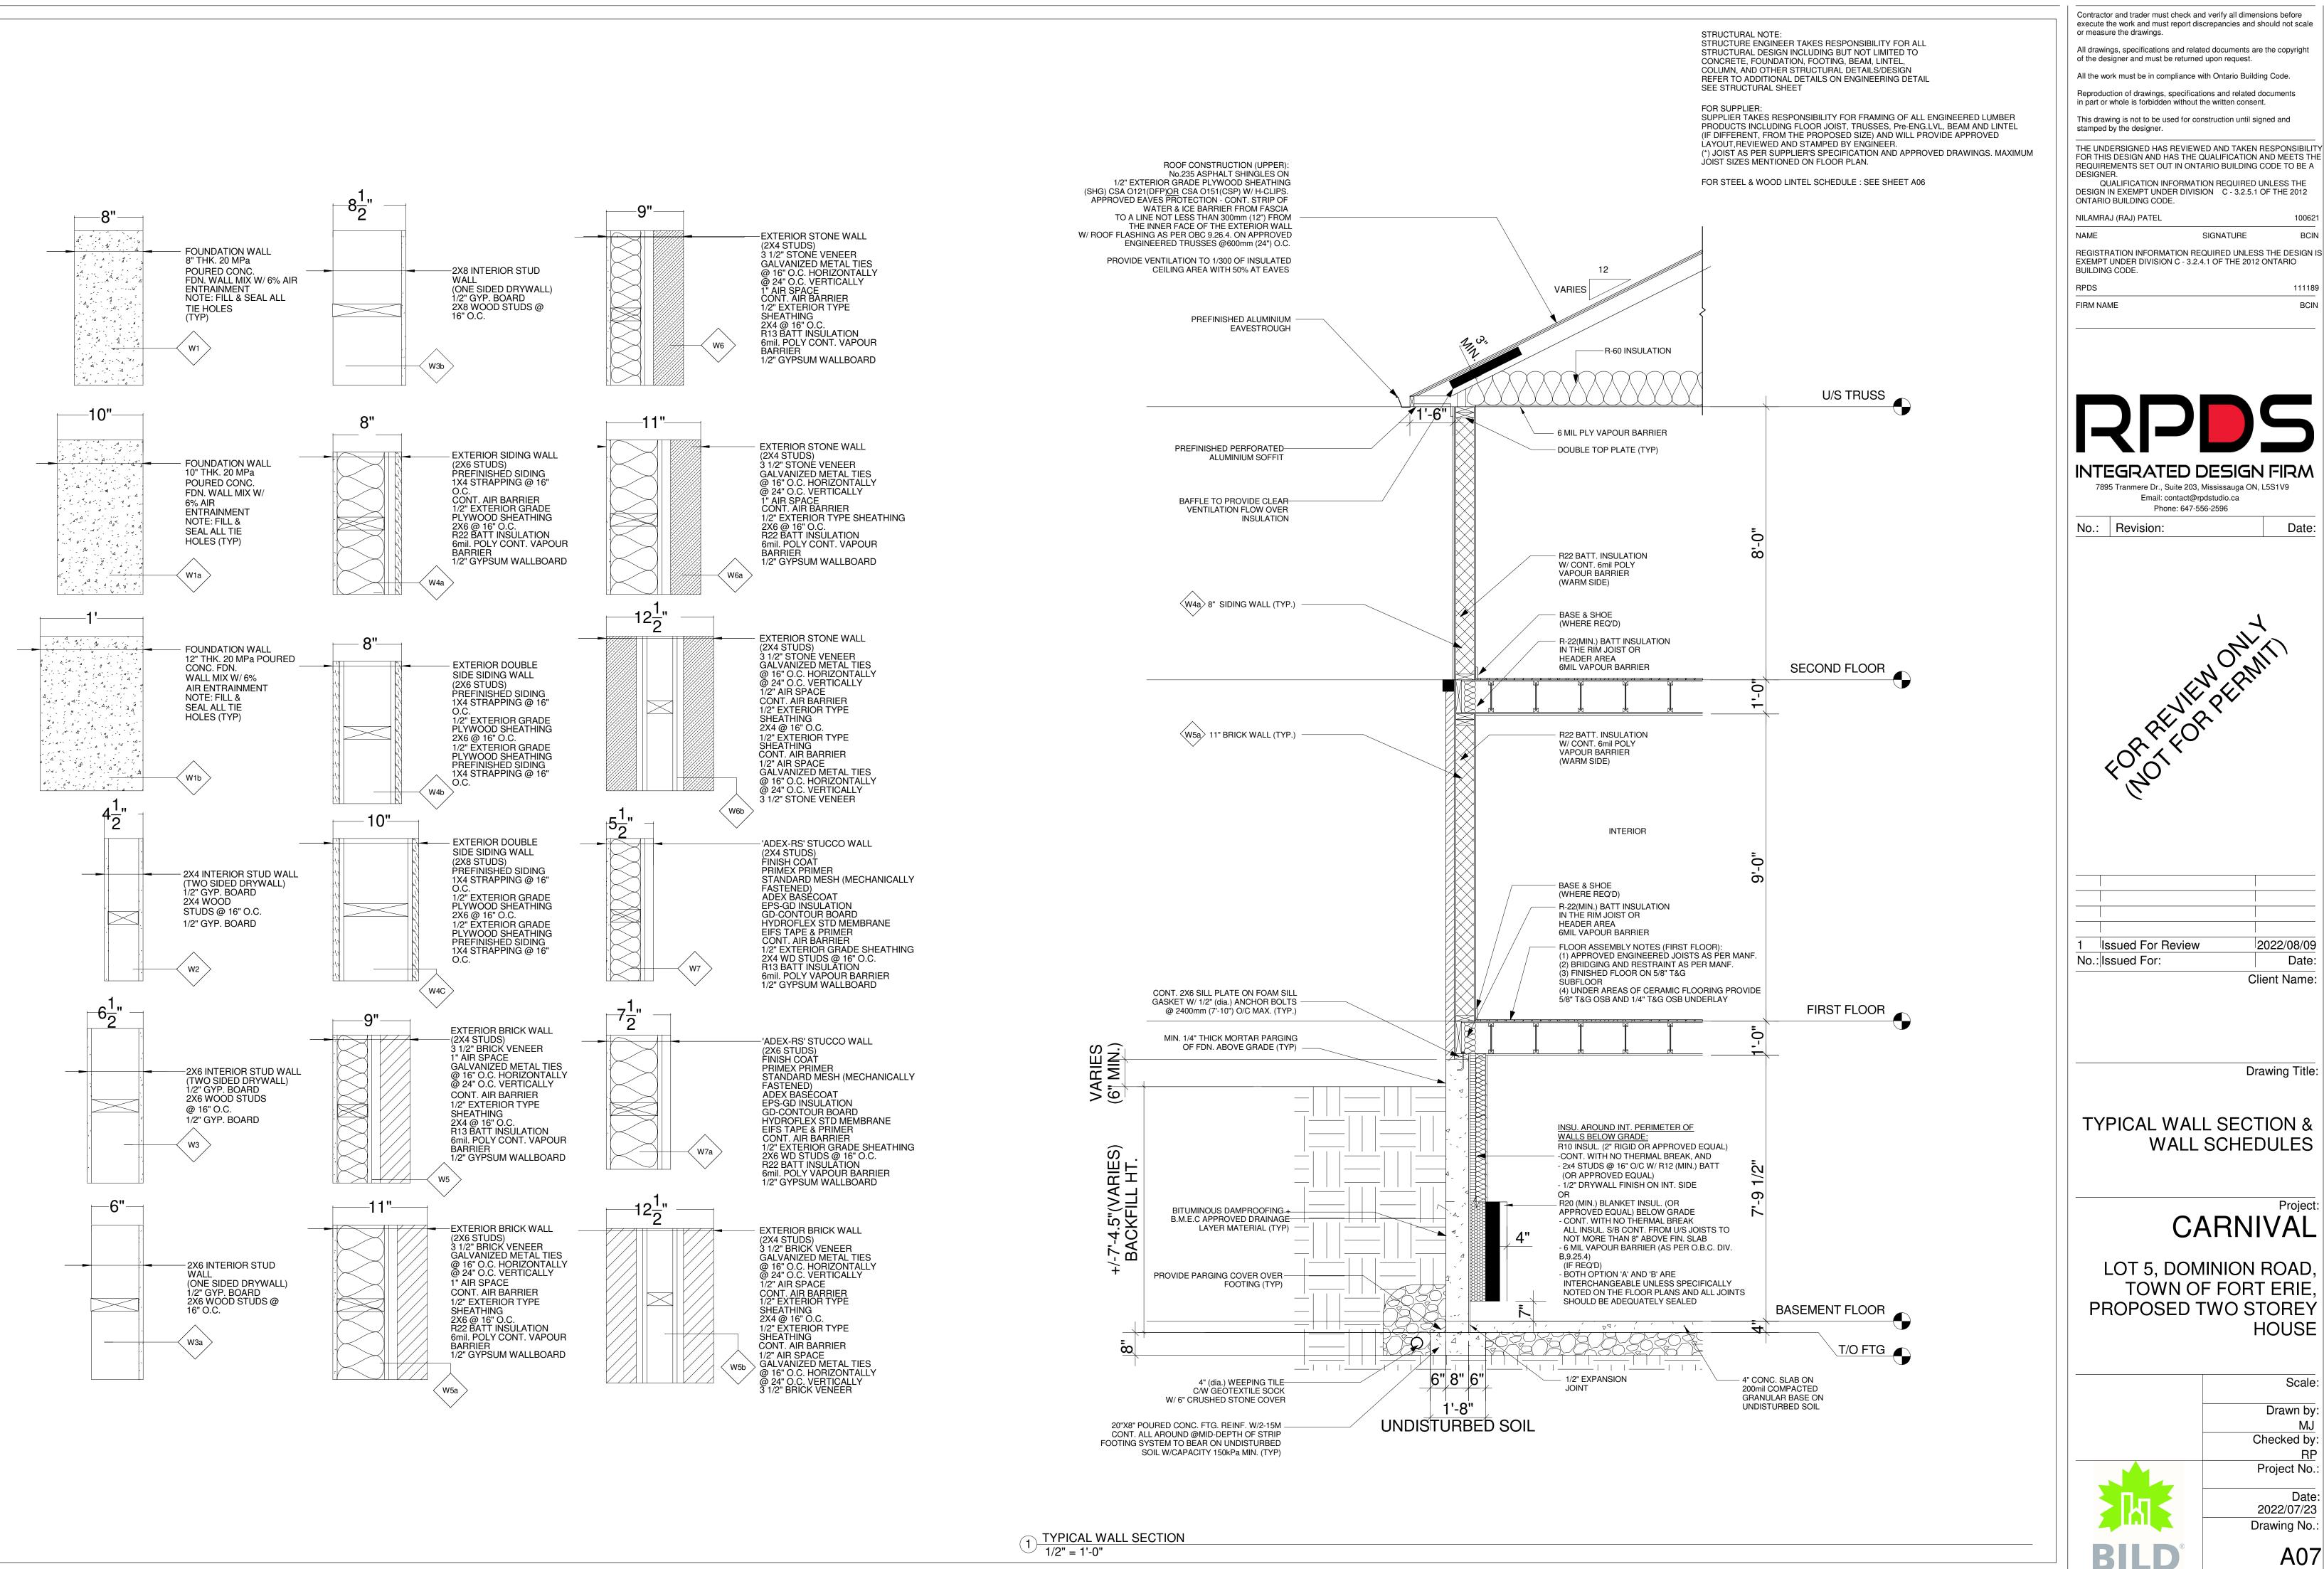

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NILAMRAJ (RAJ) PATEL SIGNATURE

EXEMPT UNDER DIVISION C - 3.2.4.1 OF THE 2012 ONTARIO BUILDING CODE.

BCIN

Date:



INTEGRATED DESIGN FIRM 7895 Tranmere Dr., Suite 203, Mississauga ON, L5S1V9

Email: contact@rpdstudio.ca

Phone: 647-556-2596 No.: Revision:

Issued For Review 2022/08/09 No.: Issued For: Date

Drawing Title:


Client Name:

TYPICAL WALL SECTION & WALL SCHEDULES

CARNIVAL

LOT 5, DOMINION ROAD. TOWN OF FORT ERIE. PROPOSED TWO STOREY HOUSE

Scale: Drawn by: Checked by: Project No.: Date: 2022/07/23 **Drawing No.:** A07

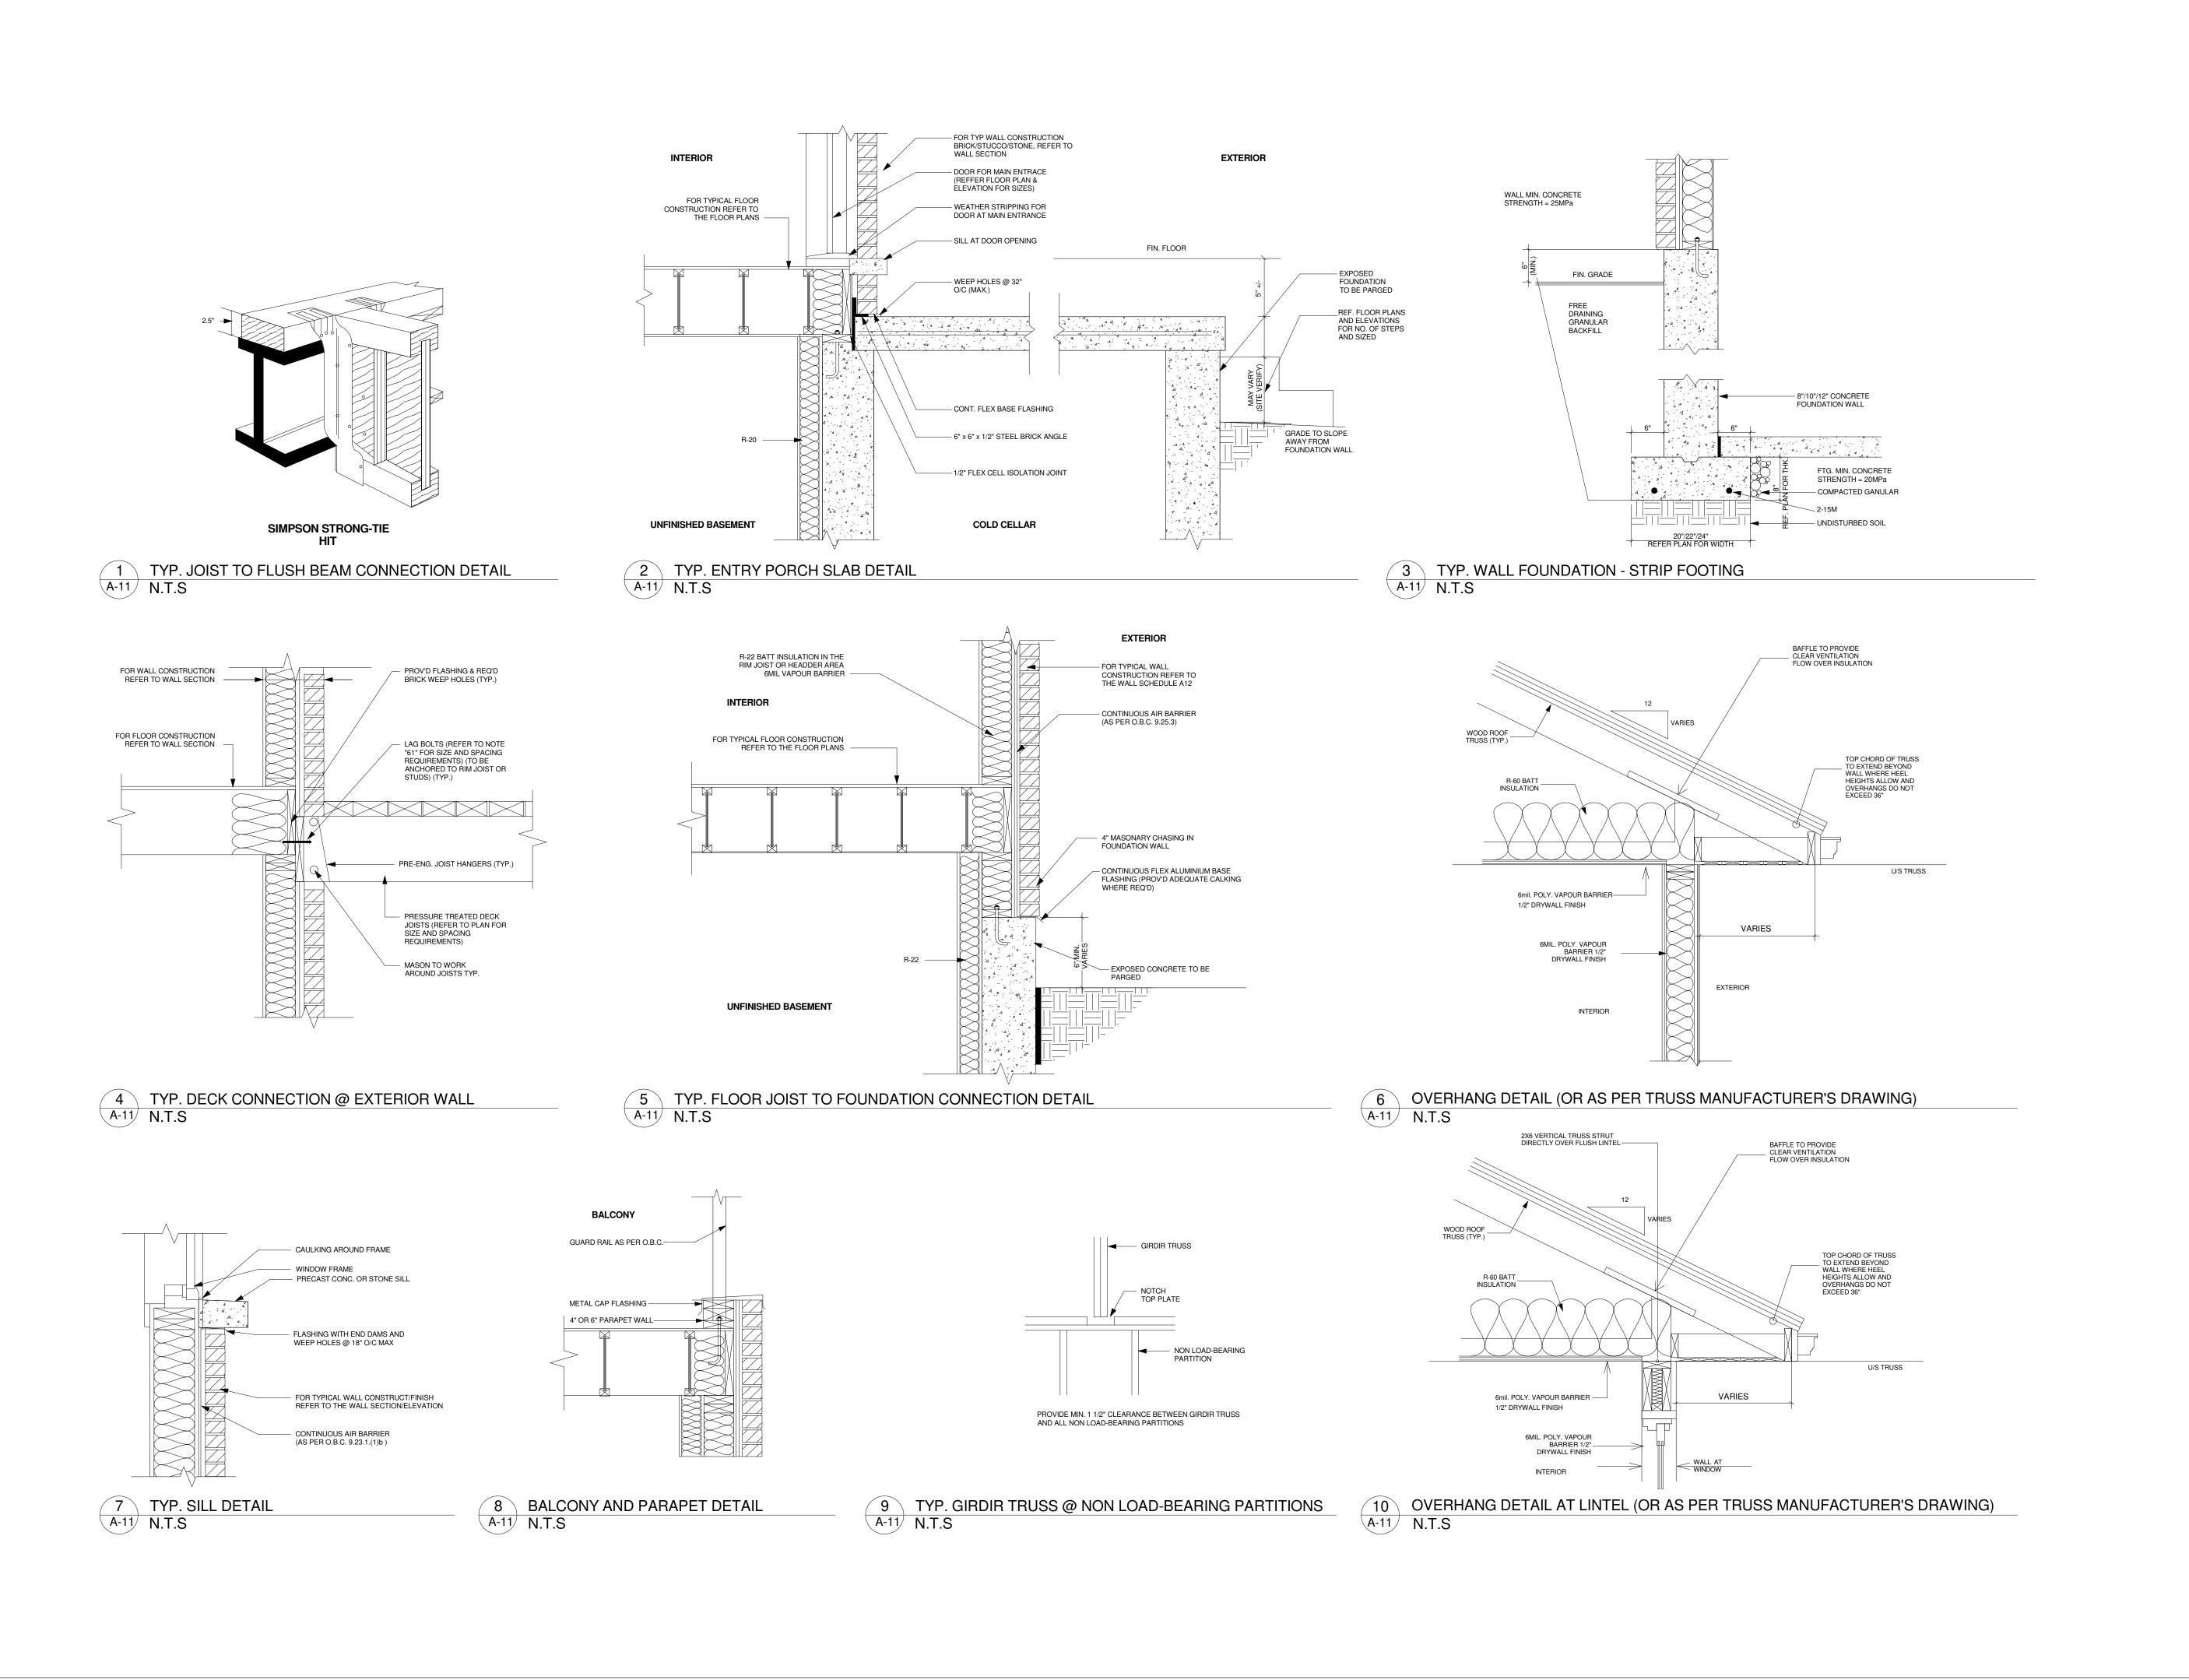

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NILAMRAJ (RAJ) PATEL
NAME SIGNATURE

EXEMPT UNDER DIVISION C - 3.2.4.1 OF THE 2012 ONTARIO BUILDING CODE.

RPDS 111189

FIRM NAME

REGISTRATION INFORMATION REQUIRED UNLESS THE DESIGN IS

BCIN

Date:

INTEGRATED DESIGN FIRM

7895 Tranmere Dr., Suite 203, Mississauga ON, L5S1V9

Email: contact@rpdstudio.ca Phone: 647-556-2596

No.: Revision:

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FOR REVIEW PERMIT

1 Issued For Review 2022/08/09
No.: Issued For: Date:

Drawing Title:

Client Name:

TYPICAL DETAILS

CARNIVAL

LOT 5, DOMINION ROAD, TOWN OF FORT ERIE, PROPOSED TWO STOREY HOUSE

Drawn by:

MJ
Checked by:
RP
Project No.:

Date:
2022/07/23
Drawing No.:

A08

EXCAVATION AND BACKFILL

EXCAVATION SHALL BE UNDERTAKEN IN SUCH A MANNER SO AS TO AVOID ANY DAMAGE TO EXISTING STRUCTURES ARROUND ADJACENT PROPERTY AND UTILITIES.

THE TOPSOIL AND VEGETABLE MATTER IN UNEXCAVATED AREAS UNDER A BUILDING SHALL BE REMOVED. THE BOTTOM OF EXCAVATIONS FOR FOUNDATIONS SHALL BE FREE OF ALL ORGANIC MATERIAL.

- IF TERMITES ARE KNOWN TO EXIST, ALL STUMPS, ROOTS AND WOOD DEBRIS SHALL BE REMOVED TO A MINIMUM DEPTH OF 11 3/4" IN EXCAVATED AREAS UNDER A BUILDING, AND THE CLEARANCE BETWEEN UNTREATED STRUCTURAL WOOD ELEMENTS AND THE GROUND SHALL BE NOT LESS THAN 17 3/4"

BACKFILL WITHIN 23 5/8" OF THE FOUNDATION WALLS SHALL BE FREE OF DELETERIOUS DEBRIS AND BOULDERS OVER 9 7/8" IN DIAMETER

DAMPPROOFING AND DRAINAGE

- IN NORMAL SOIL CONDITIONS, THE EXTERIOR SURFACES OF FOUNDATIONS WALLS ENCLOSING BASEMENTS AND CRAWL SPACES SHALL BE DAMPPROOFED. WHERE HYDROSTATIC PRESSURE OCCURS, A WATERPROOFING SYSTEM IS REQUIRED

MASONRY FOUNDATION WALLS SHALL BE PARGED WITH 1/4" OF MORTAR COVED OVER THE FOOTING PRIOR TO DAMPPROOFING.

-4" FOUNDATION DRAINS SHALL BE LAID ON LEVEL UNDISTURBED GROUND ADJACENT TO THE FOOTINGS AT OR BELOW THE TOP OF THE BASEMENT SLAB OR CRAWL SPACE FLOOR, AND SHALL BE COVERED WITH 6" OF CRUSHED STONE. FOUNDATION DRAINS SHALL DRAIN TO A STORM SEWER, DRAINAGE DITCH, DRY WELL OR SUMP.

WINDOW WELLS SHALL BE DRAINED TO THE FOOTING.

DOWNSPOUTS NOT DIRECTLY CONNECTED TO A STORM SEWER SHALL HAVE EXTENSIONS TO CARRY THE WATER AWAY FROM THE BUILDING, AND PROVISIONS SHALL BE MADE TO PREVENT SOIL EROSION.

CONCRETE SLABS IN ATTACHED GARAGES SHALL BE SLOPED TO DRAIN TO THE EXTERIOR.

THE BUILDING SITE SHALL BE GRADED SO THAT SURFACE, SUMP AND ROOF DRAINAGE WILL NOT ACCUMULATE AT OR NEAR THE BUILDING AND WILL NOT ADVERSELY AFFECT ADJACENT PROPERTIES.

FOUNDATION WALLS

- TO BE POURED CONCRETE, UNIT MASONRY OR PRESERVED WOOD (SEE DRAWINGS FOR TYPE AND THICKNESS)

- DAMPPROOFING SHALL BE A HEAVY COAT OF BITUMINOUS

- FOUNDATION WALL TO EXTEND MINIMUM 6" ABOVE FINISHED GRADE.

- A DRAINAGE LAYER IS REQUIRED ON THE OUTSIDE OF A FOUNDATION WALL WHERE THE INTERIOR INSULATION EXTENDS MORE THAN 2'-11" BELOW EXTERIOR GRADE. A DRAINAGE LAYER SHALL CONSIST OF: - MIN. 3/4" MINERAL FIBRE INSULATION WITH MIN

DENSITY OF 3.6LB/SF - MIN. 4" OF FREE DRAINAGE GRANULAR MATERIAL, OR - AN APPROVED SYSTEM WHICH PROVIDES EQUIVALENT

- FOUNDATION WALLS SHALL BE BRACED OR HAVE THE FLOOR JOISTS INSTALLED BEFORE BACKFILLING.

FOOTINGS

- MINIMUM 20 MPa POURED CONCRETE.

MINIMUM 48" BELOW FINISHED GRADE.

- FOOTINGS SHALL BE FOUNDED ON NATURAL UNDISTURBED SOIL ROCK OR COMPACTED GRANULAR FILL WITH MINIMUM BEARING

- INCREASE FOOTING WIDTH BY 2 5/8" FOR EACH STOREY OF BRICK VENEER SUPPORTED, AND BY 5 1/8" FOR EACH STOREY OF MASONRY.

THE PROJECTION OF AN UNREINFORCED FOOTING BEYOND THE WALI

SUPPORTED SHALL NOT BE GREATER THAN IT THICKNESS.

STEP FOOTINGS

- VERTICAL RISE 23 5/8" MAX. FOR FIRM SOILS 15 3/4" MAX. FOR SAND OR GRAVEL

- HORIZONTAL RUN 23 5/8" MIN.

CONCRETE FLOOR SLABS

- GARAGE, CARPORT AND EXTERIOR SLABS AND EXTERIOR STEPS SHALL BE 4650PSI (32MPa) CONCRETE WITH 5-8% AIR ENTRAINMENT C/W 6X6 WELDED WIRFMASH

- MINIMUM 5" THICK, PLACED ON A MINIMUM 4" OF COARSE, CLEAN, GRANULAR MATERIAL.

- ALL FILL OTHER THAN COARSE CLEAN MATERIAL PLACED BENEATH CONCRETE SLABS SHALL BE COMPACTED TO PROVIDE UNIFORM SUPPORT.

- MINIMUM 2 3/4" THICK IF JOINTS ARE NOT RAKED AND 3 1/2"

MASONRY VENEER

THICK IF JOINTS ARE RAKED.

MINIMUM 1" AIR SPACE TO SHEATHING.

PROVIDE WEEP HOLES @ 31 1/2" O.C. AT THE BOTTOM OF THE CAVITY AND OVER DOORS AND WINDOWS.

DIRECT DRAINAGE THROUGH WEEP HOLES WITH 20mil. POLY FLASHING EXTENDING MINIMUM 5 7/8" UP BEHIND THE SHEATHING

VENEER TIES MINIMUM 0.030" THICK X 7/8" WIDE CORROSION RESISTANT STRAPS SPACED @ 23 5/8" VERTICALLY AND 15 3/4" VERTICALLY.

FASTEN TIES WITH CORROSION RESISTANT 0.125" DIAMETER SCREWS OR SPIRAL NAILS WHICH PENETRATE AT LEAST 1 3/16" INTO STUDS.

MASONRY WALLS

- WHERE CONSTRUCTED OF 3 1/2" BRICK, WALL SHALL BE BONDED WITH HEADER COURSE EVERY 6TH COURSE.

- PROVIDE 2" SOLID MASONRY OR CONTINUOUS 1 1/2" PLATE UNDER ALL ROOF AND FLOOR FRAMING MEMBERS.

- PROVIDE 7 1/2" SOLID MASONRY UNDER BEAMS AND COLUMNS.

 MASONRY WALLS TO BE TIED TO EACH TIER OF JOISTS WITH 1 9/16" X 3/16" CORROSION RESISTANT STEEL STRAPS, KEYED MINIMUM 4" INTO MASONRY, WHEN JOISTS ARE PARALLEL TO WALL, TIES ARE TO EXTEND ACROSS AT LEAST 3 JOISTS @ 6'-7' O.C.

- INSIDE BACK OF WALL TO BE PARGED AND COVERED WITH No.15 BREATHER-TYPE ASPHALT PAPER.

- FOR REDUCED FOUNDATION WALLS TO ALLOW A BRICK FACING WHILE MAINTAINING LATERAL SUPPORT, TIE MINIMUM 3 1/2" BRICK TO MINIMUM 3 1/2" BACK-UP BLOCK WITH CORROSION RESISTANT TIES AT LEAST 0.028in2 IN CROSS SECTION AREA, SPACED 7 7/8" VERTICALLY AND 2'-11" HORIZONTALLY, WITH JOINTS COMPLETELY FILLED WITH MORTAR.

MASONRY OVER OPENINGS SHALL BE SUPPORTED ON CORROSION RESISTANT OR PRIME PAINTED STEEL LINTELS WITH A MINIMUM OF 5 7/8" END BEARING.

WOOD FRAME CONSTRUCTION

- ALL LUMBER SHALL BE SPRUCE-PINE-FIR No. 1&2, AND SHALL BE IDENTIFIED BY A GRADE STAMP.

- MAXIMUM MOISTURE CONTENT 19% AT TIME OF INSTALLATION.

- WOOD FRAMING MEMBERS WHICH ARE SUPPORTED ON CONCRETE IN DIRECT CONTACT WITH SOIL SHALL BE SEPARATED FROM THE CONCRETE WITH 6mil. POLYETHYLENE.

WALLS

- EXTERIOR WALLS SHALL CONSIST OF: CLADDING

- CONT. AIR BARRIER - 7/16" EXTERIOR GRADE SHEATHING

2X6 STUDS @ 16 O.C. - 2X6 BOTTOM PLATE AND DOUBLE 2X6 TOP PLATE

INTERIOR LOADBEARING WALLS SHALL CONSIST OF: - 2X4 STUDS @ 16" O.C. - 2X4 BOTTOM PLATE AND DOUBLE 2X4 TOP PLATE - 2X4 MID-GIRTS IF NOT SHEATHED · 1/2" GYPSUM WALLBOARD

FLOORS

- SEE FLOOR PLANS FOR FLOOR JOIST SIZE AND SPACING.

JOISTS TO HAVE MINIMUM 1 1/2" OF END BEARING. - JOISTS SHALL BEAR ON A SILL PLATE FIXED TO FOUNDATION WITH 1/2" ANCHOR BOLTS @ 7'-10" O.C.

- HEADER JOISTS BETWEEN 3'-11" AND 10'-6" IN LENGTH SHALL BE DOUBLED. HEADER JOISTS EXCEEDING 10'-6" SHALL BE SIZED BY CALCULATIONS.

TRIMMER JOISTS SHALL BE DOUBLED WHEN SUPPORTED HEADER IS BETWEEN 2'-7" AND 6'-7". TRIMMER JOISTS SHALL BE SIZED BY CALCULATIONS WHEN SUPPORTED HEADER

- 2X2 CROSS BRIDGING REQUIRED NOT MORE THAN 6'-11" FROM EACH SUPPORT AND FROM OTHER ROWS OF BRIDGING.

- JOISTS SHALL BE SUPPORTED ON JOIST HANGERS AT ALL FLUSH BEAMS, TRIMMERS, AND HEADERS.

JOISTS LOCATED UNDER PARALLEL NON-LOADBEARING PARTITIONS SHALL BE DOUBLED.

ROOFING

- FASTENERS FOR ROOFING SHALL BE CORROSION RESISTANT ROOFING NAILS SHALL PENETRATE THROUGH OR AT LEAST 1/2" INTO ROOF SHEATHING.

- EVERY ASPHALT SHINGLE SHALL BE FASTENED WITH AT LEAST

- EAVES PROTECTION SHALL EXTEND 2'-6" FROM THE INSIDE FACE OF THE EXTERIOR WALL, AND SHALL CONSIST OF TYPE M OR TYPE S ROLL ROOFING LAID MINIMUM 4" HEAD AND END LAPS CEMENTED TOGETHER, OR GLASS FIBRE OR POLYESTER FIBRE COATED BASE SHEETS OR SELF SEALING COMPOSITE MEMBRANES CONSISTING OF MODIFIED BITUMINOUS COATED MATERIAL. EAVE PROTECTION IS NOT REQUIRED FOR UNHEATED BUILDING.

OPEN VALLEYS SHALL BE FLASHED WITH 2 LAYERS OF ROLL ROOFING, OR 1 LAYER OF SHEET METAL MINIMUM 23 5/8" WIDE.

- FLASHING SHALL BE PROVIDED AT THE INTERSECTION OF SHINGLE ROOFS WITH EXTERIOR WALLS AND CHIMNEYS.

- SHEET METAL FLASHING SHALL CONSIST OF NOT LESS THAN 1/16" SHEET LEAD, 0.013" GALVANIZED STEEL, 0.018" COPPER, 0.018" ZINC, OR 0.019" ALUMINUM.

INSULATION & WEATHERPROOFING

- AS PER OBC SB-12 - PACKAGE A1

CEILING WITH ATTIC B60 **ROOF WITHOUT ATTIC R31 EXTERIOR WALL R22** FOUNDATION WALLR20 EXPOSED FLOORR31

SLABS ON GRADE R10 (UNHEATED) R 10 (HEATED) SUPPLY DUCTS IN UNHEATED SPACESR12

- INSULATION SHALL BE PROTECTED WITH GYPSUM WALLBOARD OR AN EQUIVALENT INTERIOR FINISH, EXCEPT FOR UNFINISHED BASEMENTS WHERE 6mil. POLY IS SUFFICIENT FOR FIBREGLASS TYPE INSULATIONS.

- DUCTS PASSING THROUGH UNHEATED SPACE SHALL BE MADE AIRTIGHT WITH TAPE OR SEALANT.

- CAULKING SHALL BE PROVIDED FOR ALL EXTERIOR DOORS AND WINDOWS BETWEEN THE FRAME AND THE EXTERIOR CLADDING.

- WEATHERSTRIPPING SHALL BE PROVIDED ON ALL DOORS AND ACCESS HATCHES TO THE EXTERIOR, EXCEPT DOORS FROM A

GARAGE TO THE EXTERIOR. EXTERIOR WALLS, CEILINGS AND FLOORS SHALL BE CONSTRUCTED SO AS TO PROVIDE A CONTINUOUS BARRIER TO THE PASSAGE OF WATER VAPOUR FROM THE INTERIOR AND TO THE LEAKAGE OF AIR FROM THE EXTERIOR

DOORS AND WINDOWS

EVERY FLOOR LEVEL CONTAINING A BEDROOM AND NOT SERVED BY AN EXTERIOR DOOR SHALL CONTAIN AT LEAST 1 WINDOW HAVING AN UNOBSTRUCTED OPEN AREA OF 3.8 SF AND NO DIMENSION LESS THAN 15", WHICH IS OPERABLE FROM THE INSIDE WITHOUT TOOLS.

- EXTERIOR HOUSE DOORS AND WINDOWS WITHIN 6'-7" FROM GRADE SHALL BE CONSTRUCTED TO RESIST FORCED ENTRY. DOORS SHALL HAVE A DEADBOLT LOCK.

THE PRINCIPAL ENTRY DOOR SHALL HAVE EITHER A DOOR VIEWER, TRANSPLANT GLAZING OR A SIDELIGHT.

COLUMNS, BEAMS & LINTELS

SUPPORTED MEMBER.

- STEEL BEAMS AND COLUMNS SHALL BE SHOP PRIMED.

MINIMUM 3 1/2" END BEARING FOR WOOD AND STEEL BEAMS, WITH 7 7/8" SOLID MASONRY BENEATH THE BEAM.

- STEEL COLUMNS TO HAVE A MINIMUM OUTSIDE DIAMETER OF 3 1/2" AND MINIMUM WALL THICKNESS OF 1/4".

- WOOD COLUMNS FOR CARPORTS AND GARAGES SHALL BE MINIMUM 3 1/2" X 3 1/2" IN ALL OTHER CASES EITHER 5 1/2" X 5 1/2" OR 7 1/4" ROUND, UNLESS CALCULATIONS BASED ON ACTUAL LOADS SHOW LESSER SIZES ARE ADEQUATE. ALL COLUMNS SHALL BE NOT LESS THAN THE WIDTH OF THE

- MASONRY COLUMNS SHALL BE MINIMUM OF 1 3/8" X 11 3/8" OR

- PROVIDE SOLID BLOCKING THE FULL WIDTH OF THE SUPPORTED MEMBER UNDER ALL CONCENTRATED LOADS.

NOTCHING & DRILLING OF TRUSSES, JOISTS, RAFTERS REFER TO DATA SHEET BY LVL

SMOKE AND CARBON MONOXIDE DETECTORS/ALARMS

AT LEAST ONE SMOKE ALARM SHALL BE INSTALLED ON OR NEAR THE CEILING ON EACH FLOOR AND BASEMENT LEVEL 2'-11" OR MORE ABOVE AN ADJACENT LEVEL.

SMOKE ALARMS SHALL BE INTERCONNECTED IN ELECTRICAL CIRCUIT WITH BATTERY BACKUP, AND LOCATED SUCH THAT ONE IS WITHIN 16'-5" OF EVERY BEDROOM DOOR, IN EVERY BEDROOM, AND NO MORE THAN 49'-3" TRAVEL DISTANCE FROM ANY POINT ON A FLOOR. SMOKE ALARMS SHALL HAVE A VISUAL SIGNALLING COMPONENT CONFORMING TO THE REQUIREMENTS OF NFPA 72 "NATIONAL FIRE ALARM AND SIGNALLING CODE"

A CARBON MONOXIDE DETECTOR SHALL BE INSTALLED ON OR NEAR THE CEILING IN EVERY ROOM CONTAINING A SOLID FUEL BURNING FIREPLACES OR STOVE.

GARAGE GASPROOFING

- THE WALLS AND CEILING OF AN ATTACHED GARAGE SHALL BE CONSTRUCTED AND SEALED SO AS TO PROVIDE AN EFFECTIVE BARRIER TO EXHAUST FUMES.

WALLS AND CEILING SHALL BE CAULKED - DOORS BETWEEN DWELLING AND ATTACHED GARAGE MAY

ALL PLUMBING AND OTHER PENETRATIONS THROUGH THE

NOT OPEN INTO A BEDROOM AND SHALL BE WEATHERSTRIPPED AND HAVE A SELF-CLOSER.

ROOF & CEILINGS

- SEE DRAWING A-03 FOR RAFTER, ROOF JOIST AND CEILING JOIST SIZE AND REQUIREMENTS.

- HIP AND VALLEY RAFTER SHALL BE 2" DEEPER THAN COMMON RAFTERS. - 2X4 COLLAR TIES @ RAFTER SPACING WITH 1X4 CONTINUOUS

BRACE AT MID SPAN IF COLLAR EXCEEDS 7'-10" IN LENGTH. - SEE DRAWING A-03 FOR ROOF SHEATHING REQUIREMENTS.

ACCESS TO ATTICS AND CRAWL SPACES

ACCESS HATCH MINIMUM 19 3/4" X 2'-4" TO BE PROVIDED TO EVERY CRAWL SPACE AND EVERY ROOF SPACE WHICH IS 108 SF OR MORE IN AREA AND MORE THAN 23 5/8" IN

STAIRS

MINIMUM WIDTH

- MINIMUM RISE 125 MM (OBC TABLE 9.8.4.1) - MINIMUM RUN 255 MM - MINIMI IM HEADROOM 1950 MM

(OBC 9.8.4.3) TAPERED STAIRS SHALL HAVE A RUN THAT a) IS NOT LESS THAN 150 MM AT THE NARROW END OF THE TREAD, & b) COMPLIES WITH THE DIMENSIONS FOR RECTANGULAR TREADS SPECIFIED IN TABLE 9.8.4.1. WHEN MEASURED AT A POINT 300 MM

(OBC 9.8.4.5)

FROM THE CENTRE LINE OF THE INSIDE HANDRAIL. WINDERS WHICH CONVERGE TO A POINT IN STAIRS MUST

860 MM

TURN THROUGH AN ANGLE OF NO MORE THAN 90(deg.), WITH NO LESS THAN 30(deg.) OR MORE THAN 45(deg.) PER TREAD. SETS OF WINDERS MUST BE SEPARATED BY 3'-11" ALONG THE RUN OF THE STAIR.

(OBC 9.8.6.3) - A LANDING SHALL BE a) AT LEAST AS WIDE AS THE WIDTH OF THE STAIR OR RAMP IN WHICH THEY OCCUR, AND b) AT LEAST AS LONG AS THE WIDTH OF THE STAIR OR RAMP IN WHICH THEY OCCUR.

THE CLEAR HEIGHT OVER LANDINGS SHALL BE NOT LESS THAN 1950 mm (OBC 9.8.6.4) STEPS IN SHALL BE NOT LESS THAN 1950 mm (OBC 9.8.2.2) STEPS IN SPIRAL STAIRS SHALL BE NOT LESS (OBC 9.8.4.5A) THAN 1980 mm

EXTERIOR CONCRETE STAIRS WITH MORE THAN 2 RISERS REQUIRE FOUNDATIONS.

HANDRAILS AND GUARDS

- A HANDRAIL IS REQUIRED FOR INTERIOR STAIRS CONTAINING MORE THAN 2 RISERS AND EXTERIOR STAIRS CONTAINING

GUARDS ARE REQUIRED AROUND EVERY ACCESSIBLE SURFACE WHICH IS MORE THAN 23 5/8" ABOVE THE ADJACENT LEVEL.

INTERIOR AND EXTERIOR GUARDS MIN. 2'-11 1/2" HIGH. EXTERIOR GUARDS SHALL BE 3'-6 1/8" HIGH WHERE HEIGHT ABOVE ADJACENT SURFACES EXCEEDS 5'-11"

GUARDS SHALL HAVE NO OPENINGS GREATER THAN 4" AND NO MEMBER BETWEEN 4" AND 2'-11 1/2" THAT WILL FACILITATE

PLUMBING - SEE FLOOR PLANS

EVERY DWELLING REQUIRES A KITCHEN SINK, LAVATORY WATER CLOSET, BATHTUB OR SHOWER STALL AND THE INSTALLATION OR AVAILABILITY OF LAUNDRY FACILITIES.

A FLOOR DRAIN SHALL BE INSTALLED IN THE BASEMENT AND CONNECTED TO THE SANITARY SEWER WHERE GRAVITY DRAINAGE IS POSSIBLE. IN OTHER CASES, IT SHALL BE CONNECTED TO A STORM DRAINAGE SYSTEM, DITCH OR

NATURAL VENTILATION

- EVERY ROOF SPACE ABOVE AN INSULATED CEILING SHALL BE VENTILATED WITH UNOBSTRUCTED OPENINGS EQUAL TO NOT LESS THAN 1/300 OF INSULATED AREA.

INSULATED ROOF SPACES NOT INCORPORATING AN ATTIC SHALL BE VENTILATED WITH UNOBSTRUCTED OPENINGS EQUAL TO NOT LESS THAN 1/150 OF INSULATED AREA.

ROOF VENTS SHALL BE UNIFORMLY DISTRIBUTED AND DESIGNED TO PREVENT THE ENTRY OF RAIN, SNOW OR INSECTS.

- UNHEATED CRAWL SPACES SHALL BE PROVIDED WITH 1.1 SF OF VENTILATION FOR EACH 538 SF.

MINIMUM NATURAL VENTILATION AREAS, WHERE MECHANICAL

VENTILATION IS NOT PROVIDED, ARE: BATHROOMS 0.97 SF OTHER ROOMS 3 SF UNFINISHED BASEMENTS 0.2% OF FLOOR AREA

EXTERIOR WALLS

- NO WINDOWS OR OTHER UNPROTECTED OPENINGS ARE PERMITTED IN EXTERIOR WALLS LESS THAN 3'-11" FROM PROPERTY LINES.

· 5/8" FIRE RATED DRYWALL SHALL BE INSTALLED ON THE INSIDE FACE OF ATTACHED GARAGE EXTERIOR WALLS AND GABLE ENDS OF ROOFS WHICH ARE LESS THAN 3'-11" FROM PROPERTY LINES.

- NON COMBUSTIBLE CLADDING SHALL BE INSTALLED ON ALL EXTERIOR WALLS LESS THAN 23 5/8" FROM PROPERTY

CERAMIC TILE WHEN CERAMIC TILE IS APPLIED TO A MORTAR BED WITH ADHESIVE, THE BED SHALL BE A MINIMUM OF 1/2" THICK & REINFORCED WITH GALVANIZED DIAMOND MESH LATH, APPLIED OVER POLYETHYLENE ON SUBFLOORING ON JOISTS

AT NO MORE THAN 16" O.C. WITH AT LEAST 2 ROWS OR

ELECTRICAL

CROSS BRIDGING.

- AN EXTERIOR LIGHT CONTROLLED BY AN INTERIOR SWITCH

A LIGHT CONTROLLED BY A SWITCH IS REQUIRED IN EVERY KITCHEN, BEDROOM, LIVING ROOM, UTILITY ROOM, LAUNDRY BOOM DINING BOOM BATHROOM VESTIBLILE HALLWAY GARAGE AND CARPORT. A SWITCHED RECEPTACLE MAY BE PROVIDED INSTEAD OF A LIGHT IN BEDROOMS AND LIVING ROOMS

UNFINISHED BASEMENT SHALL BE CONTROLLED BY A 3 WAY SWITCH AT THE HEAD AND FOOT OF THE STAIRS. - BASEMENTS REQUIRE A LIGHT FOR EACH 323 SF, CONTROLLED

- STAIRS SHALL BE LIGHTED. AND EXCEPT WHERE SERVING AN

MECHANICAL VENTILATION

BY A SWITCH AT THE HEAD OF THE STAIRS.

A MECHANICAL VENTILATION SYSTEM IS REQUIRED WITH A TOTAL CAPACITY AT LEAST EQUAL TO THE SUM OF: - 10 CFM EACH FOR BASEMENT AND MASTER BEDROOM - 5 CFM FOR EACH OTHER ROOM

A PRINCIPLE DWELLING EXHAUST FAN SHALL BE INSTALLED AND CONTROLLED BY A CENTRALLY LOCATED SWITCH IDENTIFIED AS SUCH.

SUPPLEMENTAL EXHAUST SHALL BE INSTALLED SO THAT

THE TOTAL CAPACITY OF ALL KITCHEN, BATHROOM AND OTHER EXHAUSTS. LESS THE PRINCIPAL EXHAUST, IS NOT LESS THAN THE TOTAL REQUIRE CAPACITY. A HEAT RECOVERY VENTILATOR MAY BE EMPLOYED IN LIEU

OF EXHAUST TO PROVIDE VENTILATION. AN HRV IS REQUIRED IF ANY SOLID FUEL BURNING APPLIANCES ARE INSTALLED. - SUPPLY AIR INTAKES SHALL BE LOCATED SO AS TO AVOID CONTAMINATION FROM EXHAUST OUTLETS.

FASTENERS FOR SHEATHING AND SUBFLOORING

O.B.C. 9.23.3.5

	MINIMUM LENGTH FOR FASTENERS, in				MINIMUM NUMBER OR	
ELEMENT	COMMON OR SPIRAL NAILS	RING THREAD NAILS OR SCREWS	ROOFING NAILS	STAPLES	MAXIMUM SPACING OF FASTENERS	
BOARD LUMBER 7 1/4" OR LESS WIDE	2"	1 3/4"	N/A	2"	2 PER SUPPORT	
BOARD LUMBER MORE THAN 7 1/4" WIDE	2"	1 3/4"	N/A	2"	2 PER SUPPORT	
FIBREBOARD SHEATHING UP TO 1/2" THICK	N/A	N/A	1 3/4"	1 1/8"		
GYPSUM SHEATHING UP TO 1/2" THICK	N/A	N/A	1 3/4"	N/A	5 7/8" O/C ALONG EDGES	
PLYWOOD, OSB OR WAFERBOARD UP TO 3/8" THICK	2"	1 3/4"	N/A	1 1/2"	AND 11 3/4" O/C ALONG INTERMEDIATE SUPPORTS	
PLYWOOD, OSB OR WAFERBOARD FROM 3/8" TO 13/16" THICK	2"	1 3/4"	N/A	2"		
PLYWOOD, OSB, OR WAFERBOARD OVER 13/16" THICK	2 1/4"	2"	N/A	N/A		

DRAWING NOTES

1. FINISHED FLOOR ELEVATION 0'-0" SHOWN ON ARCHITECTURAL DRAWINGS REFERS TO TOP OF PLYWOOD SUBFLOORING, AND REFERENCE SURVEYOR OF RECORD DOCUMENTS FOR ELEVATION ABOVE SEA LEVEL.

2. WHEN REFERENCE IS MADE TO A PARTICULAR MANUFACTURED SYSTEM, ALL PARTS AND MATERIALS APPLICABLE SHALL BE SUPPLIED AND INSTALLED.

3. IF THE CONTRACTOR OBSERVES ANY ERRORS, DISCREPANCIES, OR OMISSIONS IN THE CONTRACT DOCUMENTS, HE SHALL PROMPTLY NOTIFY THE LICENSED DESIGNER. THE CONTRACTOR PROCEEDS WITH WORK AFFECTED BY SUCH ERRORS, DISCREPANCIES, OR OMISSIONS WITHOUT RECEIVING CLARIFICATION, HE DOES SO AT HIS OWN SUCH CIRCUMSTANCES MADE BY THE CONTRACTOR, PRIOR TO APPROVAL BY RISK. ANY ADJUSTMENTS INVOLVING THE LICENSED DESIGNER, SHALL BE AT THE CONTRACTOR'S RISK AND ANY COMPLICATIONS OR DISPUTES ARISING THEREFROM SHALL BE AT THE CONTRACTOR'S EXPENSE.

4. EXIT DOORS SHALL BE OPERABLE FROM THE INSIDE WITHOUT USE OF A KEY, TOOL OR SPECIAL KNOWLEDGE.

5. FIRE DEPARTMENT ACCESS AND WATER TO SITE SHALL BE MAINTAINED DURING CONSTRUCTION.

6. MAINTAIN MINIMUM 6" VERTICAL DISTANCE BETWEEN FINISH FLOOR AND ADJACENT GRADES, SLOPE MIN. 2%. 7. GLAZING IN DOORS, ADJACENT TO DOORS, AND CLOSER THAN 18" TO FINISH FLOOR SHALL BE TEMPERED.

8. THE CONTRACTOR SHALL PROVIDE ALL WORK NECESSARY TO COMPLETE A WEATHER TIGHT, FINISHED PRODUCT.

9. ALL WORK SHALL COMPLY WITH ALL APPLICABLE CODES AND ORDINANCES.

10. CONTRACTORS SHALL TAKE ALL NECESSARY PRECAUTIONARY MEASURES TO PROTECT THE PUBLIC AND ADJACENT PROPERTIES FROM DAMAGE THROUGHOUT CONSTRUCTION.

12. THE STARTING OF WORK BY ANY CONTRACTOR OR SUB-CONTRACTOR SHALL BE CONSIDERED PRIMA FACIE EVIDENCE THAT HE HAS INSPECTED AND

11. THE CONTRACTOR SHALL VERIFY THE LOCATION OF ALL UTILITIES BEFORE STARTING WORK.

ACCEPTED ALL CONDITIONS INVOLVED IN HIS WORK AND FINDS THEM SATISFACTORY. 13. ALL COMPONENTS, EQUIPMENT, PRODUCTS SHALL BE INSTALLED PER LICENSED DESIGNER AND MANUFACTURERS PRINTED INSTRUCTIONS.

14. AT THE JUNCTURE OF ALL DISSIMILAR MATERIALS, PROVIDE PROTECTIVE SEALANT TO COATINGS AS APPLICABLE PER PLANS AND SPECS.

15. PROVIDE ALL FIRE BLOCKING, FIRE STOPS AND DRAFT STOPS IN FLOORS, WALLS, PLENUMS AND ATTICS AS REQUIRED BY CODE.

17. DOORS AND WINDOWS ARE TO COMPLY WITH "RESISTANCE TO FORCED ENTRY" REQUIREMENTS - OBC 9.6.6.

18. LIGHTING AND ELECTRICAL FACILITIES - OBC 9.34. 19. GRAB BAR REINFORCEMENT & GRAB BAR INSTALLATION SPECIFCATIONS SHALL BE AS PER OBC 3.8.38.

16. ANY CHANGE IN ALL PLANS OR SPECS MUST BE FIRST APPROVED BY LICENSED DESIGNER IN WRITING.

	_NFHB	NON-FREEZE HOSE BIB
		EXHAUST FAN
FD	FD	FLOOR DRAIN
	SD	SMOKE DETECTOR (INTERCONNECTED)
	СО	CARBON MONOXIDE DETECTOR (INTERCONNECTED)
	SB	SOLID BEARING
Χ	PLA	POINT LOAD ABOVE

	ACRONYMS
A B	ANCHOR BOLT
AFF	ABOVE FINISHED FLOOR
BRG. PL	BEARING PLATE
DJ	DOUBLE JOIST
EST	ESTIMATED
E.I.F.S	EXTERIOR INSULATION FINISH SYSTEM
FDN	FOUNDATION
FD	FLOOR DRAIN
FTG	FOOTING
GT	GIRDER TREATED LUMBER
HRV	HEAT RETURN VENTILATION UNIT
HWT	HOT WATER TANK
LVL	LAMINATED VENEER LUMBER
ОН	OVERHEAD
PLA	POINT LOAD ABOVE
PT	PRESSURE TREATED LUMBER
PWDR	POWDER ROOM
REQ'D	REQUIRED
RO	ROUGH OPENING
RT	ROOF TRUSS
SPEC.	SPECIFICATIONS
TJ	TRIPLE JOIST
TYP	TYPICAL
T/O	TOP OF
U/S	UNDER SIDE
WD	WOOD
W.I.C	WALK IN CLOSET
O.H	OVER HANG
	•

ANCHOR BOLT SPACING

O.B.C. TABLE 9.20.17.5

MAX CLEAR FLOOR SPAN	STAGGERED 1/2" ANCHOR BOLTS	STAGGERED 5/8" ANCHOR BOLTS
8'-0"	18"	20"
9'-10"	16"	18"
13'-1.5"	12"	16"
16'-4"	11"	13"

2" EDGE LAID PLANK TO EACHOTHER

NAILING FOR FRAMING

O.B.C. 9.23.3.4

CONSTRUCTION DETAIL	MINIMUM LENGTH OF NAILS, in	MINIMUM NUMBER OR MAXIMUM SPACING OF NAILS
FLOOR JOISTS TO PLATE - TOE NAIL	3 1/4"	2
WOOD OR METAL STRAPPING TO UNDERSIDE OF FLOOR JOISTS	2 1/4"	2
CROSS BRIDGING TO JOISTS	2 1/4"	2 AT EACH END
DOUBLE HEADER OR TRIMMER JOISTS	3"	11 3/4" O/C
FLOOR JOIST TO STUD (BALLOON CONSTRUCTION)	3"	2
LEDGER STRIP TO WOOD BEAM	3 1/4"	2 PER JOIST
JOIST TO JOIST SPLICE (SEE ALSO TABLE 9.23.13.8)	3"	2 AT EACH END
HEADER JOIST END NAILED TO JOISTS ALONG PERIMETER	4"	3
TAIL JOIST TO ADJACENT HEADER JOIST (END NAILED) AROUND OPENINGS	3 1/4"	5 3
EACH HEADER JOIST TO ADJACENT TRIMMER	3 1/4"	5
JOIST (END NAILED) AROUND OPENINGS	4"	3
STUD TO WALL PLATE (EACH END) TOE NAIL OR END NAIL	2 1/2"	2
DOUBLED STUDS AT OPENINGS, OR STUDS AT WALLS OR WALL INTERSECTIONS AND CORNERS	3"	30" O/C
DOUBLED TOP WALL PLATES	3"	23 5/8" O/C
BOTTOM WALL PLATE OR SOLE PLATE TO JOISTS OR BLOCKING (EXTERIOR WALLS)	3 1/4"	15 3/4" O/C
INTERIOR WALLS TO FRAMING OR SUBFLOORING	3 1/4"	23 5/8" O/C
HORIZONTAL MEMBER OVER OPENINGS IN NON-LOADBEARING WALLS - EACH END	3 1/4"	2
LINTELS TO STUDS	3 1/4"	2 AT EACH END
CEILING JOIST TO PLATE - TOE NAIL EACH END	3 1/4"	2
ROOF RAFTER, ROOF TRUSS OR ROOF JOIST TO PLATE - TOE NAIL	3 1/4"	3
RAFTER PLATE TO EACH CEILING JOIST	4"	2
RAFTER TO JOIST (WITH RIDGE SUPPORTED)	3"	3
RAFTER TO JOIST (WITH RIDGE UNSUPPORTED)	3"	SEE O.B.C. TABLE 9.23.13.8
GUSSET PLATE TO EACH RAFTER AT PEAK	2 1/4"	4
RAFTER AT RIDGE BOARD - TOE NAIL - END NAIL	3 1/4"	3
COLLAR TIE TO RAFTER - EACH END	3"	3
COLLAR TIE LATERAL SUPPORT TO EACH COLLAR TIE	2 1/4"	2
JACK RAFTER TO HIP OR VALLEY RAFTER	3 1/4"	2
ROOF STRUT TO RAFTER	3"	3
ROOF STRUT TO LOADBEARING WALL - TOE NAIL	3 1/4"	2
2" x 6" OR LESS PLANK DECKING TO SUPPORT	3 1/4"	2
PLANK DECKING WIDER THAN 2" x 6" TO SUPPORT	3 1/4"	3
2" EDGE LAID PLANK DECKING TO SUPPORT (TOE NAIL)	3"	1

Contractor and trader must check and verify all dimensions before execute the work and must report discrepancies and should not scale or measure the drawings

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DESIGN IN EXEMPT UNDER DIVISION C - 3.2.5.1 OF THE 2012 ONTARIO BUILDING CODE. NILAMRAJ (RAJ) PATEL SIGNATURE BCIN

EXEMPT UNDER DIVISION C - 3.2.4.1 OF THE 2012 ONTARIO BUILDING CODE.

REGISTRATION INFORMATION REQUIRED UNLESS THE DESIGN IS

FIRM NAME



7895 Tranmere Dr., Suite 203, Mississauga ON, L5S1V9 Email: contact@rpdstudio.ca Phone: 647-556-2596

Date:

Issued For Review 2022/08/09

No.: Issued For:

Date

Client Name:

Drawing Title:

GENERAL NOTES

LOT 5, DOMINION ROAD TOWN OF FORT ERIE PROPOSED TWO STOREY

> Checked by: Project No.:

17 3/4" O/C

2022/07/23 Drawing No.

A09

Scale:

Drawn by:

DOOR SCHEDULE			
Mark	Width	Height	
D 1	2' - 8''	6' - 8''	
D2	5' - 0''	8' - 0''	
D3	16' - 0''	7' - 0''	
D4	2' - 8''	6' - 8''	
D5	2' - 8''	6' - 8''	
D6	5' - 0''	6' - 8''	
D7	5' - 0''	6' - 8''	
D8	2' - 8''	6' - 8''	
D9	2' - 4''	6' - 8''	
D10	2' - 4''	6' - 8''	
D11	3' - 0''	7' - 0''	
D12	2' - 4''	6' - 8''	
D13	2' - 4''	6' - 8''	
D14	2' - 4''	6' - 8''	
D15	4' - 0''	6' - 8''	
D16	2' - 8''	6' - 8''	
D17	2' - 8''	6' - 8''	
D18	2' - 4''	6' - 8''	
D19	2' - 8''	6' - 8''	
D20	2' - 8''	6' - 8''	
D21	5' - 0''	6' - 8''	
D22	5' - 0''	6' - 8''	

WIND	WINDOW SCHEDULE				
Mark	Width	Height			
	I				
W1	2' - 6''	2' - 0''			
W2	2' - 6''	2' - 0"			
W3	3' - 11"	2' - 8"			
W4	2' - 6''	2' - 0"			
W5	2' - 6''	2' - 0"			
W6	2' - 0''	3' - 0"			
W7	4' - 0''	5' - 0''			
W8	5' - 0''	3' - 0"			
W9	5' - 0''	5' - 0''			
W10	2' - 0''	5' - 0''			
W11	2' - 0''	5' - 0''			
W12	2' - 0''	7' - 0''			
W13	2' - 0''	7' - 0''			
W14	2' - 0''	4' - 0''			
W15	2' - 0''	3' - 0"			
W16	2' - 0''	5' - 0''			
W17	5' - 0''	5' - 0''			
W18	5' - 0''	5' - 0''			
W19	3' - 0''	3' - 0''			
W20	5' - 0''	5' - 0''			
W21	5' - 0''	5' - 0''			
W22	1' - 6''	1' - 6"			
W23	1' - 6''	1' - 6"			

DOOR & WINDOW SCHEDULES ARE FOR REFRENCE ONLY.
DESIGNER IS NOT LIABLE FOR ANY DISCREPANCY.

WINDOW SUPPLIER TO ENSURE DOORS & WINDOWS ARE AS PER OBC STANDARD INCLUDING MINIMUM OPENABLE OPENINGS

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FOR THIS DESIGN AND HAS THE QUALIFICATION AND MEETS THE REQUIREMENTS SET OUT IN ONTARIO BUILDING CODE TO BE A DESIGNER.

QUALIFICATION INFORMATION REQUIRED UNLESS THE DESIGN IN EXEMPT UNDER DIVISION C - 3.2.5.1 OF THE 2012

THE UNDERSIGNED HAS REVIEWED AND TAKEN RESPONSIBILITY

NILAMRAJ (RAJ) PATEL 100

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FIRM NAME



TRATED DESIGN FIRM
7895 Tranmere Dr., Suite 203, Mississauga ON, L5S1V9
Email: contact@rpdstudio.ca

Phone: 647-556-2596

No.: Revision:

FOR PERMIT

1 Issued For Review 2022/08/09
No.: Issued For: Date:

Date:

Drawing Title:

A10

DOOR & WINDOW SCHEDULE

CARNIVAL

LOT 5, DOMINION ROAD, TOWN OF FORT ERIE, PROPOSED TWO STOREY HOUSE

Scale
Drawn by
MJ
Checked by
RP
Project No.
Date 2022/07/23
Drawing No.
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