



RPDS
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(ARTISTIC EXPRESSION VIEW)

Sheet List	
Sheet Number	Sheet Name
A00	COVER SHEET
A01	SITE PLAN
A02	BASEMENT & FIRST FLOOR PLAN
A03	SECOND FLOOR & ROOF PLAN
A04	FRONT & RIGHT SIDE ELEVATION
A05	REAR & LEFT SIDE ELAVATION
A06	HOUSE SECTIONS & LINTEL SCHEDULES
A07	TYPICAL WALL SECTION & WALL SCHEDULES
A08	TYPICAL DETAILS
A09	GENERAL NOTES
A10	DOOR & WINDOW SCHEDULE

SB-12 ENERGY EFFICIENCY DESIGN MATRIX		
PERFORMANCE COMPLIANCE		
SPACE HEATING FUEL		
<input checked="" type="checkbox"/> GAS <input type="checkbox"/> OIL <input type="checkbox"/> ELECTRIC <input type="checkbox"/> PROPANE <input type="checkbox"/> EARTH <input type="checkbox"/> SOLID FUEL		
BUILDING COMPONENT	REQUIRED	PROPOSED
INSULATION RSI (R) VALUE		
CEILING W/ ATTIC SPACE	10.56 (R60)	10.56 (R60)
CEILING W/O ATTIC SPACE	5.46 (R31)	5.46 (R31)
EXPOSED FLOOR	5.46 (R31)	5.46 (R31)
WALLS ABOVE GRADE	3.87 (R22)	3.87 (R22)
BASEMENT WALLS	3.52 ci (R20 ci)	3.52 ci (R20 ci)
BELOW GRADE SLAB ENTIRE SURFACE >600mm BELOW GRADE	-	-
EDGE OF BELOW GRADE SLAB < 600mm BELOW GRADE	1.76 (R10)	1.76 (R10)
HEATED SLAB < 600mm BELOW GRADE	1.76 (R10)	1.76 (R10)
WINDOWS & DOORS		
WINDOWS SLIDING GLASS DOORS (MAX U-VALUE / MIN. ER)	1.6	1.6
SKYLIGHTS (MAX. U-VALUE)	2.8	2.8
APPLIANCE EFFICIENCY		
SPACE HEATING EQUIP. (AFUE%)	96%	96%
HRV. EFFICIENCY (%)	75%	75%
DHW HEATER (EF)	0.80	0.80

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NILAMRAJ (RAJ) PATEL 100621
NAME SIGNATURE BCIN

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RPDS 111189
FIRM NAME BCIN

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INTEGRATED DESIGN FIRM
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No.: Revision: Date:

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2 Issued For Review 2022/07/30
1 Issued For Review 2022/06/30
No.: Issued For: Date:

Client Name:

Drawing Title:

COVER SHEET

Project:

LOT-36
PARKER AVENUE, TOWN
OF FORT ERIE, PROPOSED
TWO STOREY HOUSE

Scale:

Drawn by: MJ
Checked by: RP
Project No.:

Date: 2022/05/14
Drawing No.:



A00

COLUMN/POST	
COLUMN TYPE	COLUMN SIZE
C1	HSC 102DIA X6.4 (FOR BASE PLATE AND ANCHOR BOLT SPECS, REFER TO STRUCTURAL DRAWINGS)
C2	HSS 102X102X4.8 (FOR BASE PLATE AND ANCHOR BOLT SPECS, REFER TO STRUCTURAL DRAWINGS)
C3	HSS 127X127X4.8(5"X5"X3/16") (FOR BASE PLATE AND ANCHOR BOLT SPECS, REFER TO STRUCTURAL DRAWINGS)
P1	6X6 S-P-F NO.2
P2	2-2X6 S-P-F
P3	3-2X6 S-P-F
P4	4-2X6 S-P-F

STRUCTURAL NOTE:
 STRUCTURE ENGINEER TAKES RESPONSIBILITY FOR ALL STRUCTURAL DESIGN INCLUDING BUT NOT LIMITED TO CONCRETE, FOUNDATION, FOOTING, BEAM, LINTEL, COLUMN, AND OTHER STRUCTURAL DETAILS/DESIGN. REFER TO ADDITIONAL DETAILS ON ENGINEERING DETAIL. SEE STRUCTURAL SHEET.

FOR SUPPLIER:
 SUPPLIER TAKES RESPONSIBILITY FOR FRAMING OF ALL ENGINEERED LUMBER PRODUCTS INCLUDING FLOOR JOIST, TRUSSES, Pre-ENG. LVL, BEAM AND LINTEL (IF DIFFERENT, FROM THE PROPOSED SIZE) AND WILL PROVIDE APPROVED LAYOUT, REVIEWED AND STAMPED BY ENGINEER.
 (*) JOIST AS PER SUPPLIER'S SPECIFICATION AND APPROVED DRAWINGS. MAXIMUM JOIST SIZES MENTIONED ON FLOOR PLAN.

FOR STEEL & WOOD LINTEL SCHEDULE : SEE SHEET A06

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NILAMRAJ (RAJ) PATEL 100621
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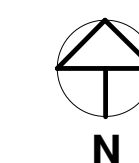
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Drawing Title:



SECOND FLOOR & ROOF PLAN

Project:

LOT-36
 PARKER AVENUE, TOWN OF FORT ERIE, PROPOSED TWO STOREY HOUSE

 N	Scale:
	Drawn by:
	Checked by:
	Project No.:

Date:	2022/05/14
Drawing No.:	A03

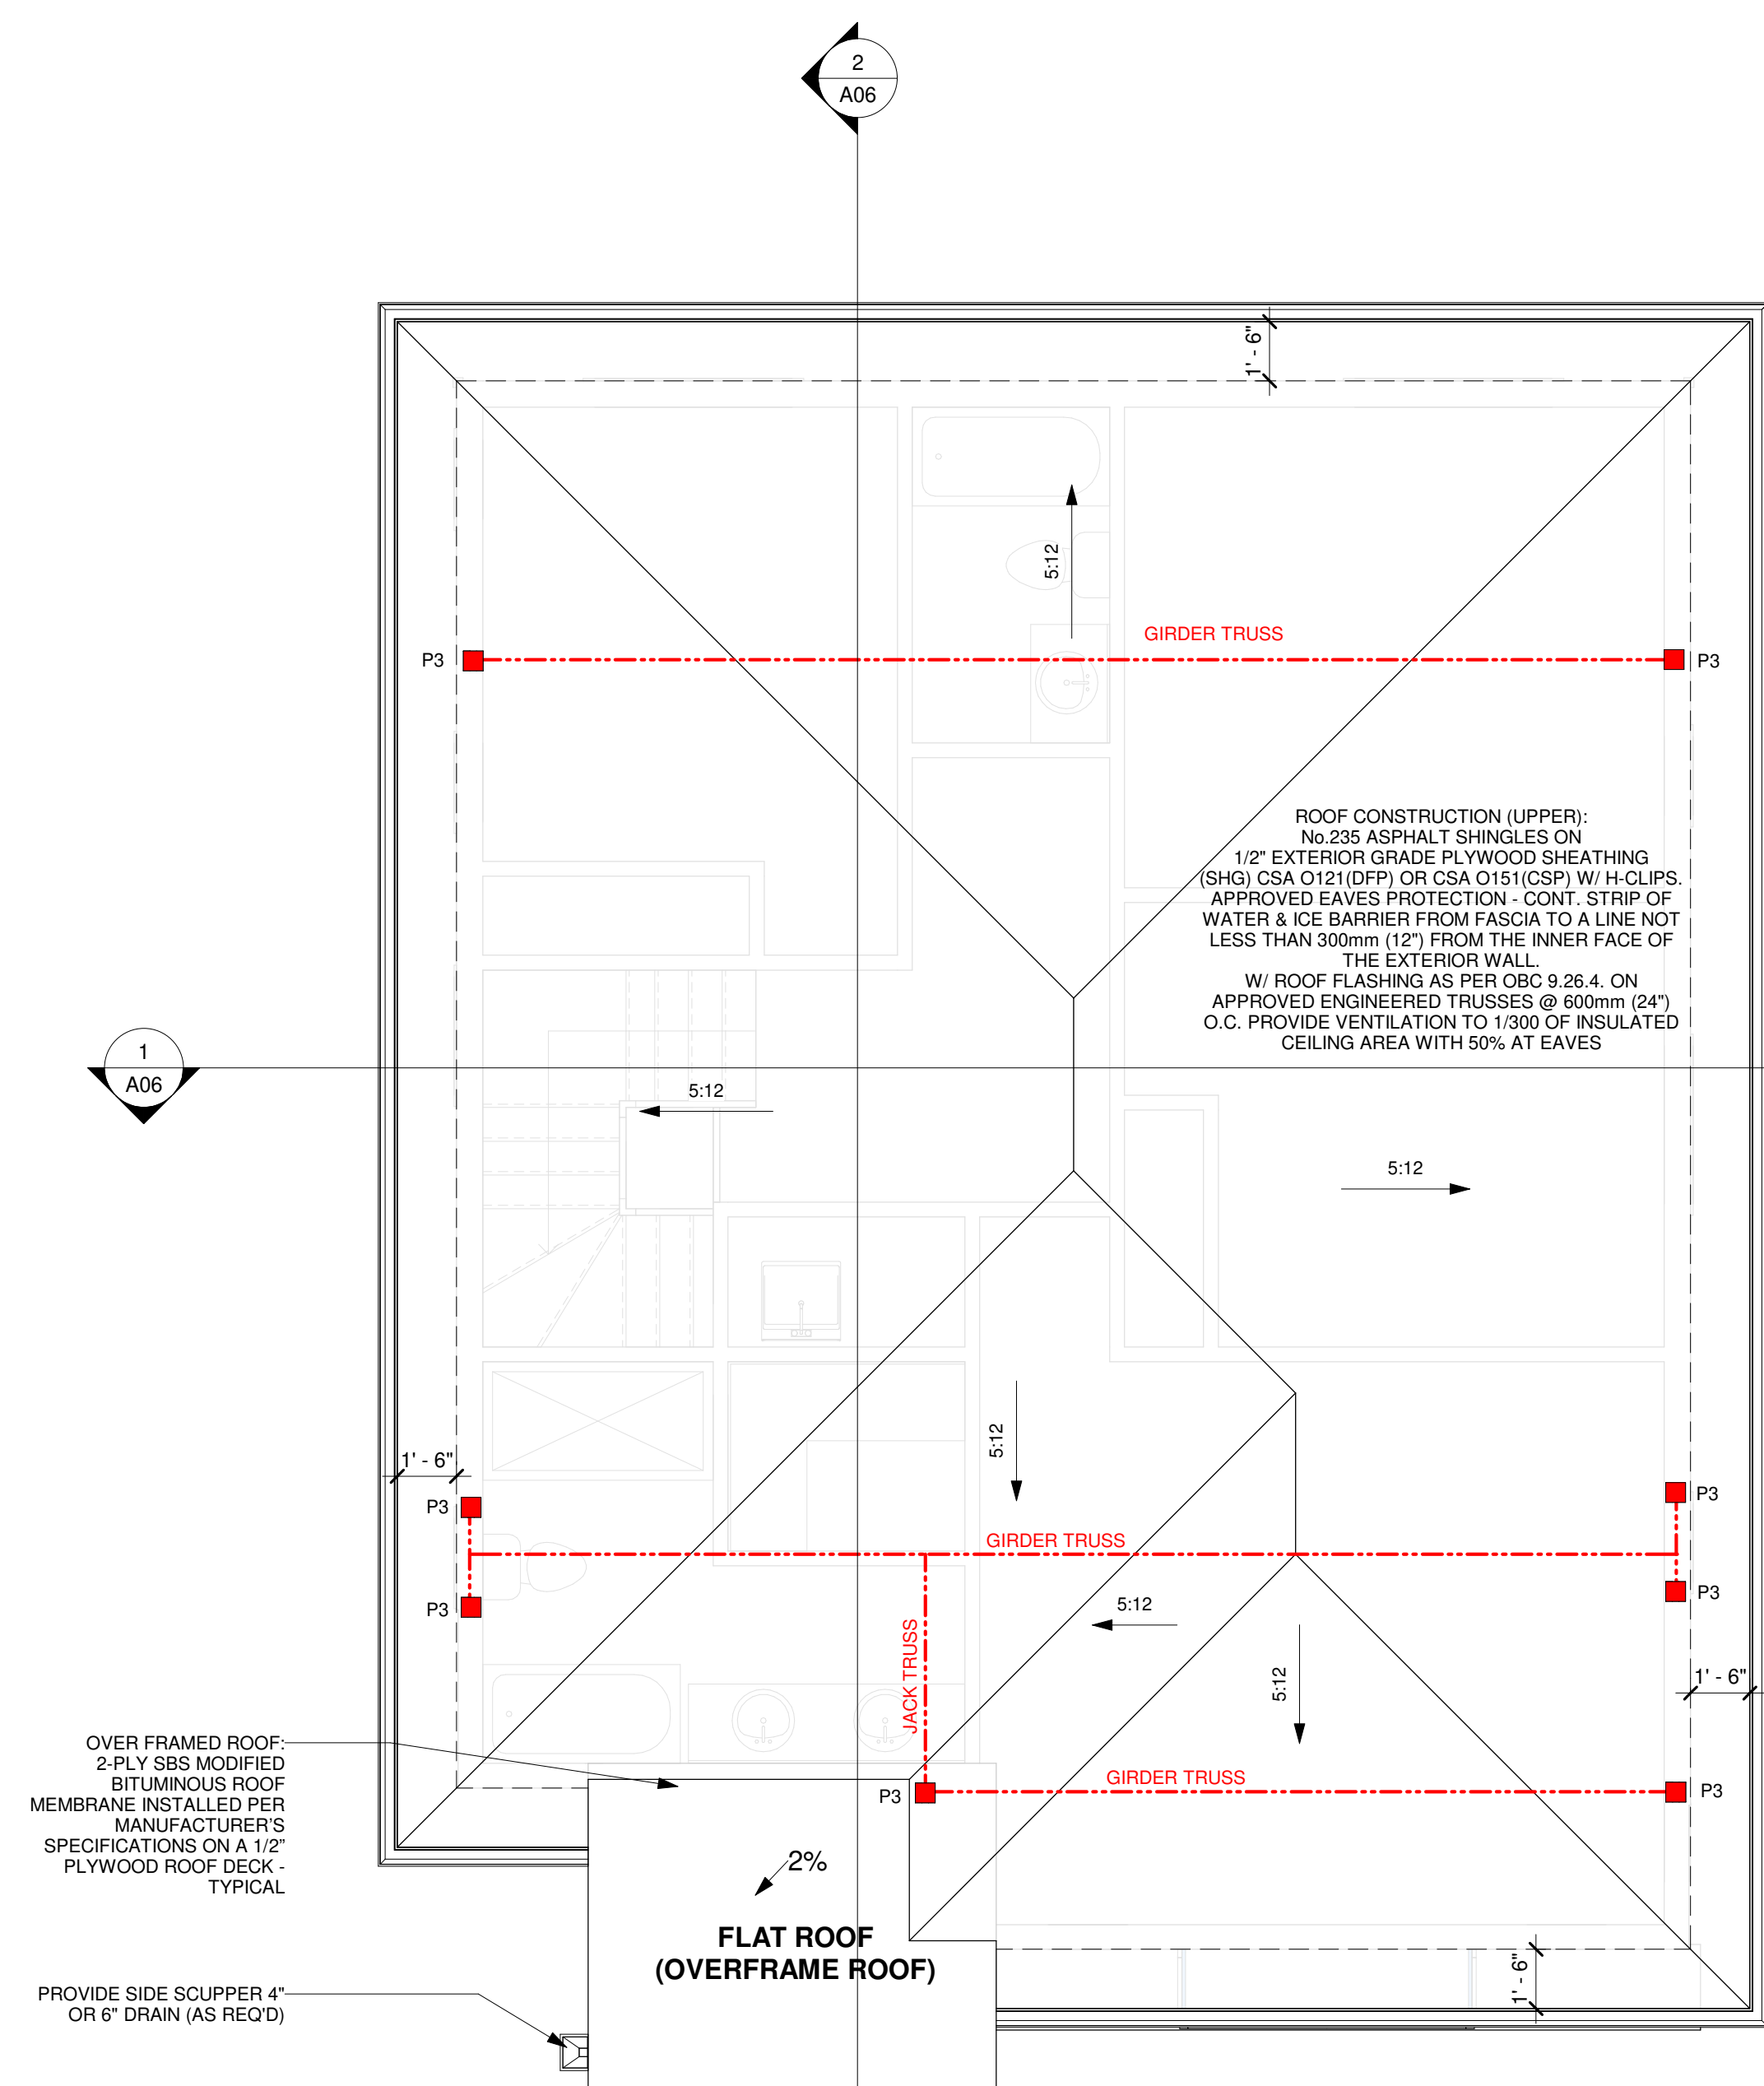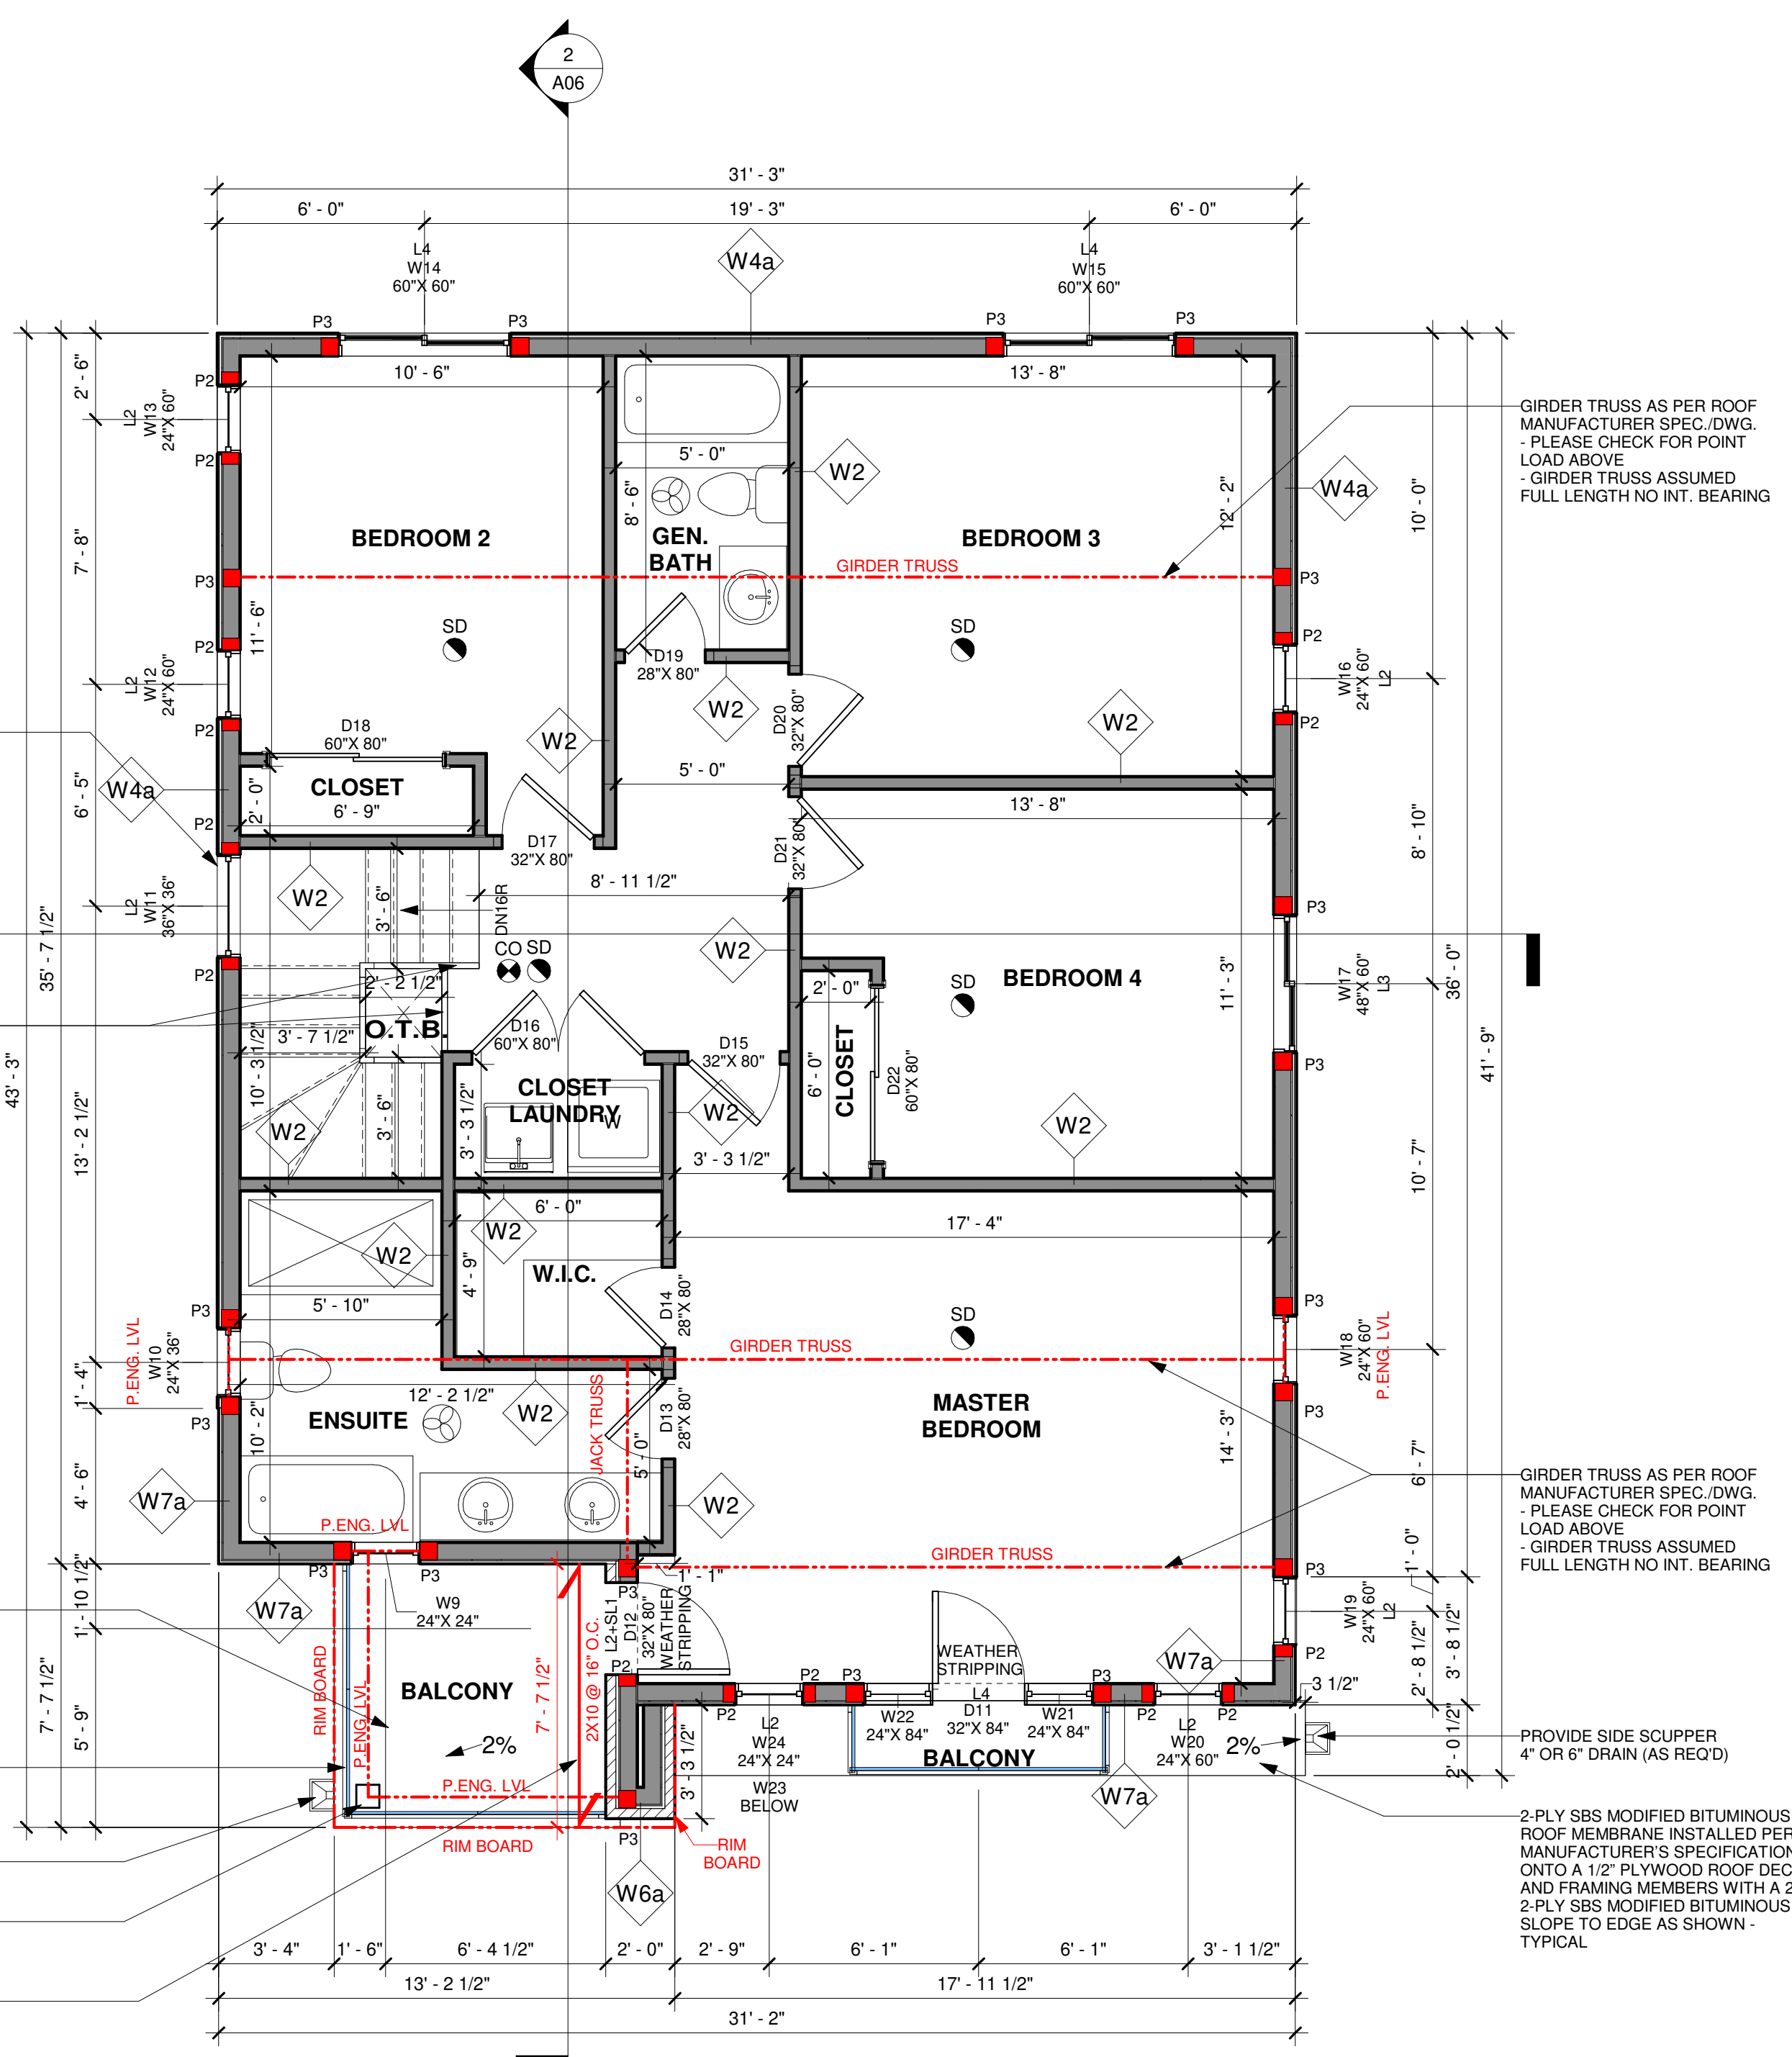

1 SECOND FLOOR PLAN
 1/4" = 1'-0"

2 ROOF PLAN
 1/4" = 1'-0"

FOR SUPPLIER:
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NILAMRAJ (RAJ) PATEL	100621
NAME	SIGNATURE
BCIN	BCIN
REGISTRATION INFORMATION REQUIRED UNLESS THE DESIGN IS EXEMPT UNDER DIVISION C - 3.2.4.1 OF THE 2012 ONTARIO BUILDING CODE.	
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FIRM NAME	BCIN

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FRONT & RIGHT SIDE ELEVATION

Project:

LOT-36
 PARKER AVENUE, TOWN OF FORT ERIE, PROPOSED TWO STOREY HOUSE


Scale:

Drawn by:
 MJ
 Checked by:
 RP
 Project No.:

Date:
 2022/05/14
 Drawing No.:



A04

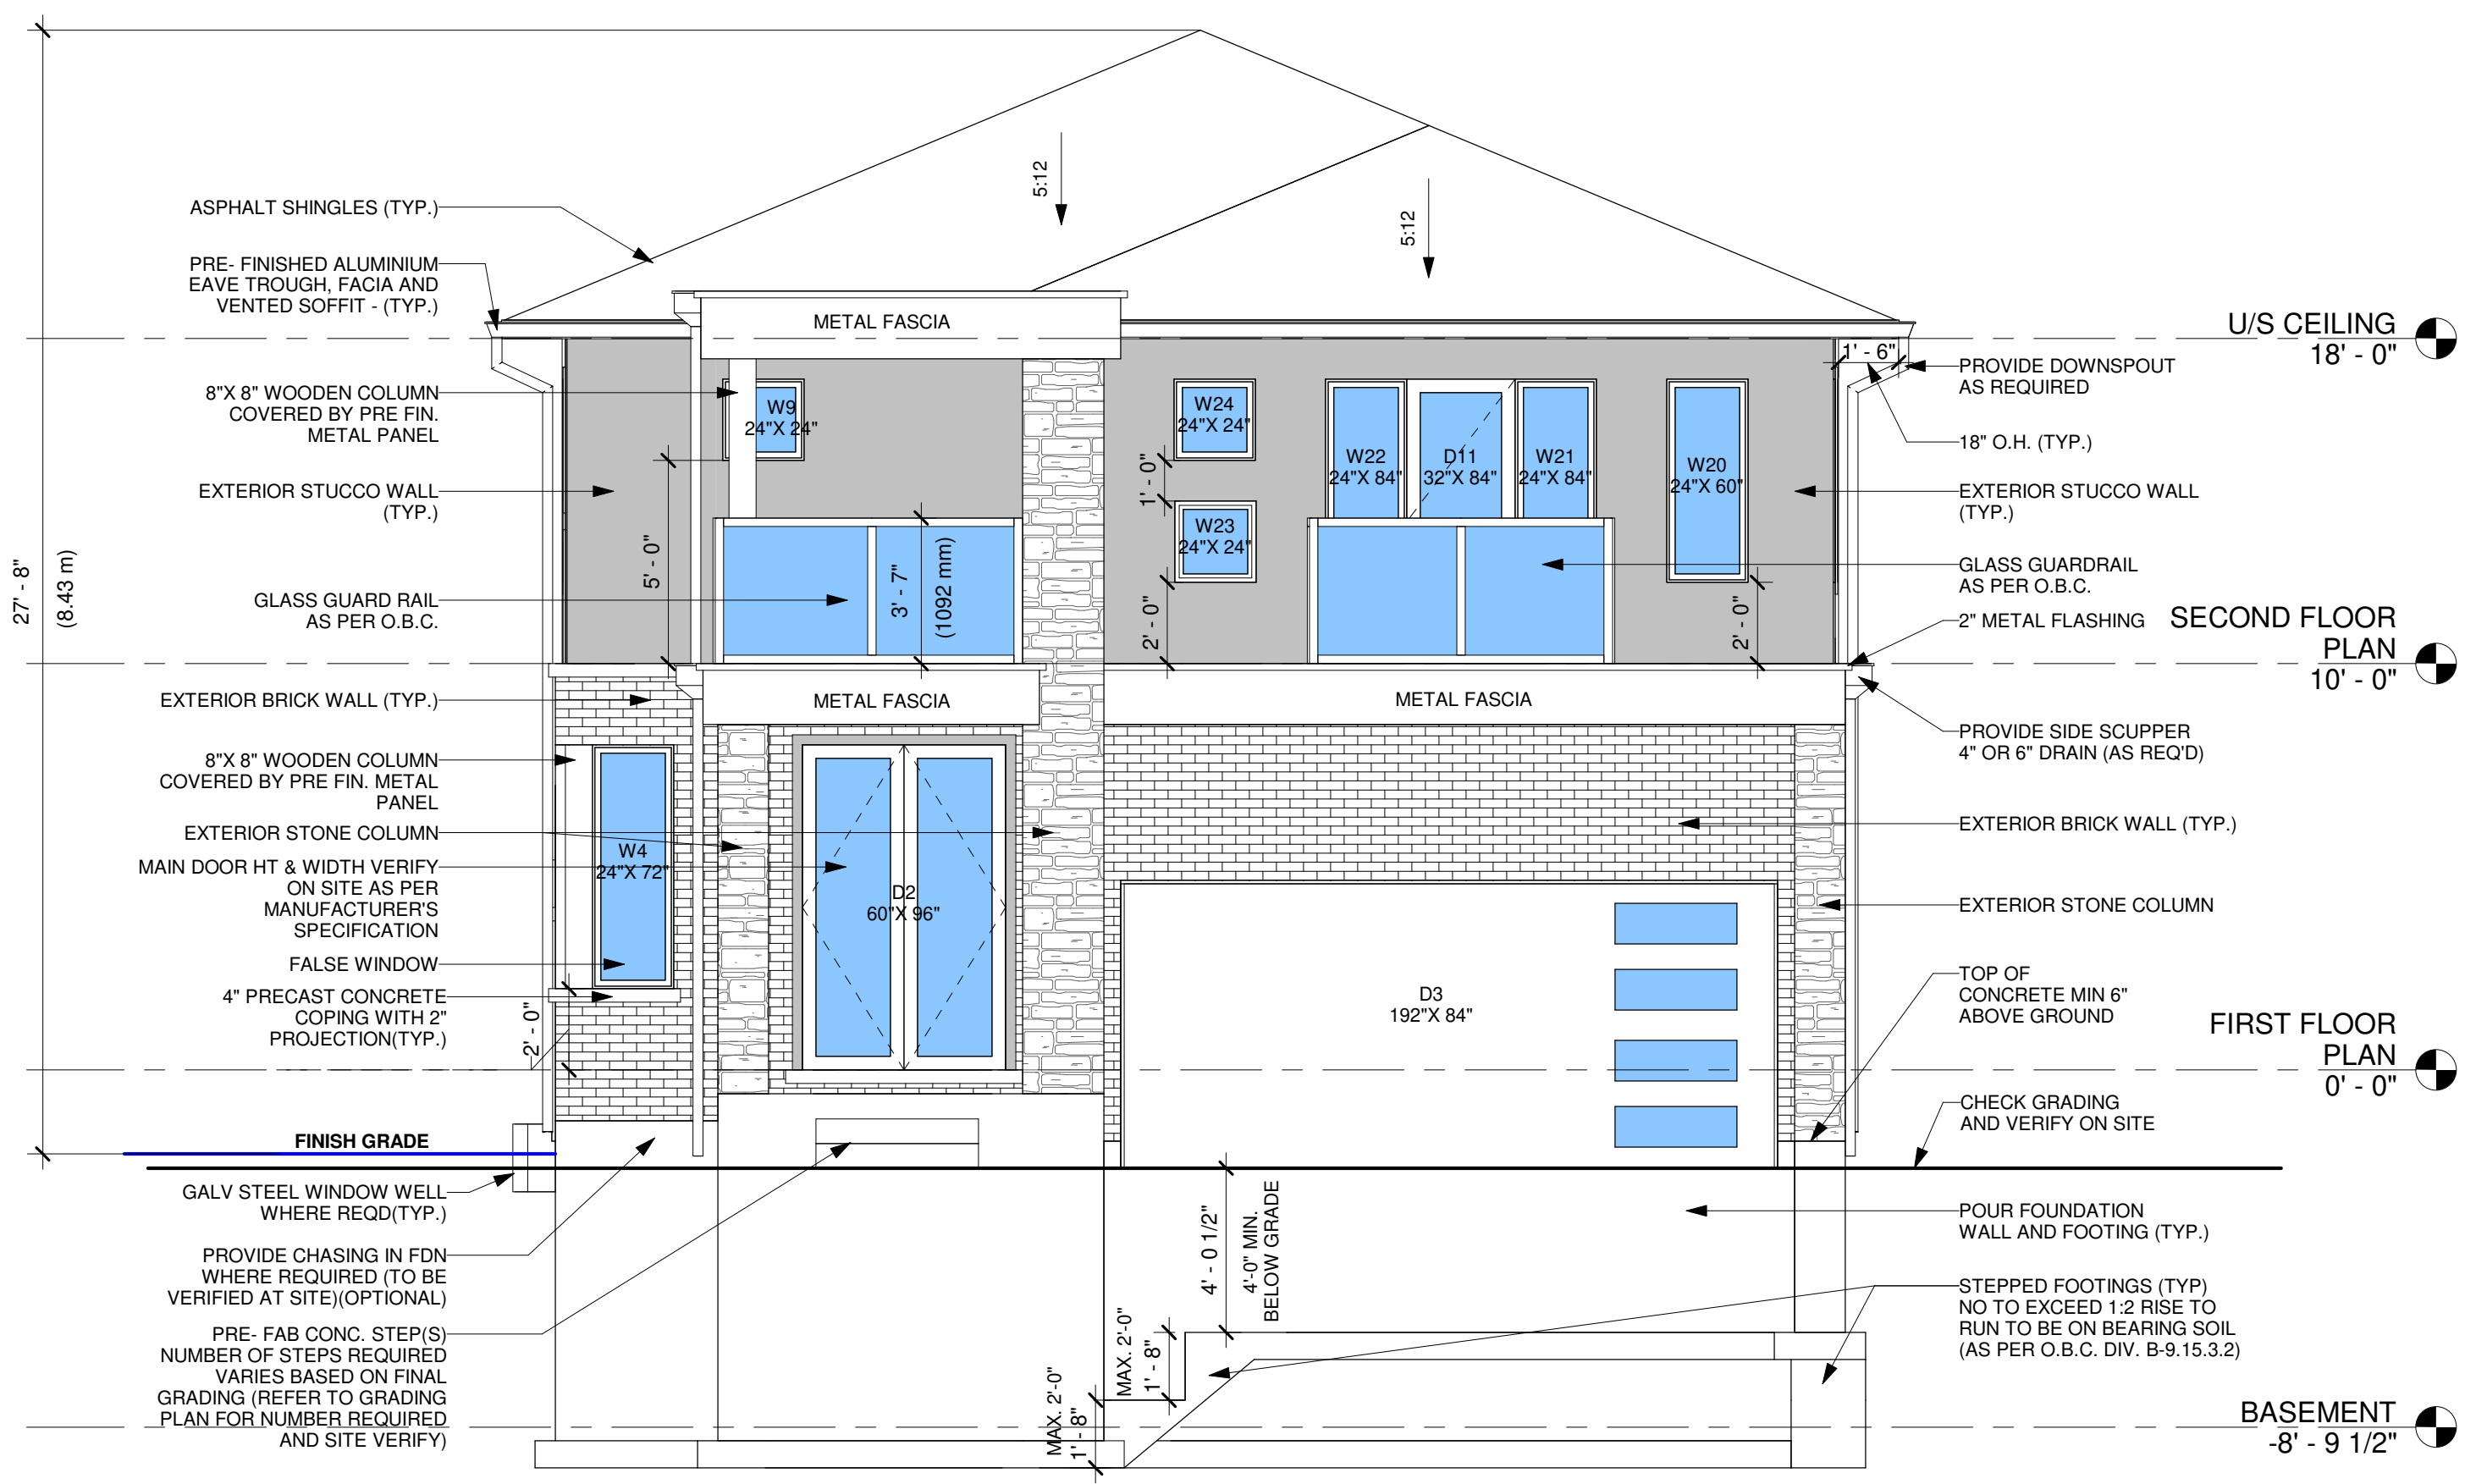


1 FRONT ELEVATION
 1/4" = 1'-0"



RIGHT SIDE OPENING CALCULATION	
%UNPROTECTED OPENING	DATA
1. WALL AREA	818.51 SQFT
2. LIMITING DISTANCE	4'-0" (1.22M)
3. ALLOWABLE OPENINGS	57.29 SQFT (7%)
4. PROVIDED OPENINGS	50.00 SQFT (6.11%)

FOR GARAGE, BASEMENT, FF AND PORCH GRADING LEVEL REFER TO GRADING PLAN. IN SITUATION OF DISCREPANCY BETWEEN ARCHITECTURAL DRAWING SET AND CIVIL SET, FOLLOW THE CIVIL SET (GRADING PLAN)

WINDOW SUPPLIER TO ENSURE DOORS & WINDOWS ARE AS PER OBC STANDARD INCLUDING MINIMUM OPENABLE OPENINGS

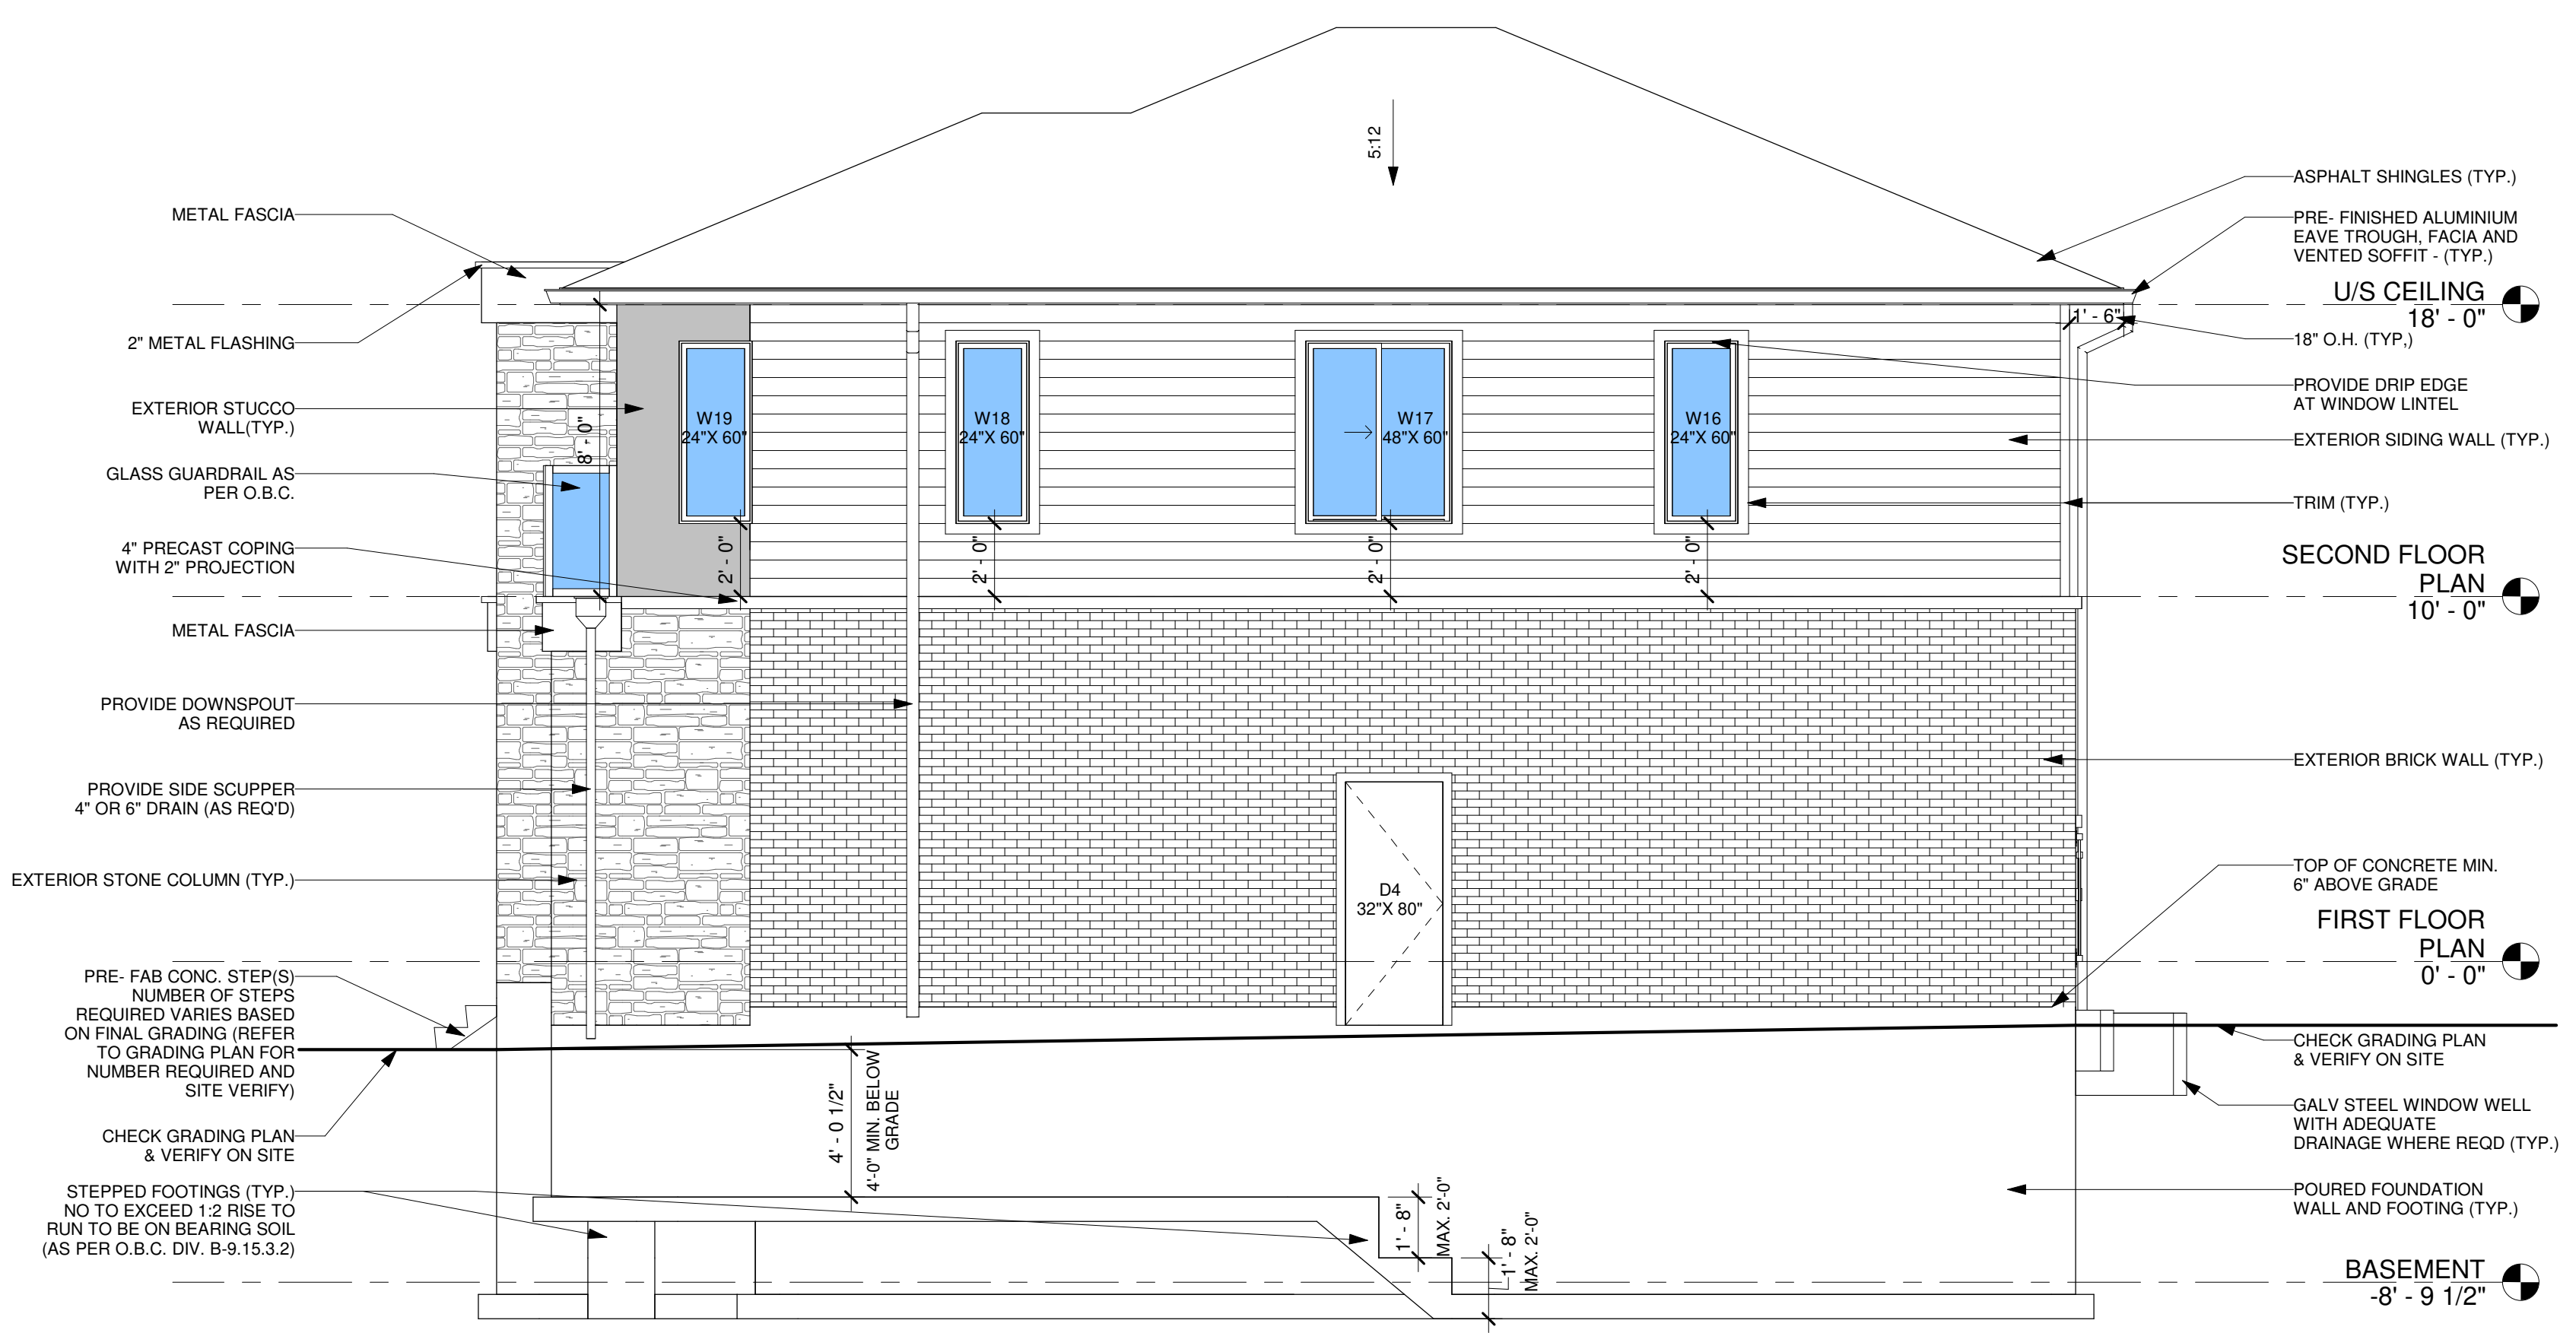

2 RIGHT SIDE ELEVATION
 1/4" = 1'-0"

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	BCIN
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REAR & LEFT SIDE ELEVATION

Project:

LOT-36
 PARKER AVENUE, TOWN OF FORT ERIE, PROPOSED TWO STOREY HOUSE




Scale:

Drawn by:
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 RP
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Date:
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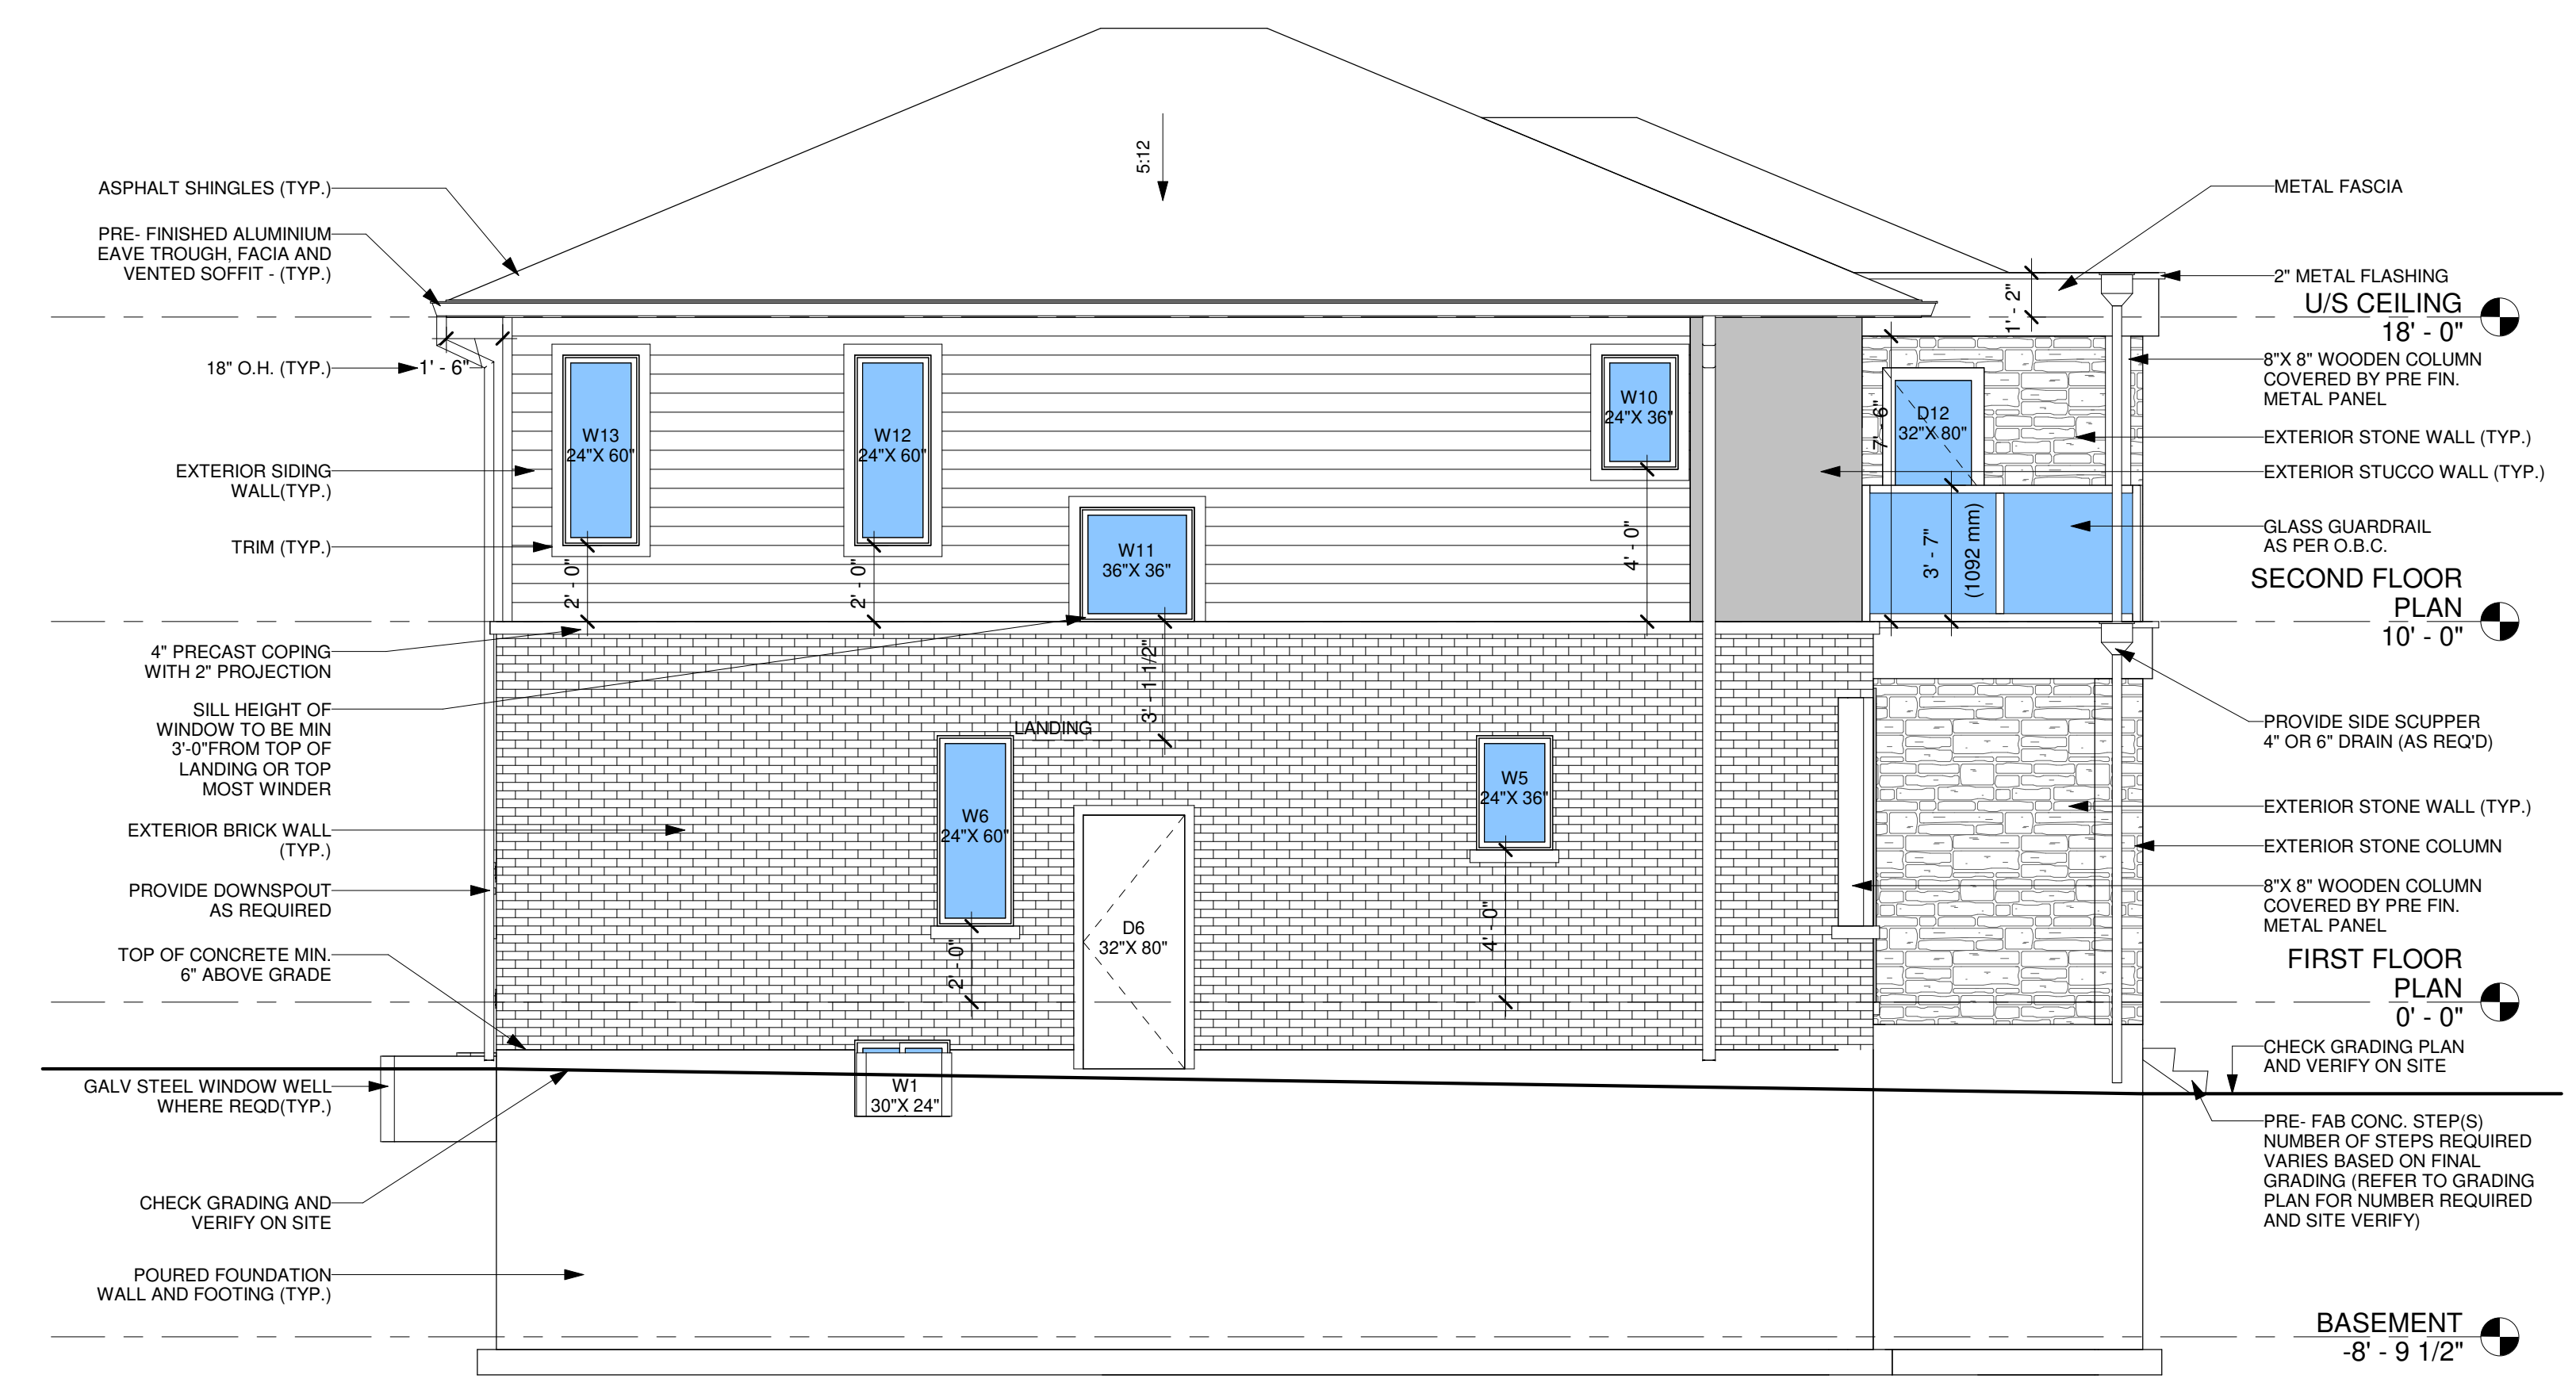


A05




1 REAR ELEVATION
 1/4" = 1'-0"

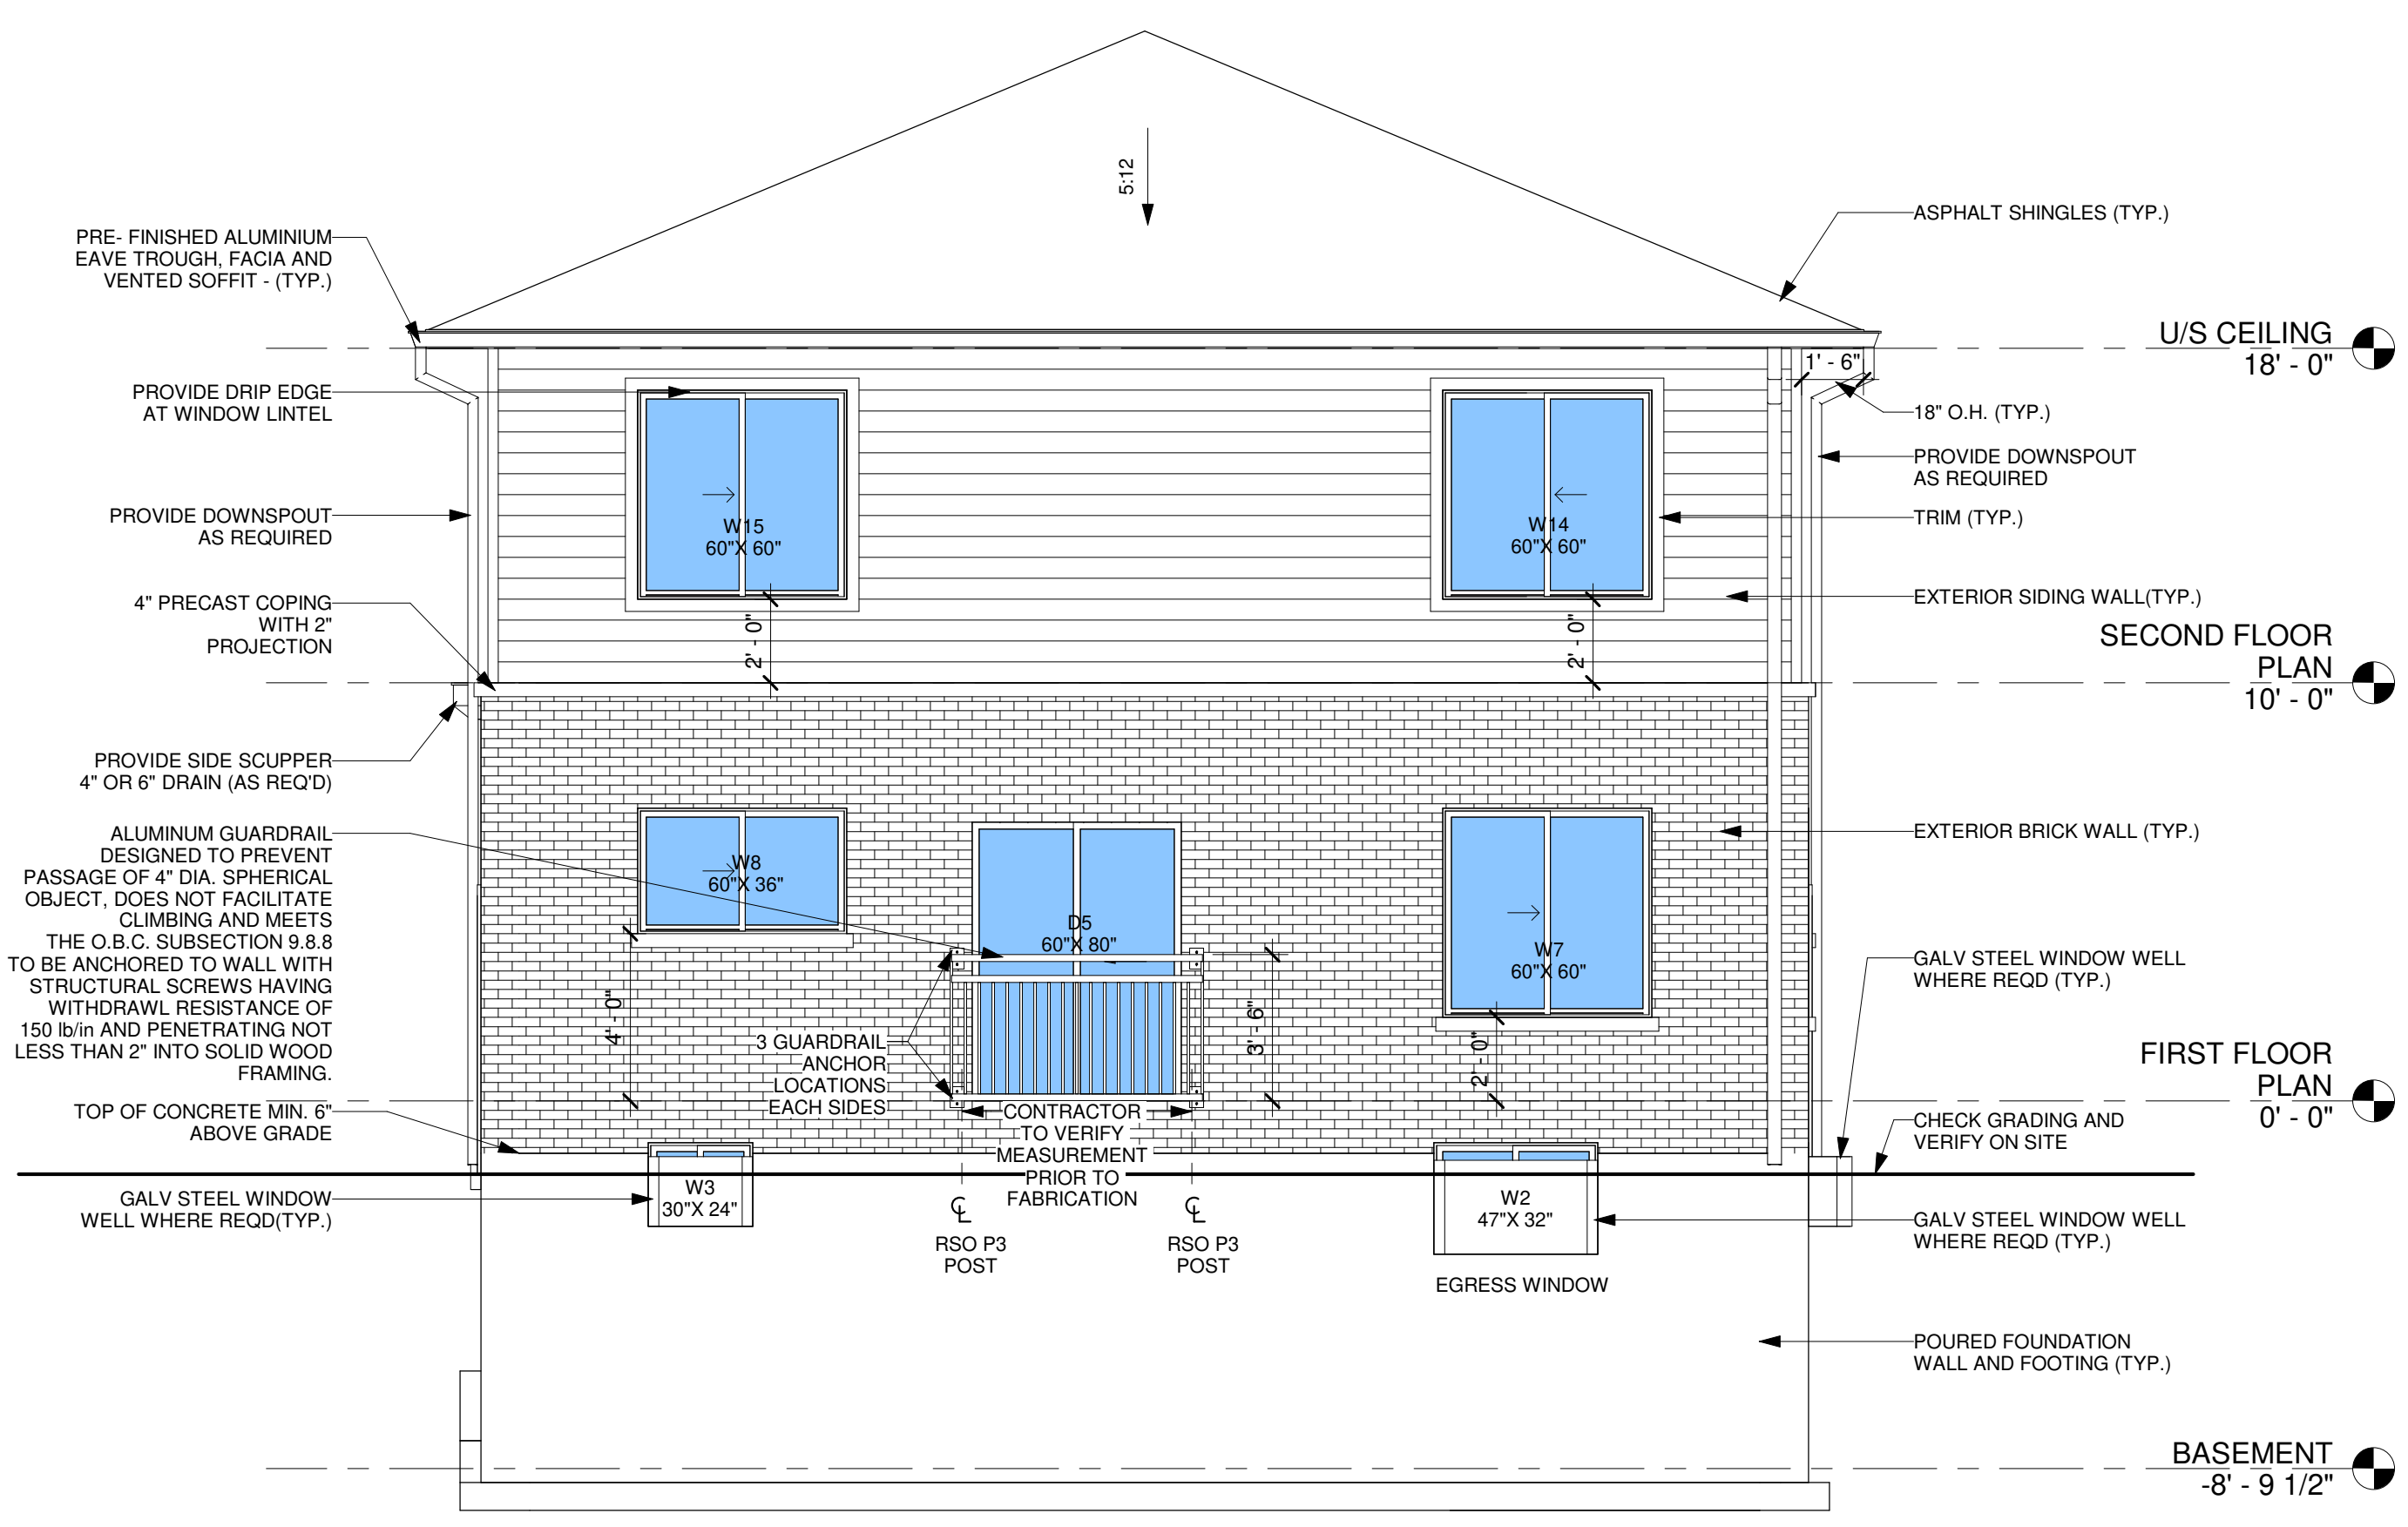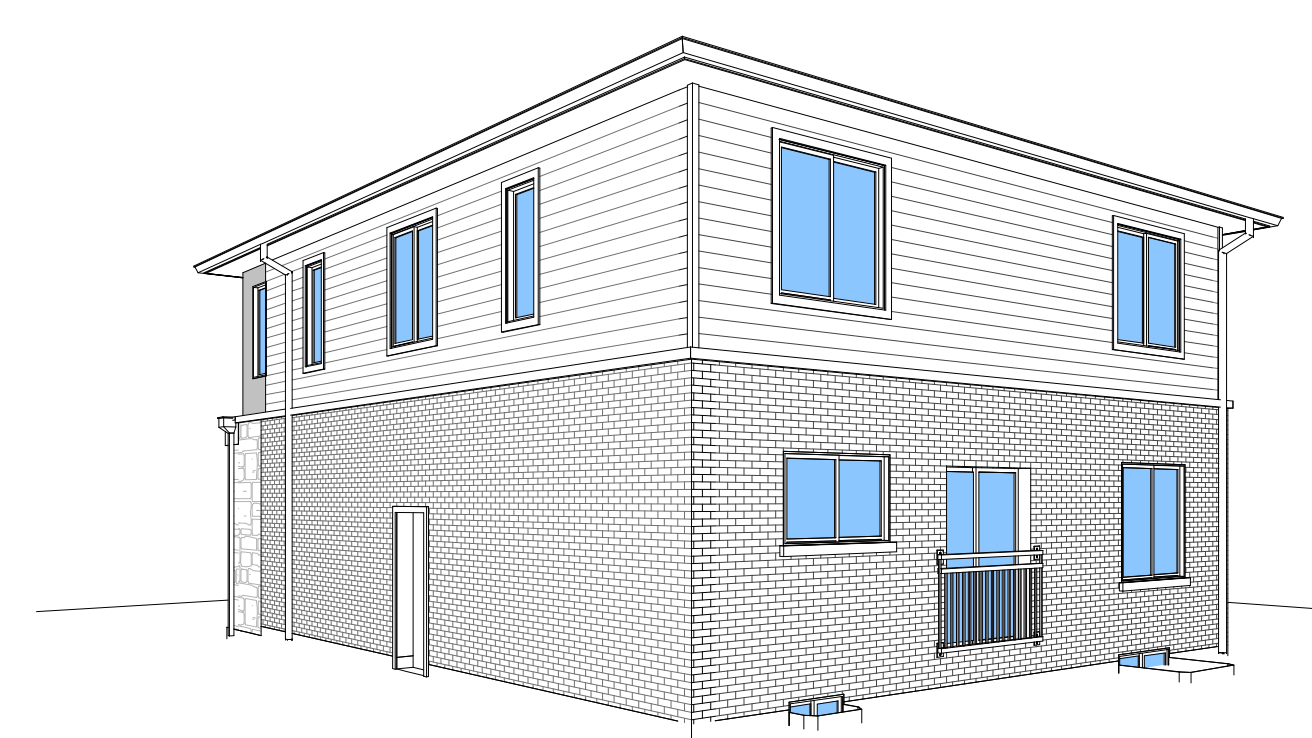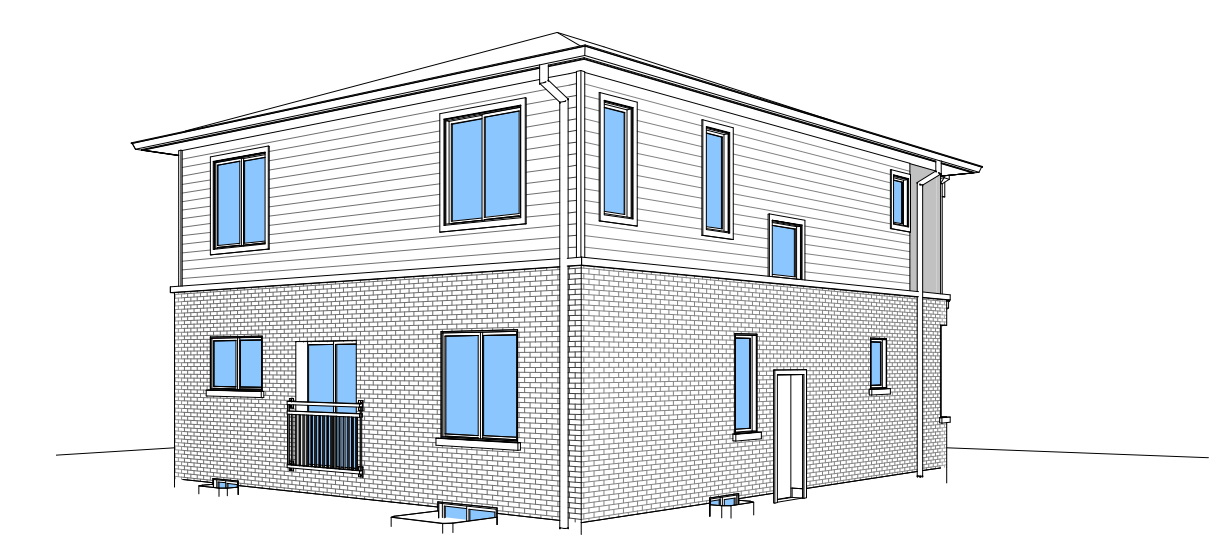AS LOT IS CORNER LOT, LEFT SIDE OPENING CALCULATION IS NOT REQUIRED.



2 LEFT SIDE ELEVATION
 1/4" = 1'-0"

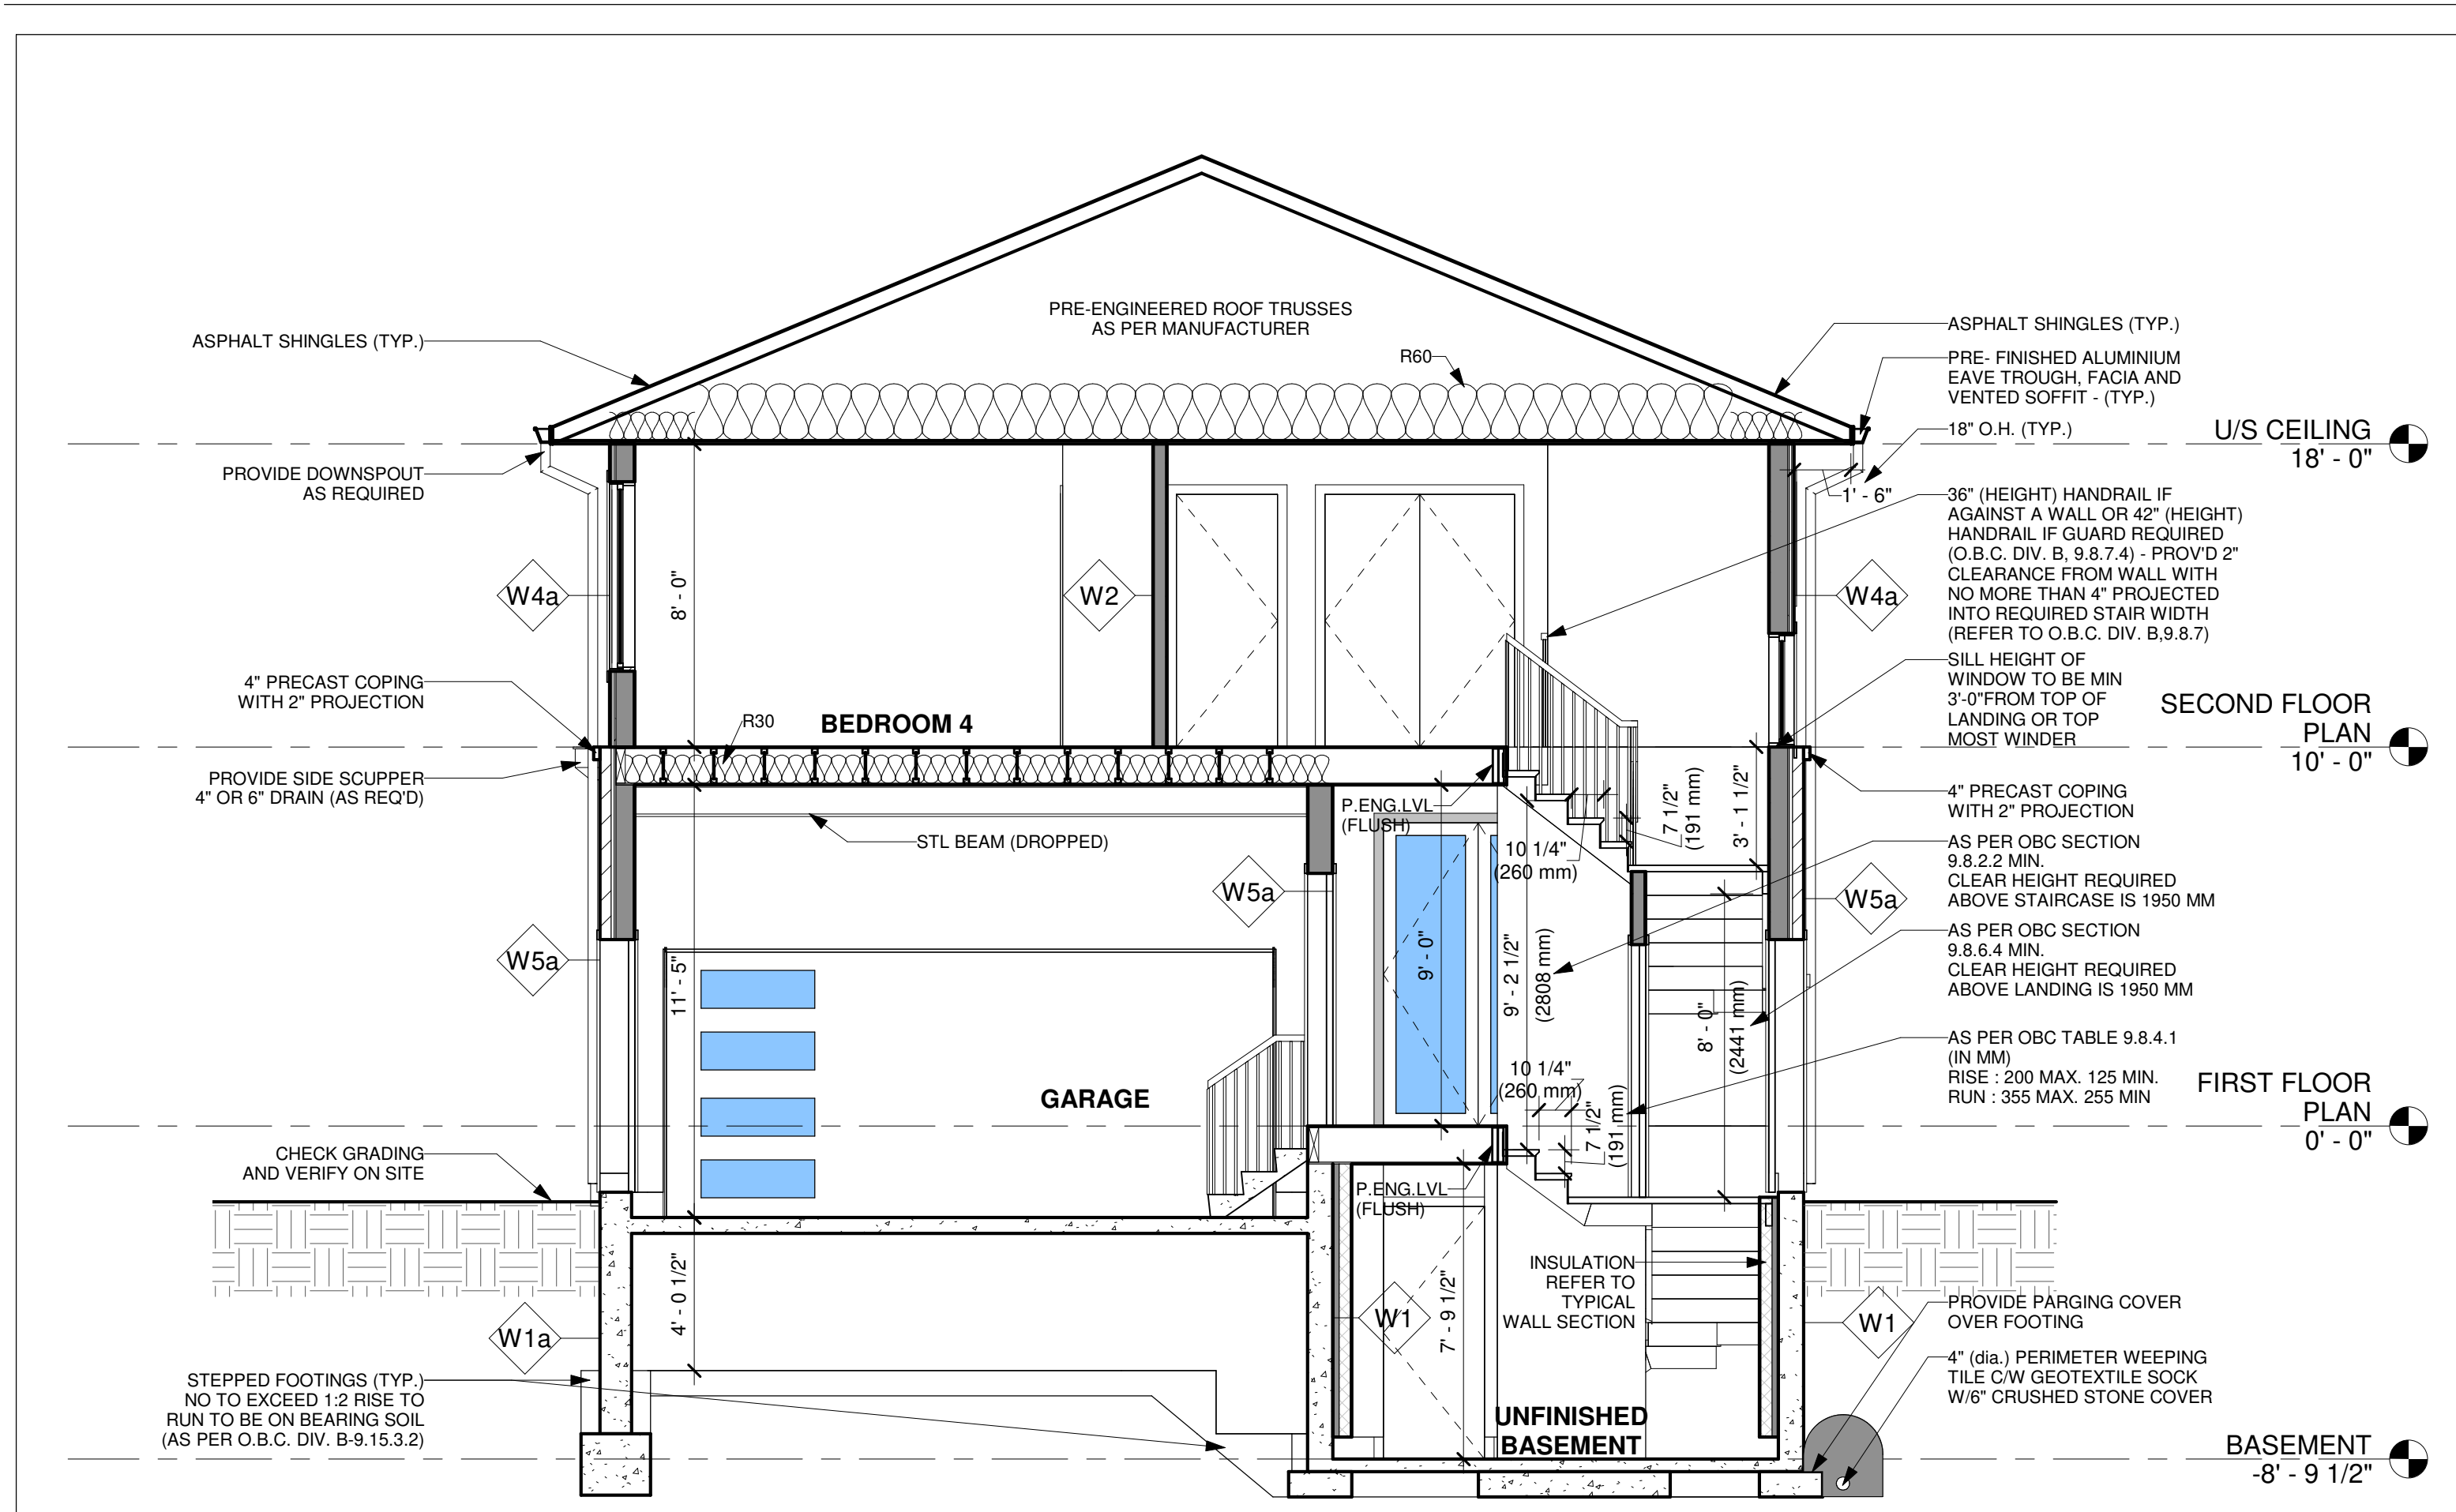

SECTION 1
1/4" = 1'-0"

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WOOD LINTEL SCHEDULE	
	MIN. ANGLE SIZE
L1	2 - 2 X 4
L2	2 - 2 X 6
L3	2 - 2 X 8
L4	2 - 2 X 10
L5	2 - 2 X 12

STEEL ANGLE LINTEL SCHEDULE			
FOR STEEL LINTEL SUPPORTING MASONRY VENEER (O.B.C. 9.20.5.2.3)			
MIN. ANGLE SIZE	MAX. ALLOWABLE SPAN		
	FOR BRICK (2 3/4")	FOR BRICK (3 1/2")	FOR STONE
SL1 L-3 1/2" x 3 1/2" x 1/4"	3'-6" OR LESS	8'-1" OR LESS	7'-9" OR LESS
SL2 L-4" x 3 1/2" x 1/4"	9'-2"	8'-9"	8'-2"
SL3 L-4 7/8" x 3 1/2" x 5/16"	11'-5"	10'-10"	10'-1"
SL4 L-4 7/8" x 3 1/2" x 3/8"	11'-11"	11'-5"	10'-8"
SL5 L-4 7/8" x 3 1/2" x 1/2"	12'-7"	11'-9"	10'-11"
SL6 L-5 7/8" x 3 1/2" x 3/8"	13'-4"	12'-7"	11'-8"
SL7 L-5 7/8" x 3 1/2" x 1/2"	14'-2"	13'-5"	12'-5"
SL8 L-5 7/8" x 4" x 1/2"	14'-4"	13'-6"	12'-7"
SL9 L-7 1/8" x 4" x 3/8"	15'-0"	14'-1"	13'-1"
SL10 L-7 1/8" x 4" x 1/2"	16'-0"	15'-1"	14'-0"

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NILAMRAJ (RAJ) PATEL 100621

NAME SIGNATURE BCIN

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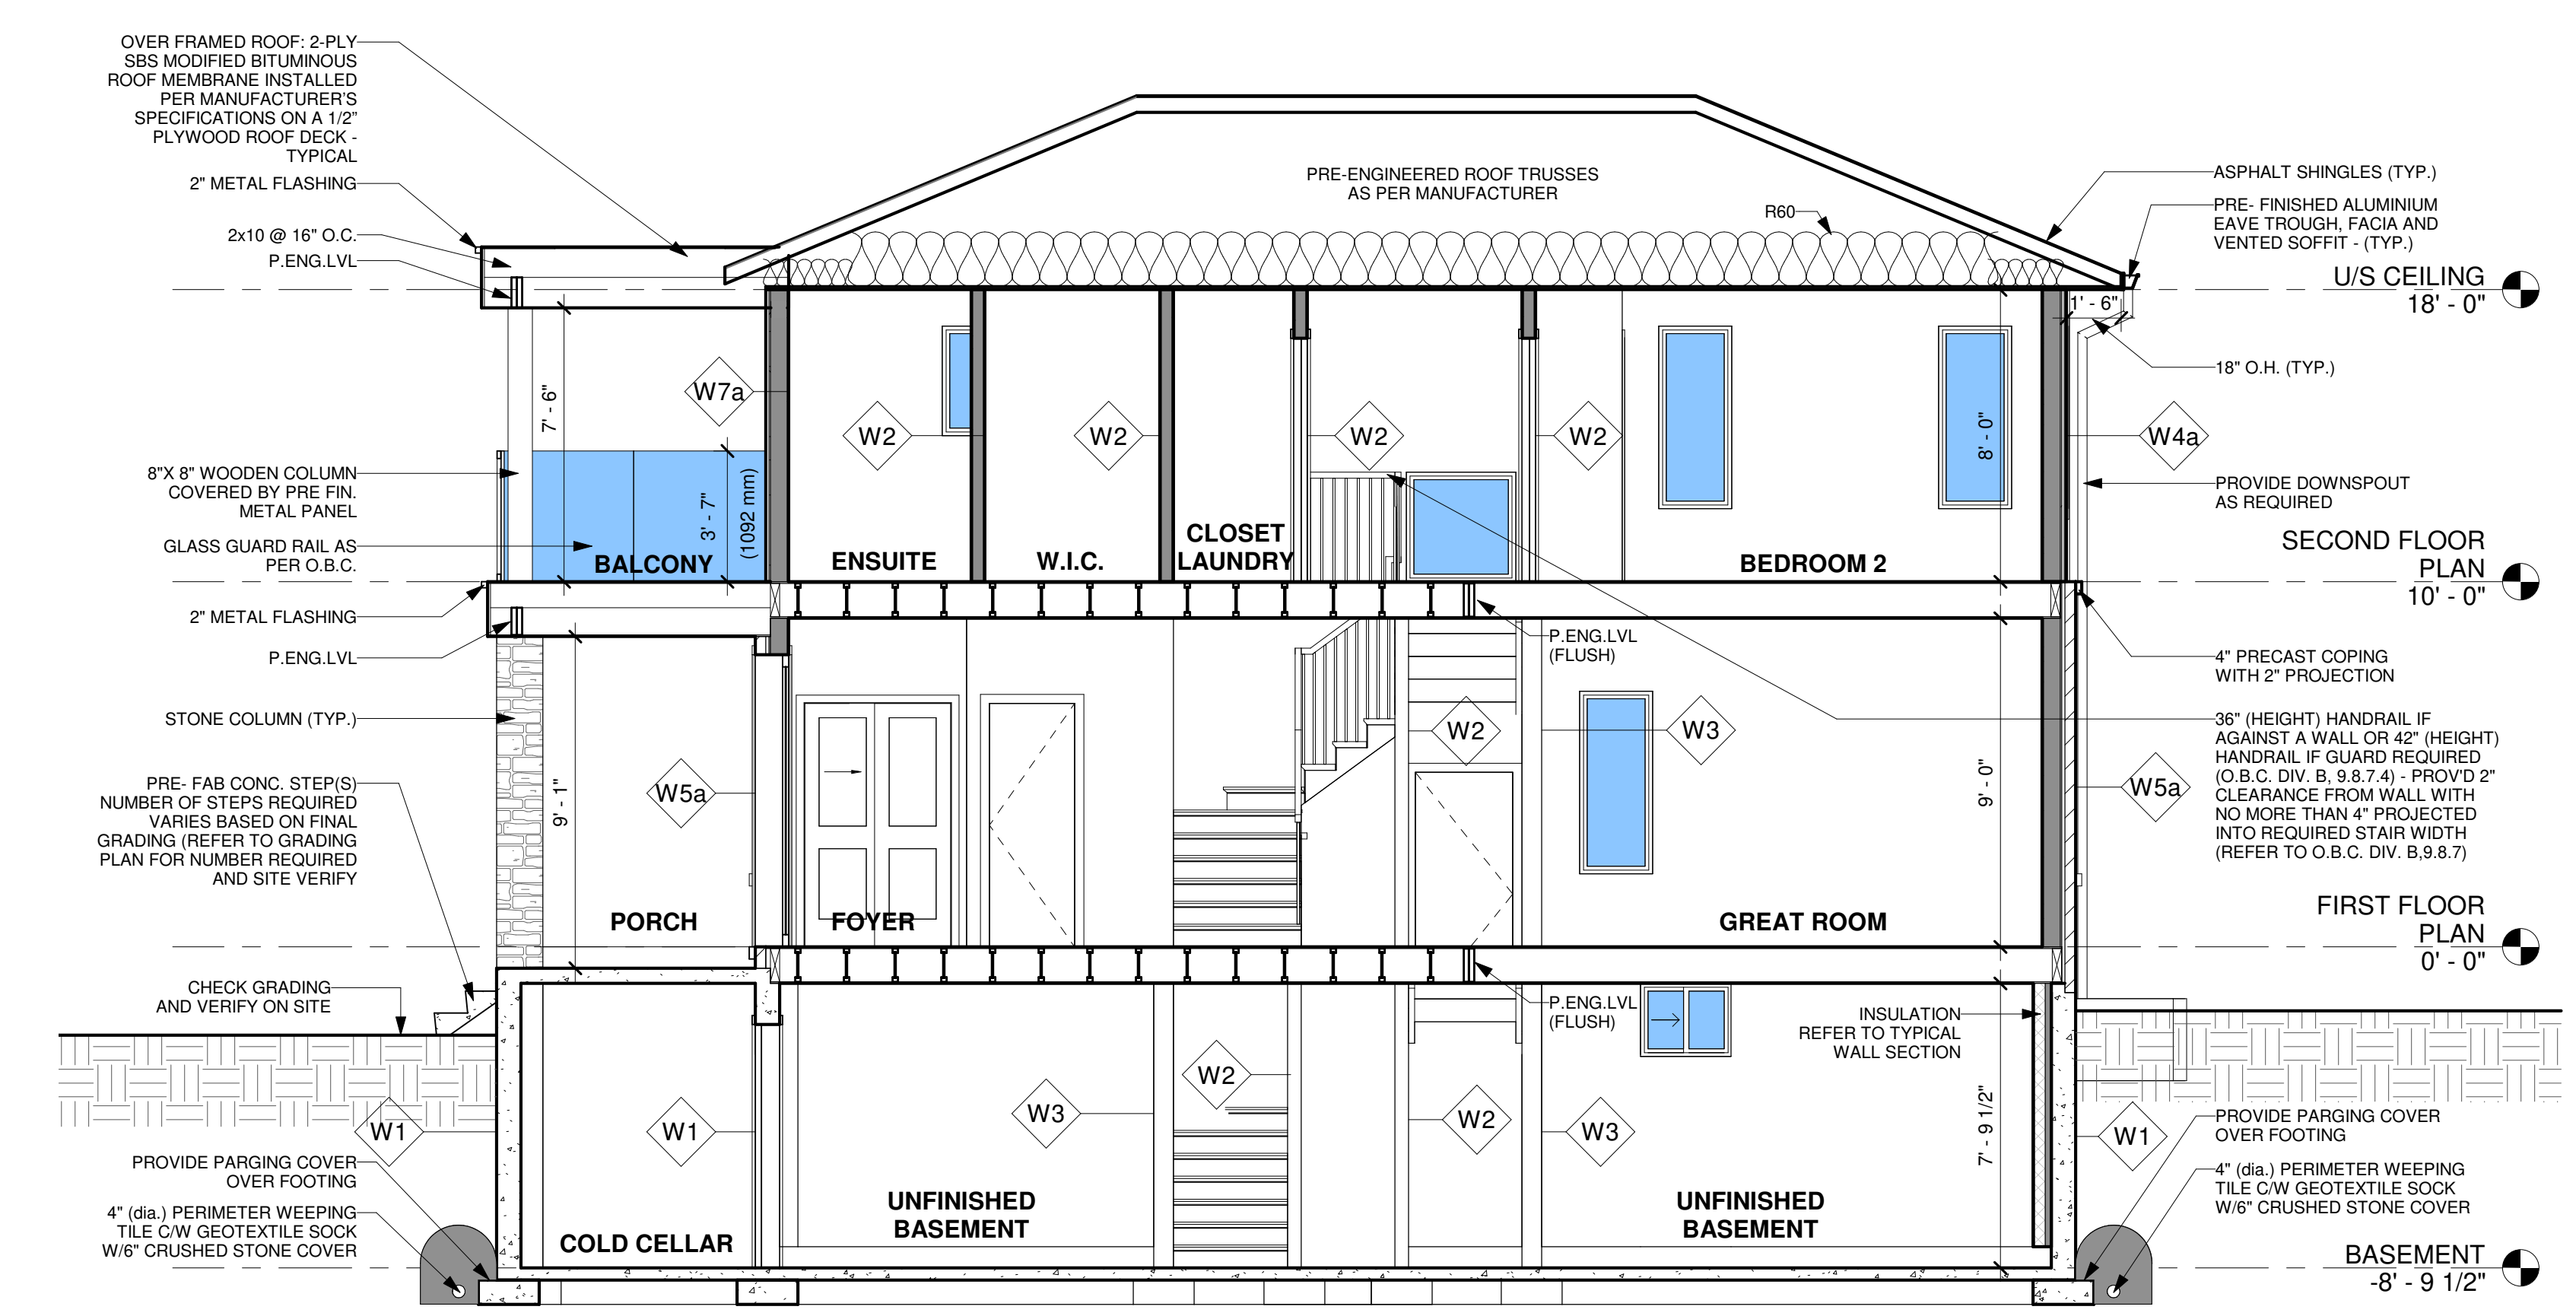
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STEEL BEAM LINTEL SCHEDULE			
FOR STEEL BEAMS SUPPORTING MASONRY VENEER O.B.C. 9.20.5.2 (C)			
SECTION	2 3/4" BRICK	3 1/2" BRICK	4" STONE
W 6 x 15	13'-11"	13'-5"	12'-11"
W 6 x 20	15'-4"	14'-10"	14'-2"
W 8 x 18	17'-3"	16'-8"	15'-10"
W 8 x 21	18'-3"	17'-7"	16'-9"
W 8 x 24	18'-9"	18'-0"	17'-2"

WOOD LINTEL SCHEDULE			MAXIMUM SPAN, m.					
LINTEL SUPPORTING	LINTEL SIZE		EXTERIOR WALLS					
			SPECIFIED SNOW LOAD, kPa					
			1.0	1.5	2.0	2.5	3.0	
LIMITED ATTIC STORAGE AND CEILING	2 - 1 1/2 x 3 1/2 (L1-2 - 2 x 4)							
TRIBUTARY WIDTH OF 0.6 M MAXIMUM	2 - 1 1/2 x 5 1/2 (L2-2 - 2 x 6)							
ROOF AND CEILING ONLY (TRIBUTARY WIDTH OF 0.6 M MAXIMUM)	2 - 1 1/2 x 7 1/4 (L3-2 - 2 x 8)							
ROOF AND CEILING ONLY (TRIBUTARY WIDTH OF 0.9 M MAXIMUM)	2 - 1 1/2 x 9 1/4 (L4-2 - 2 x 10)							
ROOF, CEILING AND 1 STOREY	2 - 1 1/2 x 11 1/4 (L5-2 - 2 x 12)							
ROOF, CEILING AND 2 STOREYS	2 - 1 1/2 x 3 1/2 (L1-2 - 2 x 4)	3'-5"	3'-2"	2'-11"	2'-9"	2'-7"	2'-5"	
ROOF, CEILING AND 3 STOREYS	2 - 1 1/2 x 5 1/2 (L2-2 - 2 x 6)	4'-11"	4'-6"	4'-2"	3'-11"	3'-9"	3'-4"	
	2 - 1 1/2 x 7 1/4 (L3-2 - 2 x 8)	6'-0"	5'-6"	5'-1"	4'-9"	4'-5"	3'-11"	
	2 - 1 1/2 x 9 1/4 (L4-2 - 2 x 10)	7'-3"	6'-8"	6'-2"	5'-8"	5'-3"	4'-9"	
	2 - 1 1/2 x 11 1/4 (L5-2 - 2 x 12)	8'-6"	7'-9"	7'-1"	6'-5"	6'-11"	5'-5"	
	2 - 1 1/2 x 3 1/2 (L1-2 - 2 x 4)	3'-1"	2'-11"	2'-9"	2'-7"	2'-6"	2'-1"	
	2 - 1 1/2 x 5 1/2 (L2-2 - 2 x 6)	4'-5"	4'-2"	3'-11"	3'-9"	3'-6"	2'-11"	
	2 - 1 1/2 x 7 1/4 (L3-2 - 2 x 8)	5'-4"	5'-0"	4'-9"	4'-5"	4'-1"	3'-5"	
	2 - 1 1/2 x 9 1/4 (L4-2 - 2 x 10)	6'-6"	6'-2"	5'-8"	5'-3"	4'-11"	4'-2"	
	2 - 1 1/2 x 11 1/4 (L5-2 - 2 x 12)	7'-7"	6'-11"	6'-5"	6'-0"	5'-7"	4'-9"	
	2 - 1 1/2 x 3 1/2 (L1-2 - 2 x 4)	2'-11"	2'-9"	2'-8"	2'-6"	2'-5"	1'-11"	
	2 - 1 1/2 x 5 1/2 (L2-2 - 2 x 6)	4'-1"	3'-11"	3'-9"	3'-7"	3'-4"	2'-8"	
	2 - 1 1/2 x 7 1/4 (L3-2 - 2 x 8)	5'-0"	4'-9"	4'-5"	4'-2"	4'-0"	3'-2"	
	2 - 1 1/2 x 9 1/4 (L4-2 - 2 x 10)	6'-1"	5'-8"	5'-4"	5'-0"	4'-9"	3'-10"	
	2 - 1 1/2 x 11 1/4 (L5-2 - 2 x 12)	6'-11"	6'-5"	6'-0"	5'-9"	5'-5"	4'-5"	



SECTION 2
1/4" = 1'-0"


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Drawing Title:
HOUSE SECTIONS & LINTEL SCHEDULES

Project:
**LOT-36
PARKER AVENUE, TOWN
OF FORT ERIE, PROPOSED
TWO STOREY HOUSE**


Scale:
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BILD
A06




**SIMPSON STRONG-TIE
HIT**

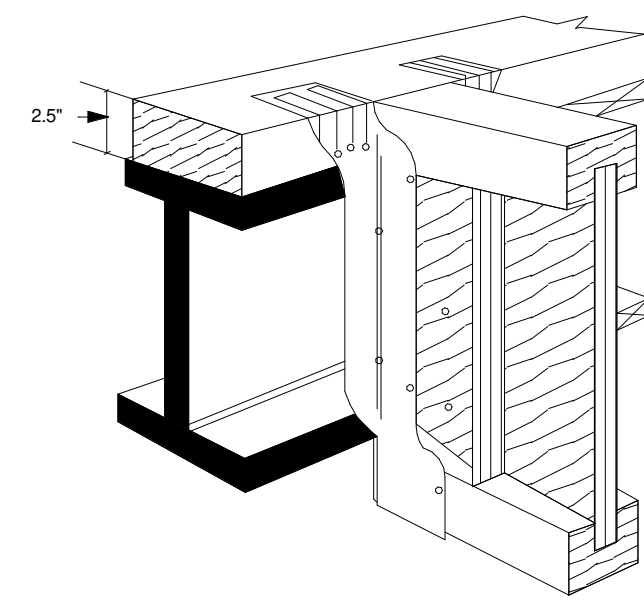
1 TYP. JOIST TO FLUSH BEAM CONNECTION DETAIL
A-08 N.T.S

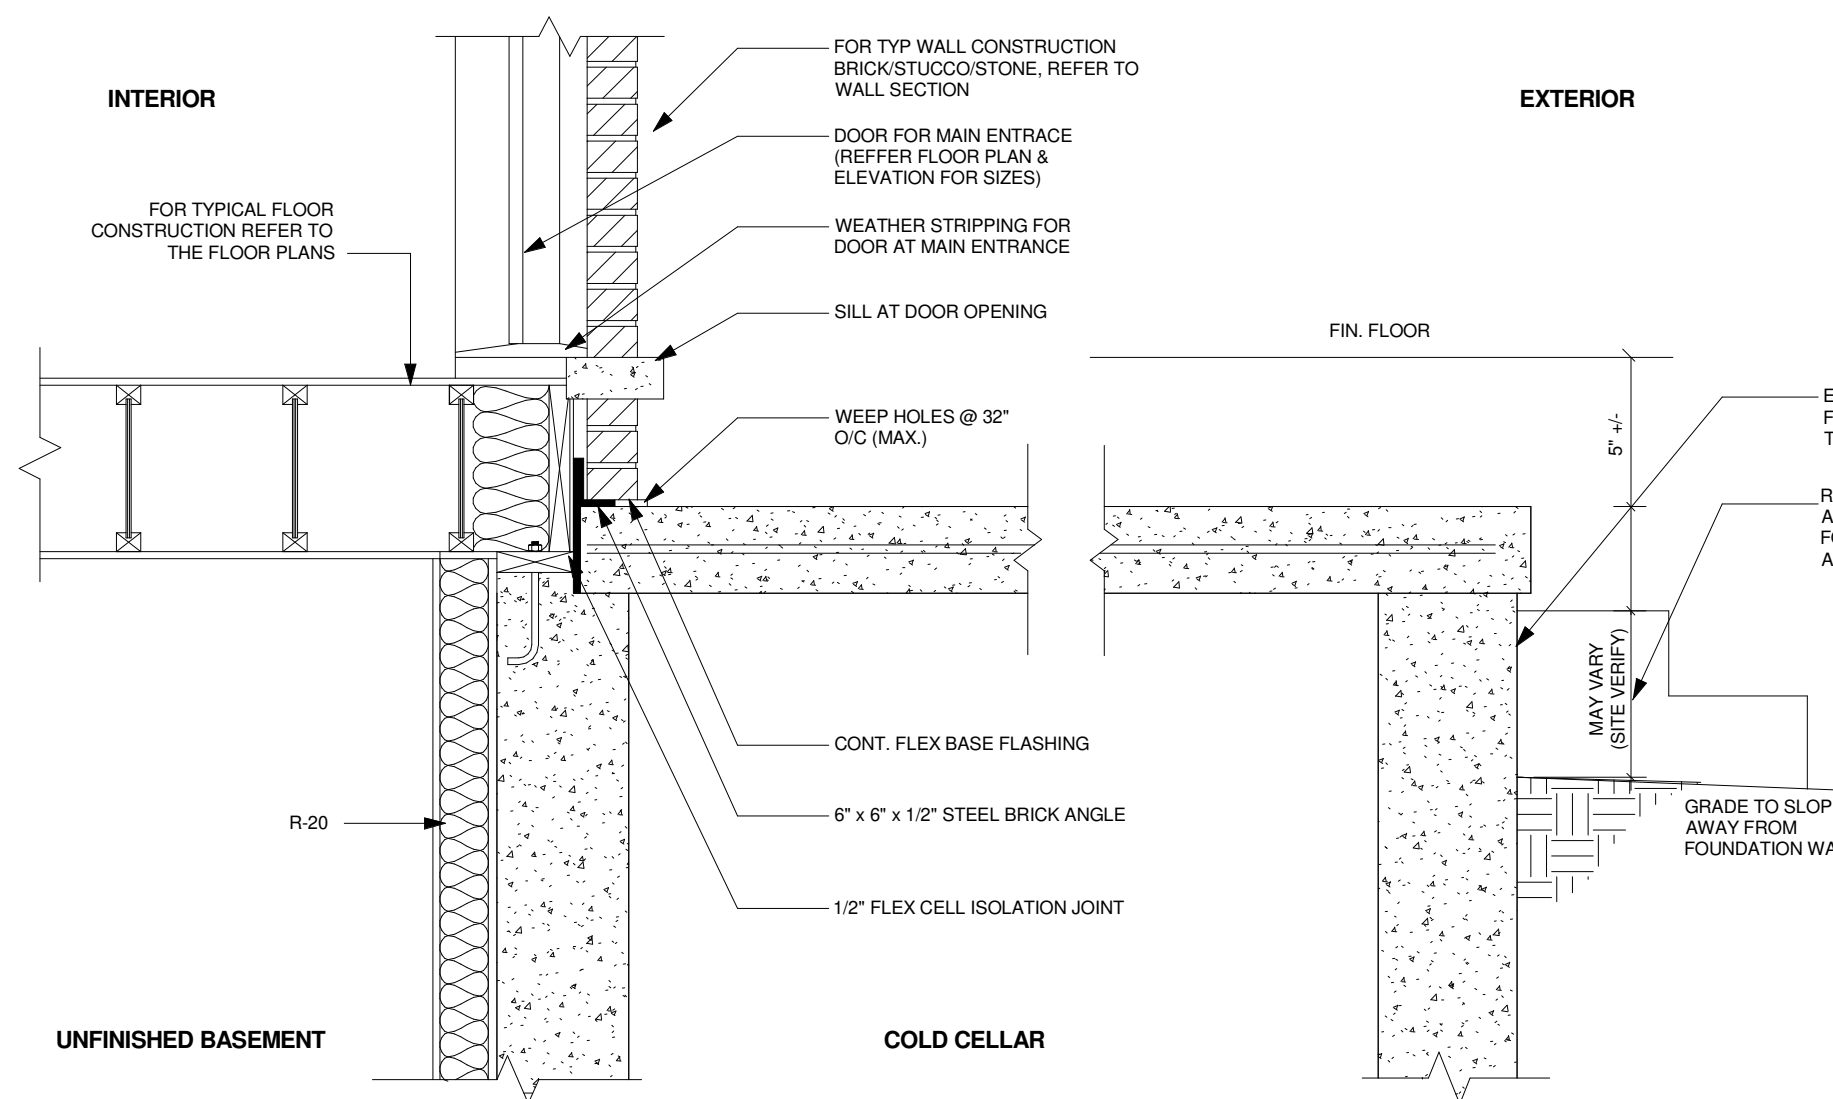


2 TYP. ENTRY PORCH SLAB DETAIL
A-08 N.T.S

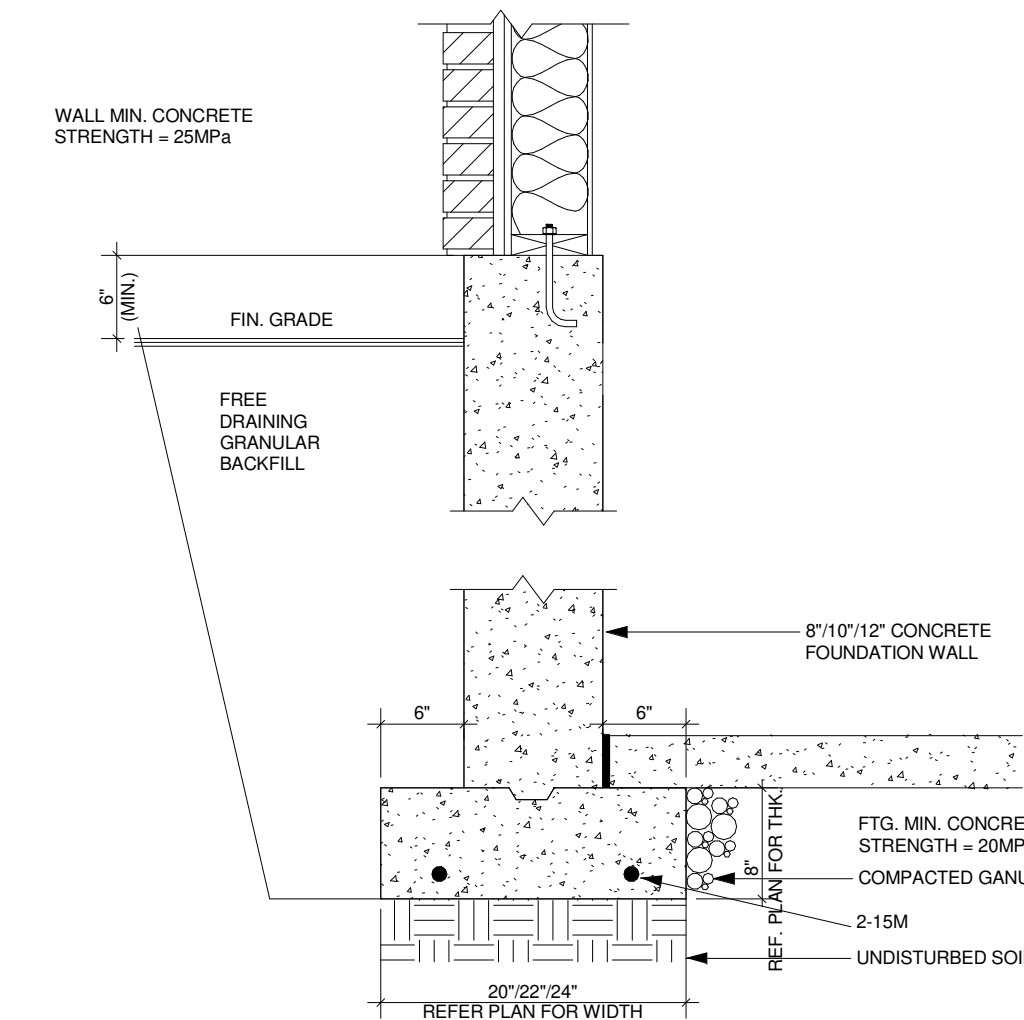


3 TYP. WALL FOUNDATION - STRIP FOOTING
A-08 N.T.S

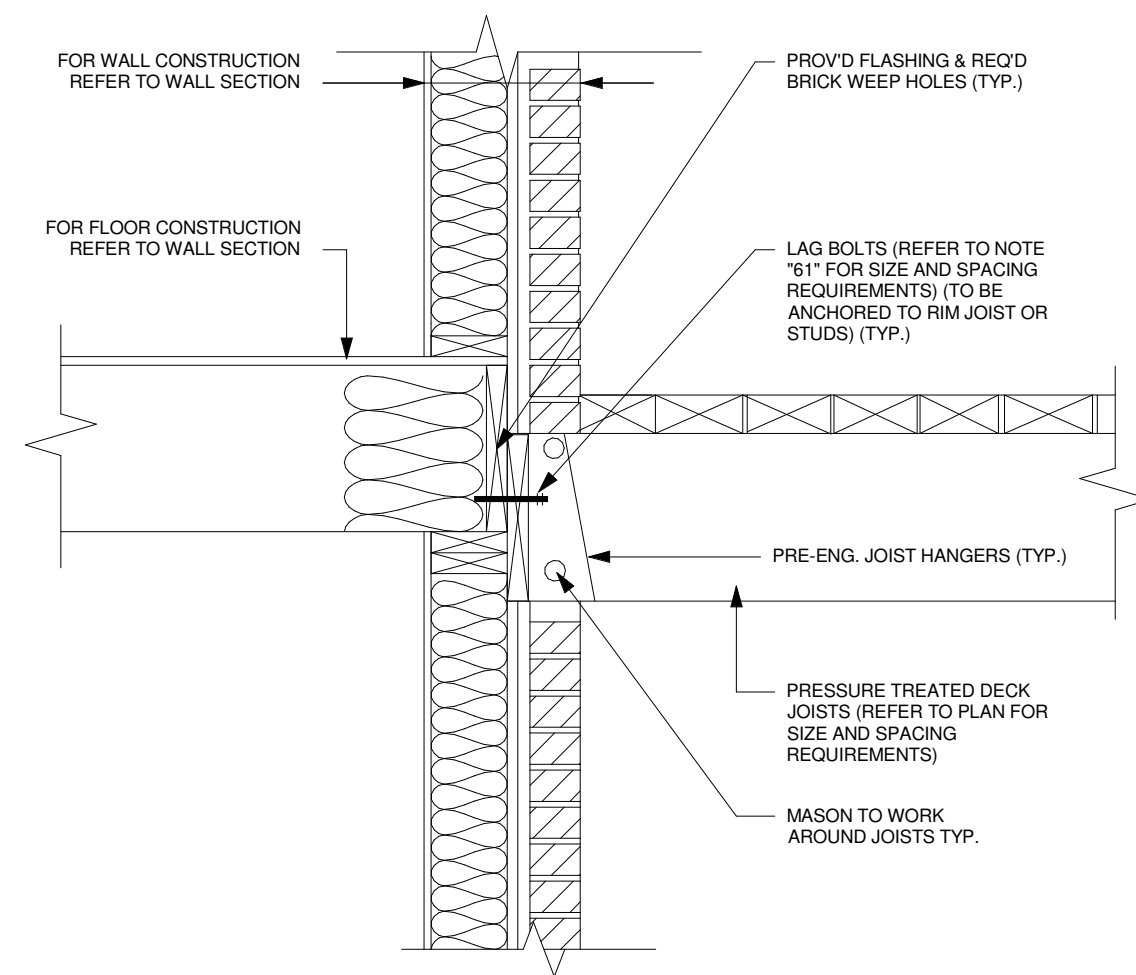


4 TYP. DECK CONNECTION @ EXTERIOR WALL
A-08 N.T.S

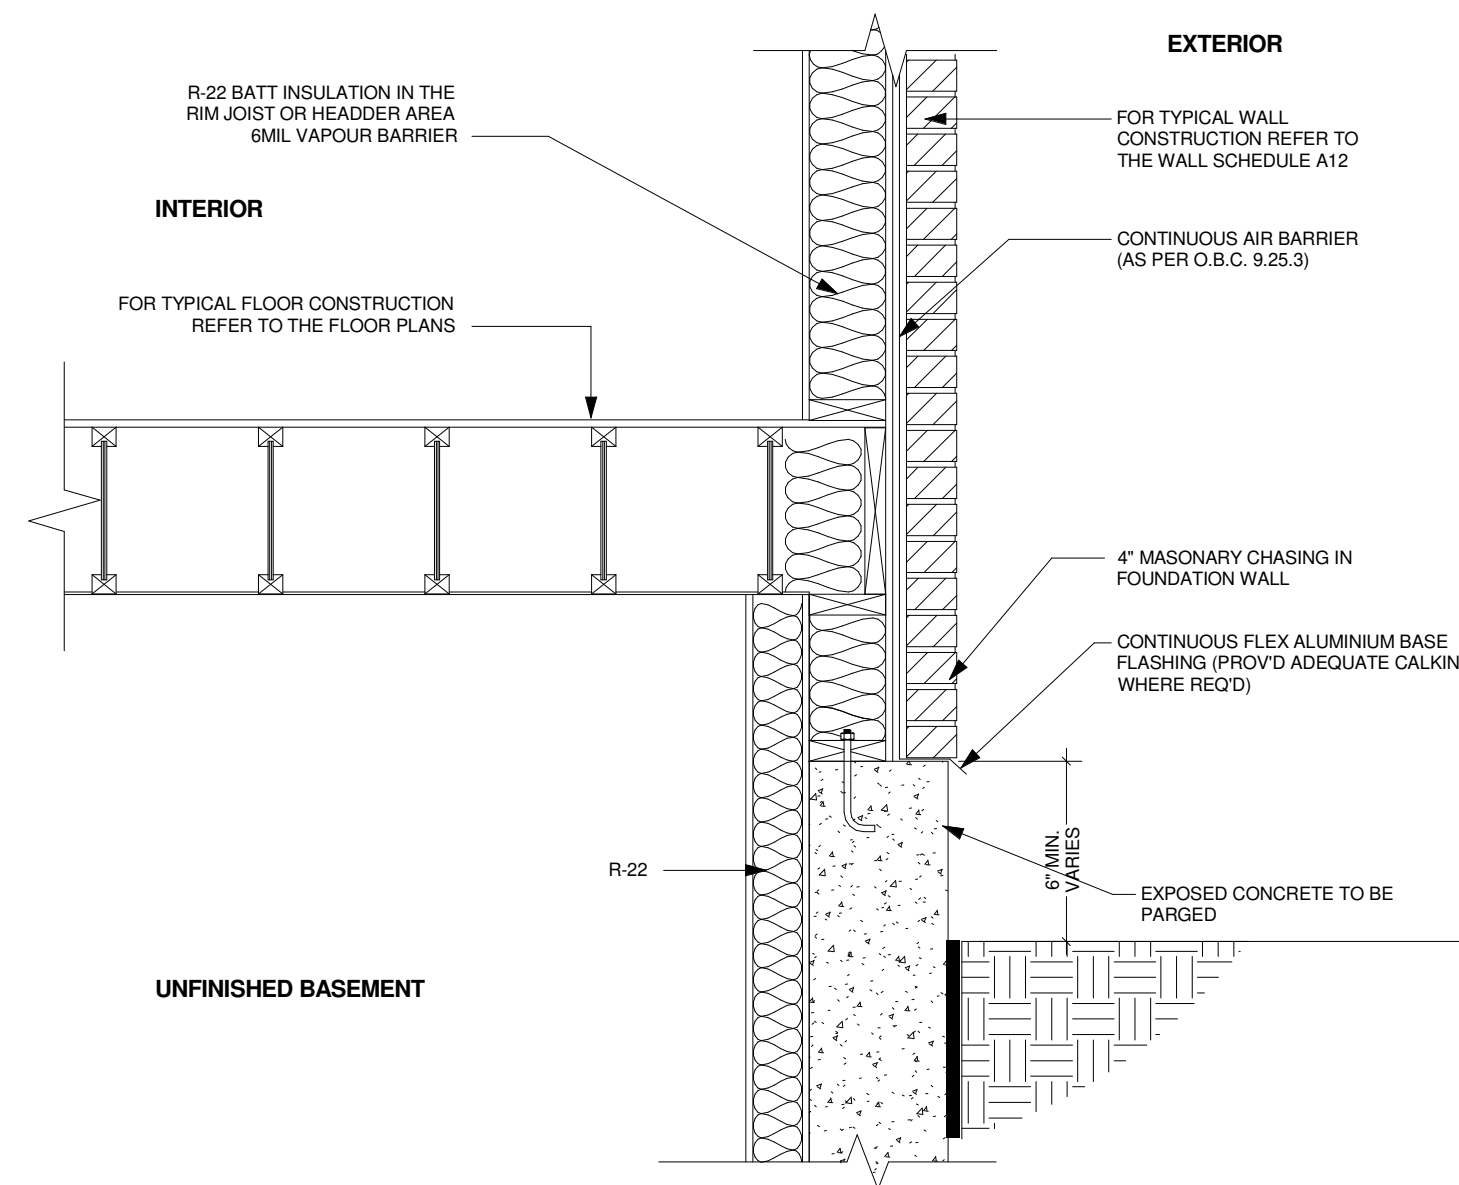


5 TYP. FLOOR JOIST TO FOUNDATION CONNECTION DETAIL
A-08 N.T.S

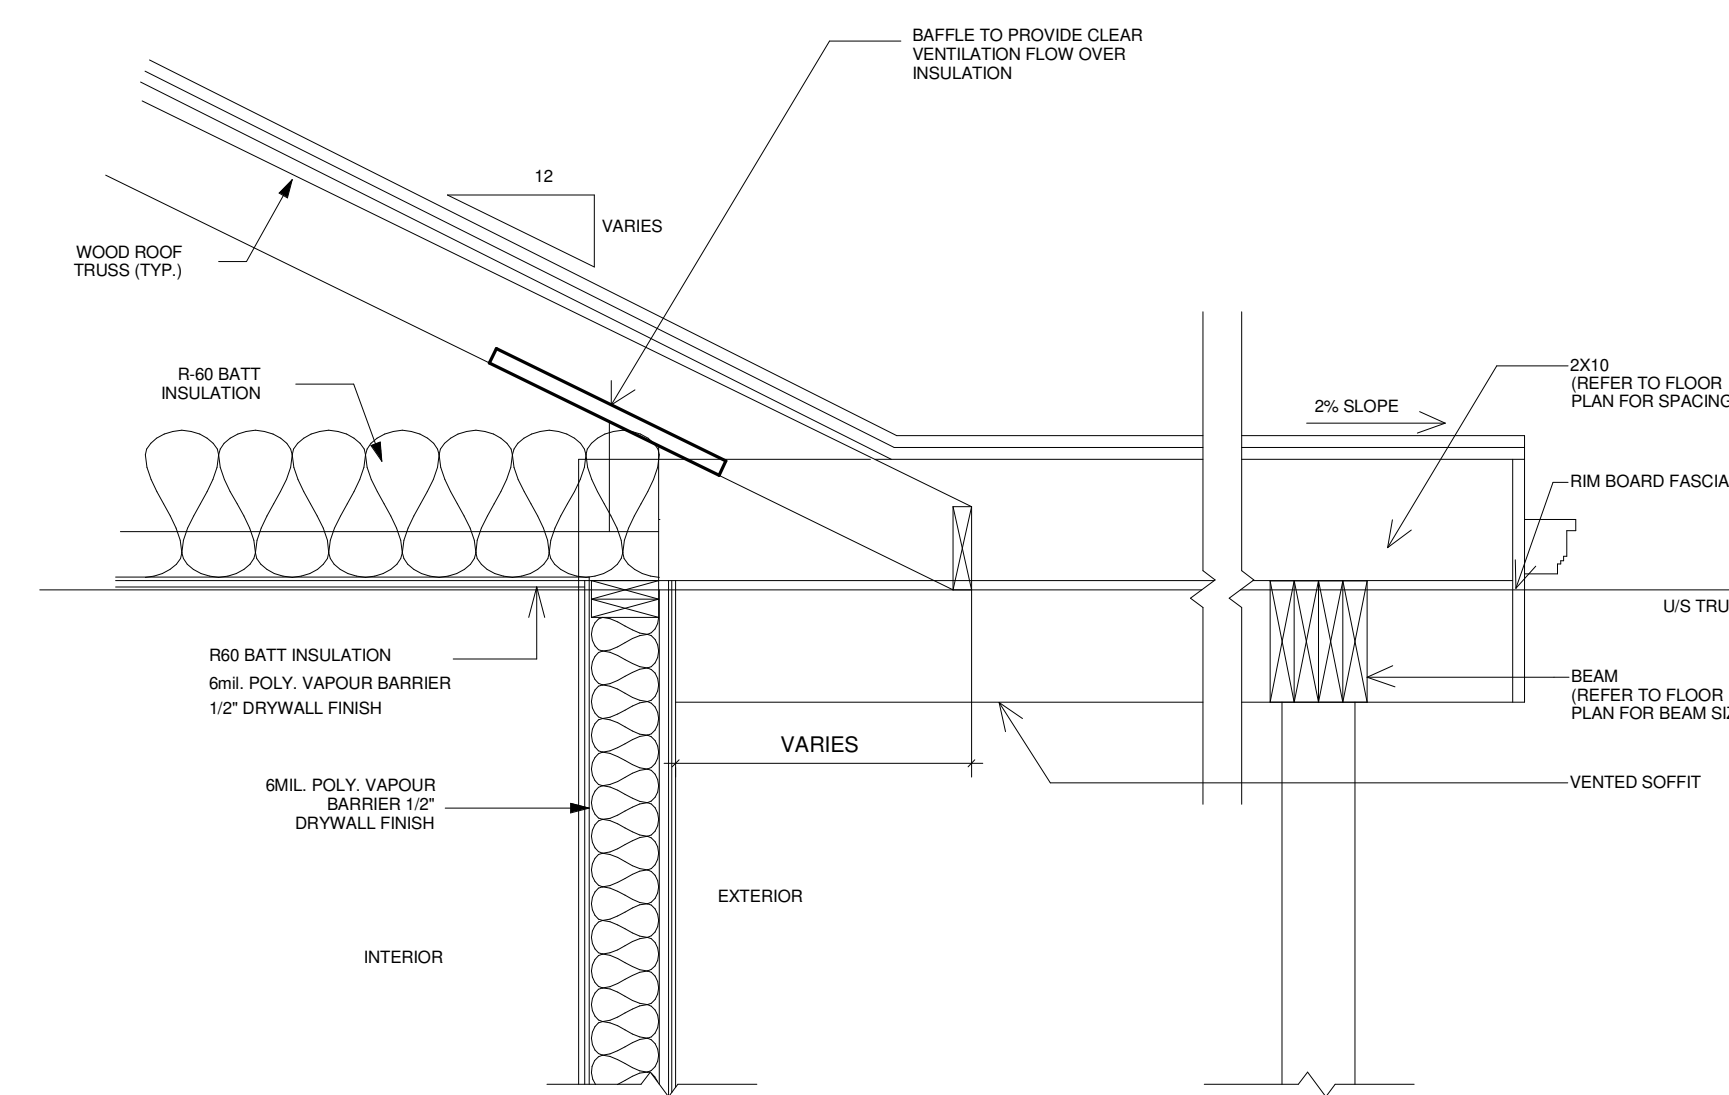


6 OVER FRAMING DETAIL (OR AS PER TRUSS MANUFACTURER'S DRAWING)
A-08 N.T.S

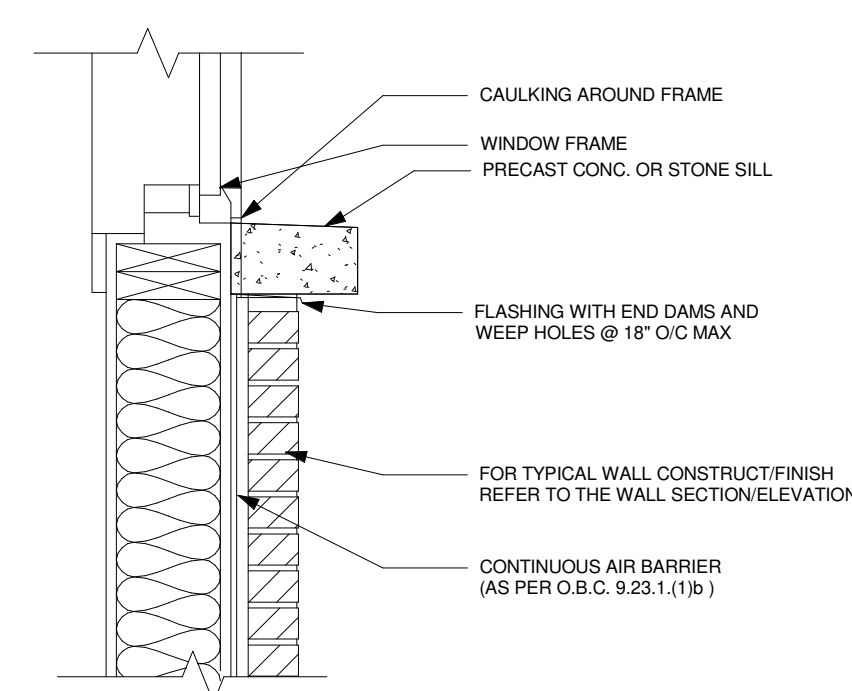


7 TYP. SILL DETAIL
A-08 N.T.S

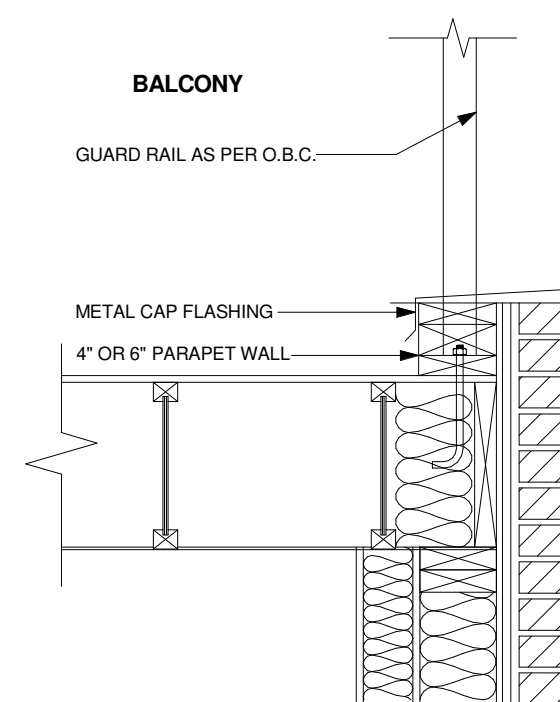

8 BALCONY AND PARAPET DETAIL
A-08 N.T.S

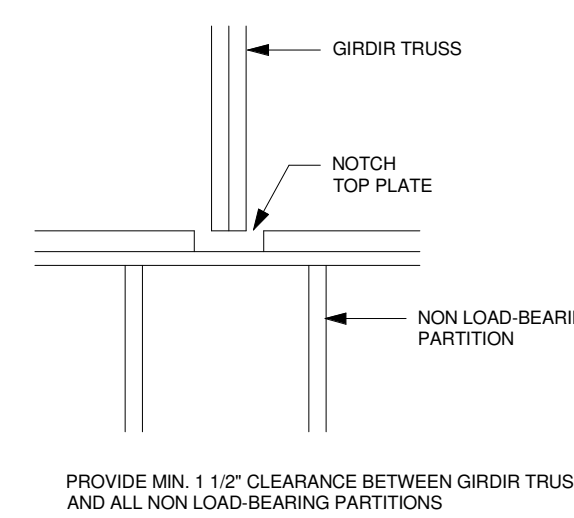

9 TYP. GIRDIR TRUSS @ NON LOAD-BEARING PARTITIONS
A-08 N.T.S

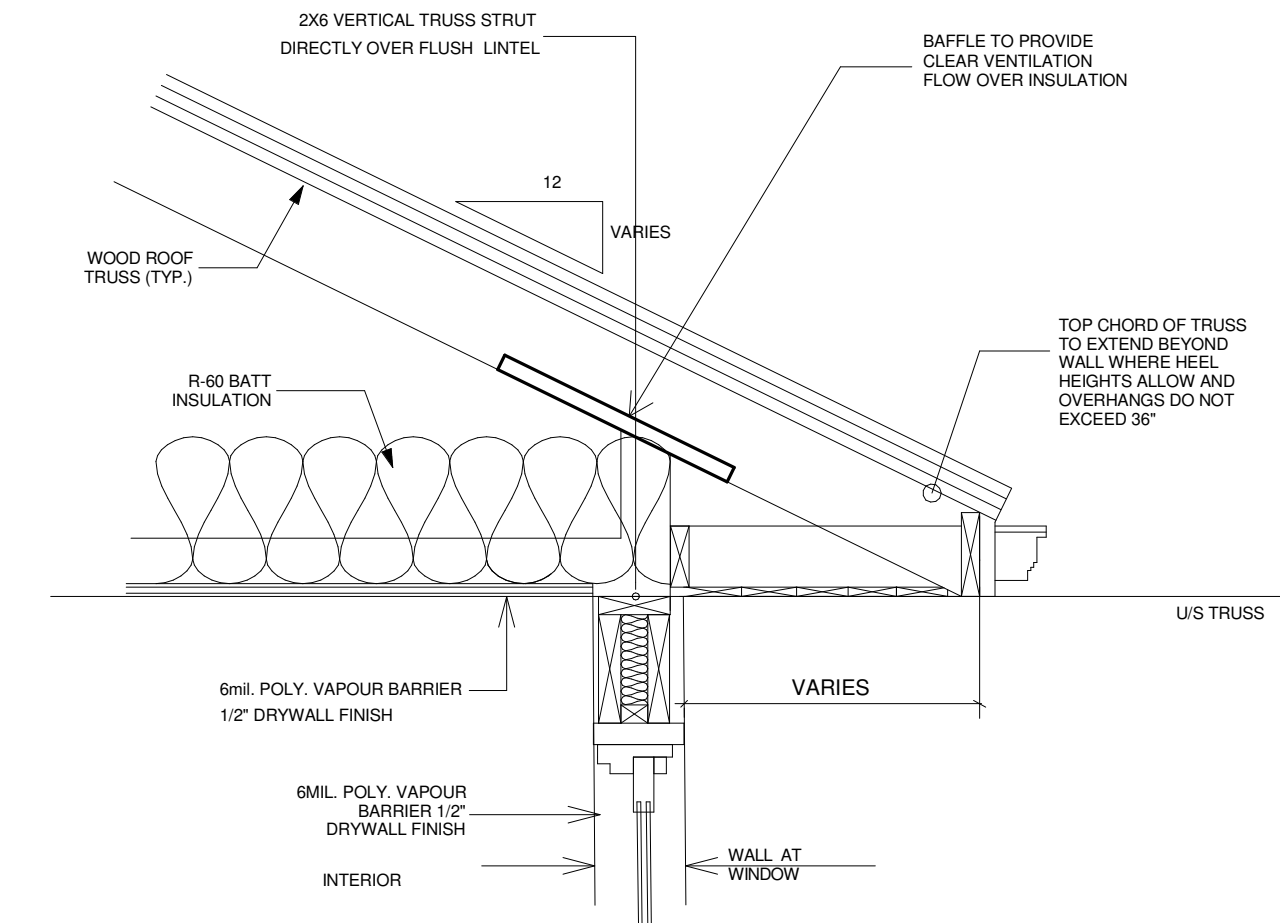

10 OVERHANG DETAIL AT LINTEL (OR AS PER TRUSS MANUFACTURER'S DRAWING)
A-08 N.T.S

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QUALIFICATION INFORMATION REQUIRED UNLESS THE DESIGN IS EXEMPT UNDER DIVISION C - 3.2.5.1 OF THE 2012 ONTARIO BUILDING CODE:

NILAMRAJ (RAJ) PATEL 100621
NAME SIGNATURE BCIN
REGISTRATION INFORMATION REQUIRED UNLESS THE DESIGN IS EXEMPT UNDER DIVISION C - 3.2.4.1 OF THE 2012 ONTARIO BUILDING CODE:
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No.:	Revision:	Date:
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FOR REVIEW ONLY
(NOT FOR PERMIT)

2	Issued For Review	2022/07/30
1	Issued For Review	2022/06/30
No.:	Issued For:	Date:

Drawing Title:
TYPICAL DETAILS

Project:
**LOT-36
PARKER AVENUE, TOWN
OF FORT ERIE, PROPOSED
TWO STOREY HOUSE**

Scale:
Drawn by: MJ
Checked by: RP
Project No.:
Date: 2022/05/14
Drawing No.:



A08

EXCAVATION AND BACKFILL

- EXCAVATION SHALL BE UNDERTAKEN IN SUCH A MANNER SO AS TO AVOID ANY DAMAGE TO EXISTING STRUCTURES AROUND, ADJACENT PROPERTY AND UTILITIES.

- THE TOPSOIL AND VEGETABLE MATTER IN UNEXCAVATED AREAS UNDER A BUILDING SHALL BE REMOVED. THE BOTTOM OF EXCAVATIONS OR FOUNDATIONS SHALL BE FREE OF ALL ORGANIC MATERIAL.

- IF TERMITES ARE KNOWN TO EXIST, ALL STUMPS, ROOTS AND WOOD DEBRIS SHALL BE REMOVED TO A MINIMUM DEPTH OF 11 3/4" IN EXCAVATED AREAS UNDER A BUILDING, AND THE CLEARANCE BETWEEN UNTREATED STRUCTURAL WOOD ELEMENTS AND THE GROUND SHALL BE NOT LESS THAN 17 3/4".

- BACKFILL WITHIN 23 5/8" OF THE FOUNDATION WALLS SHALL BE FREE OF DELETERIOUS DEBRIS AND BOULDERS OVER 9 7/8" IN DIAMETER.

DAMP-PROOFING AND DRAINAGE

- IN NORMAL SOIL CONDITIONS, THE EXTERIOR SURFACES OF FOUNDATIONS FOUND ENCLOSED BASEMENTS AND CRAWL SPACES SHALL BE DAMP-PROOFED. WHERE HYDROSTATIC PRESSURE OCCURS, A WATERPROOFING SYSTEM IS REQUIRED.

- MASONRY FOUNDATION WALLS SHALL BE PARGED WITH 1/4" OF MORTAR COVERED OVER THE FOOTING PRIOR TO DAMP-PROOFING.

- 4" FOUNDATION DRAINS SHALL BE LAID ON LEVEL UNDISTURBED GROUND ADJACENT TO THE FOOTINGS AT OR BELOW THE TOP OF THE BASEMENT SLAB OR CRAWL SPACE FLOOR, AND SHALL BE COVERED WITH 6" OF CRUSHED STONE. FOUNDATION DRAINS SHALL DRAIN TO A STORM SEWER, DRAINAGE DITCH, DRY WELL OR SUMP.

- WINDOW WALLS SHALL BE DRAINED TO THE FOOTING.

- DOWNSPOUTS NOT DIRECTLY CONNECTED TO A STORM SEWER SHALL HAVE EXTENSIONS TO CARRY THE WATER AWAY FROM THE BUILDING, AND PROVISIONS SHALL BE MADE TO PREVENT SOIL EROSION.

- CONCRETE SLABS IN ATTACHED GARAGES SHALL BE SLOPED TO DRAIN TO THE EXTERIOR.

- THE BUILDING SITE SHALL BE GRADED SO THAT SURFACE, SUMP AND ROOF DRAINAGE WILL NOT ACCUMULATE AT OR NEAR THE BUILDING AND WILL NOT ADVERSELY AFFECT ADJACENT PROPERTIES.

FOUNDATION WALLS

- TO BE POURED CONCRETE, UNIT MASONRY OR PRESERVED WOOD (SEE DRAWINGS FOR TYPE AND THICKNESS)

- DAMP-PROOFING SHALL BE A HEAVY COAT OF BITUMINOUS MATERIAL.

- FOUNDATION WALL TO EXTEND MINIMUM 6" ABOVE FINISHED GRADE.

- A DRAINAGE LAYER IS REQUIRED ON THE OUTSIDE OF A FOUNDATION WALL WHERE THE INTERIOR INSULATION EXTENDS MORE THAN 2'-11" BELOW EXTERIOR GRADE.

- A DRAINAGE LAYER SHALL CONSIST OF:

- MIN. 3/4" MINERAL FIBRE INSULATION WITH MIN. DENSITY OF 3.6LB/SF

- MIN. 4" OF FREE DRAINAGE GRANULAR MATERIAL, OR AN APPROVED SYSTEM WHICH PROVIDES EQUIVALENT PERFORMANCE

- FOUNDATION WALLS SHALL BE BRACED OR HAVE THE FLOOR JOISTS INSTALLED BEFORE BACKFILLING.

FOOTINGS

- MINIMUM 20 MPa POURED CONCRETE.

- MINIMUM 48" BELOW FINISHED GRADE.

- FOOTINGS SHALL BE FOUNDED ON NATURAL UNDISTURBED SOIL, ROCK OR COMPACTED GRANULAR FILL WITH MINIMUM BEARING CAPACITY OF 75 KPa

- INCREASE FOOTING WIDTH BY 2 5/8" FOR EACH STOREY OF BRICK VENEER SUPPORTED, AND BY 5 1/8" FOR EACH STOREY OF MASONRY.

- THE PROJECTION OF AN UNREINFORCED FOOTING BEYOND THE WALL SUPPORTED SHALL NOT BE GREATER THAN IT THICKNESS.

STEP FOOTINGS

- VERTICAL RISE 23 5/8" MAX. FOR FIRM SOILS 15 3/4" MAX. FOR SAND OR GRAVEL

- HORIZONTAL RUN 23 5/8" MIN.

CONCRETE FLOOR SLABS

- GARAGE, CARPORT AND EXTERIOR SLABS AND EXTERIOR STEPS SHALL BE 4850PSI (32MPa) CONCRETE WITH 5-5% AIR ENTRAINMENT C/W 6X6 WELDED WIREMESH

- MINIMUM 5" THICK, PLACED ON A MINIMUM 4" OF COARSE, CLEAN, GRANULAR MATERIAL.

- ALL FILL OTHER THAN COARSE CLEAN MATERIAL PLACED BENEATH CONCRETE SLABS SHALL BE COMPACTED TO PROVIDE UNIFORM SUPPORT.

MASONRY VENEER

- MINIMUM 2 3/4" THICK IF JOINTS ARE NOT RAKED AND 3 1/2" THICK IF JOINTS ARE RAKED.

- MINIMUM 1" AIR SPACE TO SHEATHING.

- PROVIDE WEEP HOLES @ 31 1/2" O.C. AT THE BOTTOM OF THE CAVITY AND OVER DOORS AND WINDOWS.

- DIRECT DRAINAGE THROUGH WEEP HOLES WITH 20mil. POLY FLASHING EXTENDING MINIMUM 5 7/8" UP BEHIND THE SHEATHING PAPER.

- VENEER TIES MINIMUM 0.030" THICK X 7/8" WIDE CORROSION RESISTANT STRAPS SPACED @ 23 5/8" VERTICALLY AND 15 3/4" VERTICALLY.

- FASTEN TIES WITH CORROSION RESISTANT 0.125" DIAMETER SCREWS OR SPIRAL NAILS WHICH PENETRATE AT LEAST 1 3/16" INTO STUDS.

MASONRY WALLS

- WHERE CONSTRUCTED OF 3 1/2" BRICK, WALL SHALL BE BONDED WITH HEADER COURSE EVERY 6TH COURSE.

- PROVIDE 2" SOLID MASONRY OR CONTINUOUS 1 1/2" PLATE UNDER ALL ROOF AND FLOOR FRAMING MEMBERS.

- PROVIDE 7 1/2" SOLID MASONRY UNDER BEAMS AND COLUMNS.

- MASONRY WALLS TO BE TIED TO EACH TIER OF JOISTS WITH 1 1/2" X 3 1/8" CORROSION RESISTANT STEEL STRAPS, KEVD MINIMUM 4" INTO MASONRY. WHEN JOISTS ARE PARALLEL TO WALL, TIES ARE TO EXTEND ACROSS AT LEAST 3 JOISTS @ 6'-7" O.C.

- INSIDE BACK OF WALL TO BE PARGED AND COVERED WITH No.15 BREATHER-TYPE ASPHALT PAPER.

- FOR REDUCED FOUNDATION WALLS TO ALLOW A BRICK FACING WHILE MAINTAINING LATERAL SUPPORT, THE MINIMUM 3 1/2" BRICK TO MINIMUM 3 1/2" BACK-UP BLOCK WITH CORROSION RESISTANT TIES AT LEAST 0.028in(2) IN CROSS SECTION AREA, SPACED 7 7/8" VERTICALLY AND 2'-11" HORIZONTALLY, WITH JOINTS COMPLETELY FILLED WITH MORTAR.

- MASONRY OVER OPENINGS SHALL BE SUPPORTED ON CORROSION RESISTANT OR PRIME PAINTED STEEL LINTELS WITH A MINIMUM OF 5 7/8" END BEARING.

WOOD FRAME CONSTRUCTION

- ALL LUMBER SHALL BE SPRUCE-PINE-FIR No. 1&2, AND SHALL BE IDENTIFIED BY A GRADE STAMP.

- MAXIMUM MOISTURE CONTENT 19% AT TIME OF INSTALLATION.

- WOOD FRAMING MEMBERS WHICH ARE SUPPORTED ON CONCRETE IN DIRECT CONTACT WITH SOIL SHALL BE SEPARATED FROM THE CONCRETE WITH 6mil. POLYETHYLENE.

WALLS

- EXTERIOR WALLS SHALL CONSIST OF:

- CLADDING

- 7/16" EXTERIOR GRADE SHEATHING

- 2X6 STUDS @ 16" O.C.

- 2X6 BOTTOM PLATE AND DOUBLE 2X6 TOP PLATE

- INTERIOR LOADBEARING WALLS SHALL CONSIST OF:

- 2X4 STUDS @ 16" O.C.

- 2X4 BOTTOM PLATE AND DOUBLE 2X4 TOP PLATE

- 2X4 MID-GIRTS IF NOT SHEATHED

- 1/2" GYPSUM WALLBOARD

FLOORS

- SEE FLOOR PLANS FOR FLOOR JOIST SIZE AND SPACING.

- JOISTS TO HAVE MINIMUM 1 1/2" OF END BEARING.

- JOISTS SHALL BEAR ON A SILL PLATE FIXED TO FOUNDATION WITH 1/2" ANCHOR BOLTS @ 7'-10" O.C.

- HEADER JOISTS BETWEEN 3'-11" AND 10'-6" IN LENGTH SHALL BE DOUBLED. HEADER JOISTS EXCEEDING 10'-6" SHALL BE SIZED BY CALCULATIONS.

- TRIMMER JOISTS SHALL BE DOUBLED WHEN SUPPORTED HEADER IS BETWEEN 2'-7" AND 6'-7". TRIMMER JOISTS SHALL BE SIZED BY CALCULATIONS WHEN SUPPORTED HEADER EXCEEDS 6'-7".

- 2X2 CROSS BRIDGING REQUIRED NOT MORE THAN 6'-11" FROM EACH SUPPORT AND FROM OTHER ROWS OF BRIDGING.

- JOISTS SHALL BE SUPPORTED ON JOIST HANGERS AT ALL FLUSH BEAMS, TRIMMERS, AND HEADERS.

- JOISTS LOCATED UNDER PARALLEL NON-LOADBEARING PARTITIONS SHALL BE DOUBLED.

ROOFING

- FASTENERS FOR ROOFING SHALL BE CORROSION RESISTANT. ROOFING NAILS SHALL PENETRATE THROUGH OR AT LEAST 1/2" INTO ROOF SHEATHING.

- EVERY ASPHALT SHINGLE SHALL BE FASTENED WITH AT LEAST 4 NAILS.

- EAVES PROTECTION SHALL EXTEND 2'-6" FROM THE INSIDE FACE OF THE EXTERIOR WALL, AND SHALL CONSIST OF TYPE M OR TYPE S ROLL ROOFING Laid MINIMUM 4" HEAD AND END LAPS CEMENTED TOGETHER, OR GLASS FIBRE OR POLYESTER FIBRE COATED BASE SHEETS OR SELF SEALING COMPOSITE MEMBRANES CONSISTING OF MODIFIED BITUMINOUS COATED MATERIAL. EAVE PROTECTION IS NOT REQUIRED FOR UNHEATED BUILDING.

- OPEN VALVEYS SHALL BE FLASHED WITH 2 LAYERS OF ROLL ROOFING, OR 1 LAYER OF SHEET METAL MINIMUM 23 5/8" WIDE.

- FLASHING SHALL BE PROVIDED AT THE INTERSECTION OF SHINGLE ROOFS WITH EXTERIOR WALLS AND CHIMNEYS.

- SHEET METAL FLASHING SHALL CONSIST OF NOT LESS THAN 1/16" SHEET LEAD, 0.013" GALVANIZED STEEL, 0.018" COPPER, 0.018" ZINC, OR 0.019" ALUMINUM.

INSULATION & WEATHERPROOFING

- AS PER OBC SB-12 - PACKAGE A1

- CEILING WITH ATTIC R60 ROOF WITHOUT ATTIC R31 EXTERIOR WALL R22 FOUNDATION WALL R20 EXPOSED FLOOR R31

- SLABS ON GRADE R10 (UNHEATED) R10 (HEATED)

- SUPPLY DUCTS IN UNHEATED SPACES R12

- INSULATION SHALL BE PROTECTED WITH GYPSUM WALLBOARD OR AN EQUIVALENT INTERIOR FINISH, EXCEPT FOR UNFINISHED BASEMENTS WHERE 6mil. POLY IS SUFFICIENT FOR FIBREGLASS TYPE INSULATIONS.

- DUCTS PASSING THROUGH UNHEATED SPACE SHALL BE MADE AIRTIGHT WITH TAPE OR SEALANT.

- CAULKING SHALL BE PROVIDED FOR ALL EXTERIOR DOORS AND WINDOWS BETWEEN THE FRAME AND THE EXTERIOR CLADDING.

- WEATHERSTRIPPING SHALL BE PROVIDED ON ALL DOORS AND ACCESS HATCHES TO THE EXTERIOR, EXCEPT DOORS FROM A GARAGE TO THE EXTERIOR.

- EXTERIOR WALLS, CEILINGS AND FLOORS SHALL BE CONSTRUCTED SO AS TO PROVIDE A CONTINUOUS BARRIER TO THE PASSAGE OF WATER VAPOUR FROM THE INTERIOR AND TO THE LEAKAGE OF AIR FROM THE EXTERIOR.

DOORS AND WINDOWS

- EVERY FLOOR LEVEL CONTAINING A BEDROOM AND NOT SERVED BY AN EXTERIOR DOOR SHALL CONTAIN AT LEAST 1 WINDOW HAVING AN UNOBTSTRUCTED OPEN AREA OF 3 5/8 SF AND NO DIMENSION LESS THAN 15", WHICH IS OPERABLE FROM THE INSIDE WITHOUT TOOLS.

- EXTERIOR HOUSE DOORS AND WINDOWS WITHIN 6'-7" FROM GRADE SHALL BE CONSTRUCTED TO RESIST FORCED ENTRY. DOORS SHALL HAVE A DEADBOLT LOCK.

- THE PRINCIPAL ENTRY DOOR SHALL HAVE EITHER A DOOR VIEWER, TRANSPARENT GLAZING OR A SIDELIGHT.

COLUMNS, BEAMS & LINTELS

- STEEL BEAMS AND COLUMNS SHALL BE SHOP PRIMED.

- MINIMUM 3 1/2" END BEARING FOR WOOD AND STEEL BEAMS, WITH 7 7/8" SOLID MASONRY BENEATH THE BEAM.

- STEEL COLUMNS TO HAVE A MINIMUM OUTSIDE DIAMETER OF 3 1/2" AND MINIMUM WALL THICKNESS OF 1/4".

- WOOD COLUMNS FOR CARPORTS AND GARAGES SHALL BE MINIMUM 3 1/2" X 3 1/2" IN ALL OTHER CASES EITHER 5 1/2" X 5 1/2" OR 7 1/4" ROUND, UNLESS CALCULATIONS BASED ON ACTUAL LOADS SHOW LESSER SIZES ARE ADEQUATE. ALL COLUMNS SHALL BE NOT LESS THAN THE WIDTH OF THE SUPPORTED MEMBER.

- MASONRY COLUMNS SHALL BE MINIMUM OF 1 3/8" X 11 3/8" OR 9 1/2" X 15".

- PROVIDE SOLID BLOCKING THE FULL WIDTH OF THE SUPPORTED MEMBER UNDER ALL CONCENTRATED LOADS.

NOTCHING & DRILLING OF TRUSSES, JOISTS, RAFTERS

REFER TO DATA SHEET BY LVL.

SMOKE AND CARBON MONOXIDE DETECTORS/ALARMS

AT LEAST ONE SMOKE ALARM SHALL BE INSTALLED ON OR NEAR THE CEILING ON EACH FLOOR AND BASEMENT LEVEL 2'-11" OR MORE ABOVE AN ADJACENT LEVEL.

- SMOKE ALARMS SHALL BE INTERCONNECTED IN ELECTRICAL CIRCUIT WITH BATTERY BACKUP, AND LOCATED SUCH THAT ONE IS WITHIN 16'-5" OF EVERY BEDROOM DOOR, IN EVERY BEDROOM, AND NO MORE THAN 49'-3" TRAVEL DISTANCE FROM ANY POINT ON A FLOOR. SMOKE ALARMS SHALL HAVE A VISUAL SIGNALLING COMPONENT CONFORMING TO THE REQUIREMENTS OF NFPA 72 "NATIONAL FIRE ALARM AND SIGNALLING CODE"

- A CARBON MONOXIDE DETECTOR SHALL BE INSTALLED ON OR NEAR THE CEILING IN EVERY ROOM CONTAINING A SOLID FUEL BURNING FIREPLACES OR STOVE.

GARAGE GASPROOFING

- THE WALLS AND CEILING OF AN ATTACHED GARAGE SHALL BE CONSTRUCTED AND SEALED SO AS TO PROVIDE AN EFFECTIVE BARRIER TO EXHAUST FUMES.

- ALL PLUMBING AND OTHER PENETRATIONS THROUGH THE WALLS AND CEILING SHALL BE CAULKED

- DOORS BETWEEN DWELLING AND ATTACHED GARAGE MAY NOT OPEN INTO A BEDROOM AND SHALL BE WEATHERSTRIPPED AND HAVE A SELF-CLOSER.

ROOF & CEILINGS

- SEE DRAWING A-03 FOR RAFTER, ROOF JOIST AND CEILING JOIST SIZE AND REQUIREMENTS.

- HIP AND VALLEY RAFTER SHALL BE 2" DEEPER THAN COMMON RAFTERS.

- 2X4 COLLAR TIES @ RAFTER SPACING WITH 1X4 CONTINUOUS BRACE AT MID SPAN IF ROOF EXCEEDS 7'-10" IN LENGTH.

- SEE DRAWING A-03 FOR ROOF SHEATHING REQUIREMENTS.

ACCESS TO ATTICS AND CRAWL SPACES

- ACCESS HATCH MINIMUM 19 3/4" X 2'-4" TO BE PROVIDED TO EVERY CRAWL SPACE AND EVERY ROOF SPACE WHICH IS 108 SF OR MORE IN AREA AND MORE THAN 23 5/8" IN HEIGHT.

STAIRS

- MINIMUM RISE 125 MM (OBC TABLE 9.8.4.1)

- MINIMUM RUN 255 MM

- MINIMUM HEADROOM 1950 MM

- MINIMUM WIDTH 860 MM

- TAPERED STAIRS SHALL HAVE A RUN THAT (OBC 9.8.4.3) a) IS NOT LESS THAN 150 MM AT THE NARROW END OF THE TREAD, & b) COMPLIES WITH THE DIMENSIONS FOR RECTANGULAR TREADS SPECIFIED IN TABLE 9.8.4.1. WHEN MEASURED AT A POINT 300 MM FROM THE CENTRE LINE OF THE INSIDE HANDRAIL.

- WINDERS (OBC 9.8.4.5) WHICH CONVERGE TO A POINT IN STAIRS MUST TURN THROUGH AN ANGLE OF NO MORE THAN 90(deg.), WITH NO LESS THAN 300(deg.) OR MORE THAN 450(deg.) PER TREAD. SET OF WINDERS MUST BE SEPARATED BY 3'-11" ALONG THE RUN OF THE STAIR.

- A LANDING SHALL BE (OBC 9.8.6.3) a) AT LEAST AS WIDE AS THE WIDTH OF THE STAIR OR RAMP IN WHICH THEY OCCUR, AND b) AT LEAST AS LONG AS THE WIDTH OF THE STAIR OR RAMP IN WHICH THEY OCCUR.

- THE CLEAR HEIGHT OVER LANDINGS SHALL BE NOT LESS THAN 1950 mm (OBC 9.8.6.4) STEPS IN SHALL BE NOT LESS THAN 1950 mm (OBC 9.8.2.2) STEPS IN SPIRAL STAIRS SHALL BE NOT LESS THAN 1980 mm (OBC 9.8.4.5A)

- EXTERIOR CONCRETE STAIRS WITH MORE THAN 2 RISERS REQUIRE FOUNDATIONS.

HANDRAILS AND GUARDS

- A HANDRAIL IS REQUIRED FOR INTERIOR STAIRS CONTAINING MORE THAN 2 RISERS AND EXTERIOR STAIRS CONTAINING MORE THAN 3 RISERS.

- GUARDS ARE REQUIRED AROUND EVERY ACCESSIBLE SURFACE WHICH IS MORE THAN 23 5/8" ABOVE THE ADJACENT LEVEL.

- INTERIOR AND EXTERIOR GUARDS MIN. 2'-11 1/2" HIGH. EXTERIOR GUARDS SHALL BE 3'-6 1/8" HIGH WHERE HEIGHT ABOVE ADJACENT SURFACES EXCEEDS 5'-11"

- GUARDS SHALL HAVE NO OPENINGS GREATER THAN 4" AND NO MEMBER BETWEEN 4" AND 2'-11 1/2" THAT WILL FACILITATE CLIMBING.

PLUMBING - SEE FLOOR PLANS

- EVERY DWELLING REQUIRES A KITCHEN SINK, LAVATORY, WATER CLOSET, BATHTUB OR SHOWER STALL AND THE INSTALLATION OR AVAILABILITY OF LAUNDRY FACILITIES.

- A FLOOR DRAIN SHALL BE INSTALLED IN THE BASEMENT, AND CONNECTED TO THE SANITARY SEWER WHERE GRAVITY DRAINAGE IS POSSIBLE. IN OTHER CASES, IT SHALL BE CONNECTED TO A STORM DRAINAGE SYSTEM, DITCH OR DRY WELL.

NATURAL VENTILATION

- EVERY ROOF SPACE ABOVE AN INSULATED CEILING SHALL BE VENTILATED WITH UNOBTSTRUCTED OPENINGS EQUAL TO NOT LESS THAN 1/300 OF INSULATED AREA.

- INSULATED ROOF SPACES NOT INCORPORATING AN ATTIC SHALL BE VENTILATED WITH UNOBTSTRUCTED OPENINGS EQUAL TO NOT LESS THAN 1/150 OF INSULATED AREA.

- ROOF VENTS SHALL BE UNIFORMLY DISTRIBUTED AND DESIGNED TO PREVENT THE ENTRY OF RAIN, SNOW OR INSECTS.

- UNHEATED CRAWL SPACES SHALL BE PROVIDED WITH 1.1 SF OF VENTILATION FOR EACH 538 SF.

- MINIMUM NATURAL VENTILATION AREAS, WHERE MECHANICAL VENTILATION IS NOT PROVIDED, ARE:

BATHROOMS 0.97 SF

OTHER ROOMS 3 SF

UNFINISHED BASEMENTS 0.2% OF FLOOR AREA

EXTERIOR WALLS

- NO WINDOWS OR OTHER UNPROTECTED OPENINGS ARE PERMITTED IN EXTERIOR WALLS LESS THAN 3'-11" FROM PROPERTY LINES.

- 5/8" FIRE RATED DRYWALL SHALL BE INSTALLED ON THE INSIDE FACE OF ATTACHED GARAGE EXTERIOR WALLS AND GABLE ENDS OF ROOFS WHICH ARE LESS THAN 3'-11" FROM PROPERTY LINES.

- NON COMBUSTIBLE CLADDING SHALL BE INSTALLED ON ALL EXTERIOR WALLS LESS THAN 23 5/8" FROM PROPERTY LINES.

CERAMIC TILE

- WHEN CERAMIC TILE IS APPLIED TO A MORTAR BED WITH ADHESIVE, THE BED SHALL BE A MINIMUM OF 1/2" THICK & REINFORCED WITH GALVANIZED DIAMOND MESH LATH APPLIED OVER POLYETHYLENE ON SUBFLOORING ON JOISTS AT NO MORE THAN 16" O.C. WITH AT LEAST 2 ROWS OR CROSS BRIDGING.

ELECTRICAL

- AN EXTERIOR LIGHT CONTROLLED BY AN INTERIOR SWITCH IS REQUIRED AT EVERY ENTRANCE.

- A LIGHT CONTROLLED BY A SWITCH IS REQUIRED IN EVERY KITCHEN, BEDROOM, LIVING ROOM, UTILITY ROOM, LAUNDRY ROOM, DINING ROOM, BATHROOM, VESTIBULE, HALLWAY, GARAGE AND CARPORT. A SWITCHED RECEPTACLE MAY BE PROVIDED INSTEAD OF A LIGHT IN BEDROOMS AND LIVING ROOMS.

- STAIRS SHALL BE LIGHTED, AND EXCEPT WHERE SERVING AN UNFINISHED BASEMENT SHALL BE CONTROLLED BY A 3 WAY SWITCH AT THE HEAD AND FOOT OF THE STAIRS.

- BASEMENTS REQUIRE A LIGHT FOR EACH 323 SF, CONTROLLED BY A SWITCH AT THE HEAD OF THE STAIRS.

MECHANICAL VENTILATION

- A MECHANICAL VENTILATION SYSTEM IS REQUIRED WITH A TOTAL CAPACITY AT LEAST EQUAL TO THE SUM OF:

- 10 CFM EACH FOR BASEMENT AND MASTER BEDROOM

- 5 CFM FOR EACH OTHER ROOM

- A PRINCIPLE DWELLING EXHAUST FAN SHALL BE INSTALLED AND CONTROLLED BY A CENTRALLY LOCATED SWITCH IDENTIFIED AS SUCH.

- SUPPLEMENTAL EXHAUST SHALL BE INSTALLED SO THAT THE TOTAL CAPACITY OF ALL KITCHEN, BATHROOM AND OTHER EXHAUSTS, LESS THE PRINCIPAL EXHAUST, IS NOT LESS THAN THE TOTAL REQUIRE CAPACITY.

- A HEAT RECOVERY VENTILATOR MAY BE EMPLOYED IN LIEU OF EXHAUST TO PROVIDE VENTILATION. AN HRV IS REQUIRED IF ANY SOLID FUEL BURNING APPLIANCES ARE INSTALLED.

- SUPPLY AIR INTAKES SHALL BE LOCATED SO AS TO AVOID CONTAMINATION FROM EXHAUST OUTLETS.

FASTENERS FOR SHEATHING AND SUBFLOORING

O.B.C. 9.23.3.5

ELEMENT

MINIMUM LENGTH FOR FASTENERS, in

MINIMUM NUMBER OR MAXIMUM SPACING OF FASTENERS

COMMON OR SPIRAL NAILS

RING THREAD NAILS OR SCREWS

ROOFING NAILS

STAPLES

BOARD LUMBER 7 1/4" OR LESS WIDE

BOARD LUMBER MORE THAN 7 1/4" WIDE

FIBREBOARD SHEATHING UP TO 1/2" THICK

GYPSUM SHEATHING UP TO 1/2" THICK

PLYWOOD, OSB OR WAFERBOARD UP TO 3/8" THICK

PLYWOOD, OSB OR WAFERBOARD FROM 3/8" TO 13/16" THICK

PLYWOOD, OSB, OR WAFERBOARD OVER 13/16" THICK

DRAWING NOTES

- FINISHED FLOOR ELEVATION 0'-0" SHOWN ON ARCHITECTURAL DRAWINGS REFERS TO TOP OF PLYWOOD SUBFLOORING, AND REFERENCE SURVEYOR OF RECORD DOCUMENTS FOR ELEVATION ABOVE SEA LEVEL.
- WHEN REFERENCE IS MADE TO A PARTICULAR MANUFACTURED SYSTEM, ALL PARTS AND MATERIALS APPLICABLE SHALL BE SUPPLIED AND INSTALLED.
- IF THE CONTRACTOR OBSERVES ANY ERRORS, DISCREPANCIES, OR OMISSIONS IN THE CONTRACT DOCUMENTS, HE SHALL PROMPTLY NOTIFY THE LICENSED DESIGNER. THE CONTRACTOR PROCEEDS WITH WORK AFFECTED BY SUCH ERRORS, DISCREPANCIES, OR OMISSIONS WITHOUT RECEIVING CLARIFICATION, HE DOES SO AT HIS OWN SUCH CIRCUMSTANCES MADE BY THE CONTRACTOR, PRIOR TO APPROVAL BY RISK. ANY ADJUSTMENTS INVOLVING THE LICENSED DESIGNER, SHALL BE AT THE CONTRACTOR'S RISK AND ANY COMPLICATIONS OR DISPUTES ARISING THEREFROM SHALL BE AT THE CONTRACTOR'S EXPENSE.
- EXIT DOORS SHALL BE OPERABLE FROM THE INSIDE WITHOUT USE OF A KEY, TOOL OR SPECIAL KNOWLEDGE.
- FIRE DEPARTMENT ACCESS

DOOR SCHEDULE		
Mark	Width	Height

D1	2' - 8"	6' - 8"
D2	5' - 0"	8' - 0"
D3	16' - 0"	7' - 0"
D4	2' - 8"	6' - 8"
D5	5' - 0"	6' - 8"
D6	2' - 8"	6' - 8"
D7	4' - 0"	6' - 8"
D8	2' - 4"	6' - 8"
D9	2' - 8"	6' - 8"
D10	2' - 8"	6' - 8"
D11	2' - 8"	7' - 0"
D12	2' - 8"	6' - 8"
D13	2' - 4"	6' - 8"
D14	2' - 4"	6' - 8"
D15	2' - 8"	6' - 8"
D16	5' - 0"	6' - 8"
D17	2' - 8"	6' - 8"
D18	5' - 0"	6' - 8"
D19	2' - 4"	6' - 8"
D20	2' - 8"	6' - 8"
D21	2' - 8"	6' - 8"
D22	5' - 0"	6' - 8"

WINDOW SCHEDULE		
Mark	Width	Height

W1	2' - 6"	2' - 0"
W2	3' - 11"	2' - 8"
W3	2' - 6"	2' - 0"
W4	2' - 0"	6' - 0"
W5	2' - 0"	3' - 0"
W6	2' - 0"	5' - 0"
W7	5' - 0"	5' - 0"
W8	5' - 0"	3' - 0"
W9	2' - 0"	2' - 0"
W10	2' - 0"	3' - 0"
W11	3' - 0"	3' - 0"
W12	2' - 0"	5' - 0"
W13	2' - 0"	5' - 0"
W14	5' - 0"	5' - 0"
W15	5' - 0"	5' - 0"
W16	2' - 0"	5' - 0"
W17	4' - 0"	5' - 0"
W18	2' - 0"	5' - 0"
W19	2' - 0"	5' - 0"
W20	2' - 0"	5' - 0"
W21	2' - 0"	7' - 0"
W22	2' - 0"	7' - 0"
W23	2' - 0"	2' - 0"
W24	2' - 0"	2' - 0"

DOOR & WINDOW SCHEDULES ARE FOR REFERENCE ONLY.
DESIGNER IS NOT LIABLE FOR ANY DISCREPANCY.

WINDOW SUPPLIER TO ENSURE DOORS & WINDOWS ARE AS PER
OBC STANDARD INCLUDING MINIMUM OPENABLE OPENINGS

Contractor and trader must check and verify all dimensions before
execute the work and must report discrepancies and should not scale
or measure the drawings.

All drawings, specifications and related documents are the copyright
of the designer and must be returned upon request.

All the work must be in compliance with Ontario Building Code.

Reproduction of drawings, specifications and related documents
in part or whole is forbidden without the written consent.

This drawing is not to be used for construction until signed and
stamped by the designer.

THE UNDERSIGNED HAS REVIEWED AND TAKEN RESPONSIBILITY
FOR THIS DESIGN AND HAS THE QUALIFICATION AND MEETS THE
REQUIREMENTS SET OUT IN ONTARIO BUILDING CODE TO BE A
DESIGNER.

QUALIFICATION INFORMATION REQUIRED UNLESS THE
DESIGN IS EXEMPT UNDER DIVISION C - 3.2.5.1 OF THE 2012
ONTARIO BUILDING CODE.

NILAMRAJ (RAJ) PATEL 100621

NAME SIGNATURE BCIN

REGISTRATION INFORMATION REQUIRED UNLESS THE DESIGN IS
EXEMPT UNDER DIVISION C - 3.2.4.1 OF THE 2012 ONTARIO
BUILDING CODE.

RPDS 111189

FIRM NAME BCIN



No.:	Revision:	Date:
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FOR REVIEW ONLY
(NOT FOR PERMIT)

2	Issued For Review	2022/07/30
1	Issued For Review	2022/06/30

No.:	Issued For:	Date:
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Client Name:

Drawing Title:

DOOR & WINDOW
SCHEDULE

Project:

LOT-36
PARKER AVENUE, TOWN
OF FORT ERIE, PROPOSED
TWO STOREY HOUSE

Scale:

Drawn by:

MJ

Checked by:

RP

Project No.:

Date:

2022/05/14

Drawing No.:

A10

