THE CITY OF NIAGARA FALLS REGIONAL MUNICIPALITY OF NIAGARA STACKED TOWNHOMES DEVELOPMENT

5858 DUNN STREET, NIAGARA FALLS, ONTARIO

ZONING STATISTICS

CURRENT ZONE - R4+DH PROPOSED ZONE - R5C (Site Specific)					
DESCRIPTION	ALLOWED/REQUIRED	PROPOSED SITE SPECIFICATION			
MINIMUM LOT AREA	100 SQ. MT. FOR EACH UNIT	101 SQ.MT. FOR EACH UNIT			
MINIMUM LOT FRONTAGE	30 MT. (98.4 FT.)	51.03 MT. (167'-5")			
MINIMUM FRONT YARD DEPTH	7.50 MT. (24.61 FT.)	5.14 MT. (16'-10") (FROM ROAD WIDENING LINE) 16.41 MT. (53'-10") (FROM C/L OF DUNN STREET)			
MINIMUM INTERIOR SIDE YARD WIDTH	ONE-HALF BUILDING HT. 5.80 MT. (19 FT.)	BUILDING-A = 4.04 MT. (13'-3") BUILDING-B, C & D = 4.34 MT. (14'-3")			
MINIMUM EXTERIOR SIDE YARD WIDTH	7.50 MT. (24.61 FT.)	NA			
MINIMUM REAR YARD DEPTH	ONE-HALF BUILDING HT. 5.80MT. (19 FT) OR 10M WHICHEVER IS GREATER	3.0 MT.(9'-10") (FROM SOUTHERN BOUNDARY			
MAXIMUM LOT COVERAGE	30%	27.81% (INCL. BASEMENT PATIO AREA)			
MAXIMUM BUILDING HEIGHT	19.00 MT. (62.3 FT.)	11.61 MT. (38'-1") APPROX.			
MINIMUM LANDSCAPED OPEN SPACE	40% OF LOT AREA	37.02% (EXCL. BASEMENT PATIO AREA 41.46% (INCL .BASEMENT PATIO AREA			
NUMBER OF APARTMENT DWELLINGS ON ONE LOT	1	4			
NUMBER OF PARKING SPACES PER UNIT	1.4 SPACE/ UNIT (72 UNITS X 1.4 = 100 PARKING)	1.10 SPACE/ UNIT (72 UNITS X 1.10 = 79 PARKING)			
MINIMUM PARKING STALL WIDTH	2.75 MT.	2.77 MT. (9'-1")			
MINIMUM PARKING STALL LENGTH	6.00 MT.	6.00 MT. (19'-8")			
MINIMUM AMENITY AREA (No. 79-200_AM-2022-003 Part 2)	20 SQ.MT./ UNIT	27.51 SQ.MT./ UNIT (TBD)			
MINIMUM WIDTH OF MANOEUVRING AISLE	6.3 MT. (20'-8" FT.)	6.00 MT. (19'-8")			

	CRES)	SQ.FT.	SQ.MT.	%	
0.73	(1.80)	78577.72	7300.11	100.00	
TOTAL BUILDING FOOTRPINT AREA			~2030.45	27.81	
PROPOSED STREET/SURFACE PARKING AREA			~2567.33	35.17	
PROPOSED LANDSCAPE & HARDSCAPE			~2702.33	37.02	
PROPOSED LOT COVERAGE			 VED 30%)		
OPOSED GFA)		•	,,		
	A DPOSED GFA)	A DPOSED GFA) = 62251 SC	~21855.57 ~27634.46 ~29087.69 27.81 (ALLOW OPOSED GFA) = 62251 SQ.FT. (5783.31 SQ.MT.	~21855.57 ~2030.45 ~27634.46 ~2567.33 ~29087.69 ~2702.33 27.81 (ALLOWED 30%)	

NO. OF STOREY: 3 (KIND OF 2.5 STOREY; RECESSED TOP FLOOR WITH TERRACE AS AMENITY SPACE

DIUI DINC DESCRIPTION		NO. OF	TYP. UNIT AREA		FLOOR AREA	
BUILDING DESCRIPTION			~SQ.FT.	~SQ.MT.	~SQ.FT.	~SQ.MT.
	1ST UNIT (BASEMENT)	5	744.60	69.18	3723	345.88
BUILDING A	2ND UNIT (FIRST FLOOR)	5	680.60	63.23	3403	316.15
	3RD UNIT -SECOND FLOOR & THIRD FLOOR	4	1172.25	108.91	4689	435.62
	-SECOND FLOOR AND NO THIRD FLOOR	1	776	72.09	776	72.09
	1ST UNIT (BASEMENT)	5	744.60	69.18	3723	345.88
BUILDING B	2ND UNIT (FIRST FLOOR)	5	681.80	63.34	3409	316.71
	3RD UNIT (SECOND FLOOR & THIRD FLOOR)	5	1170.00	108.70	5850	543.48
	1ST UNIT (BASEMENT)	7	761.43	70.74	5330	495.17
BUILDING C	2ND UNIT (FIRST FLOOR)	7	688.29	63.94	4818	447.61
	3RD UNIT (SECOND FLOOR & THIRD FLOOR)	7	1170.14	108.71	8191	760.97
	1ST UNIT (BASEMENT)	7	761.43	70.74	5330	495.17
BUILDING D	2ND UNIT (FIRST FLOOR)	7	688.29	63.94	4818	447.61
	3RD UNIT (SECOND FLOOR & THIRD FLOOR)	7	1170.14	108.71	8191	760.97
	TOTAL	72	~11209.51	~1041.40	~62251	~5783.31

ARKING SUMMARY				SNOW STORAGE
QUIRED STALLS UNITS X 1.4 = 100 STALLS				APPROX. 3.89 % OF SITE AREA
OPOSED STALLS UNITS X 1.10 = 79 STALLS				
GULAR RRIER FREE ADING	- - -	75 04 00		

TOTAL STALLS - 79



DRAWING LIST

A-3.0 | ELEVATIONS - STACKED T.H. (BLOCK A)

A-3.1 ELEVATIONS - STACKED T.H. (BLOCK A)

A-3.2 ELEVATIONS - STACKED T.H. (BLOCK A)

A-3.3 | ELEVATIONS - STACKED T.H. (BLOCK B)

A-3.4 | ELEVATIONS - STACKED T.H. (BLOCK B)

A-3.5 | ELEVATIONS - STACKED T.H. (BLOCK B)

A-3.6 | ELEVATIONS - STACKED T.H. (BLOCK C)

A-3.7 | ELEVATIONS - STACKED T.H. (BLOCK C)

A-3.8 ELEVATIONS - STACKED T.H. (BLOCK C)

A-3.12 | ELEVATIONS - STACKED T.H. (BLOCK D)

A-3.13 | ELEVATIONS - STACKED T.H. (BLOCK D)

A-3.14 | ELEVATIONS - STACKED T.H. (BLOCK D)

GRADING PLAN

TITAN DETAILS

SERVICING PLAN

TYPICAL DETAILS AND NOTES

TYPICAL DETAILS AND NOTES

SANITARY DRAINAGE AREAS

SILTATION AND EROSION CONTROL PLAN

PRE DEVELOPMENT STORM DRAINAGE AREAS

POST DEVELOPMENT STORM DRAINAGE AREAS

A-3.9 OP. ELEVATIONS - STACKED T.H. (BLOCK C - 2 STOREY)

A-3.10 OP. ELEVATIONS - STACKED T.H. (BLOCK C - 2 STOREY)

A-3.11 OP. ELEVATIONS - STACKED T.H. (BLOCK C - 2 STOREY)

A-3.15 OP. ELEVATIONS - STACKED T.H. (BLOCK D - 2 STOREY)

A-3.16 OP. ELEVATIONS - STACKED T.H. (BLOCK D - 2 STOREY)


A-3.17 OP. ELEVATIONS - STACKED T.H. (BLOCK D - 2 STOREY)

DWG. NO. TITLE

A-1.0 COVER SHEET

A-2.0 SITE PLAN

SITE SURVEY PLAN

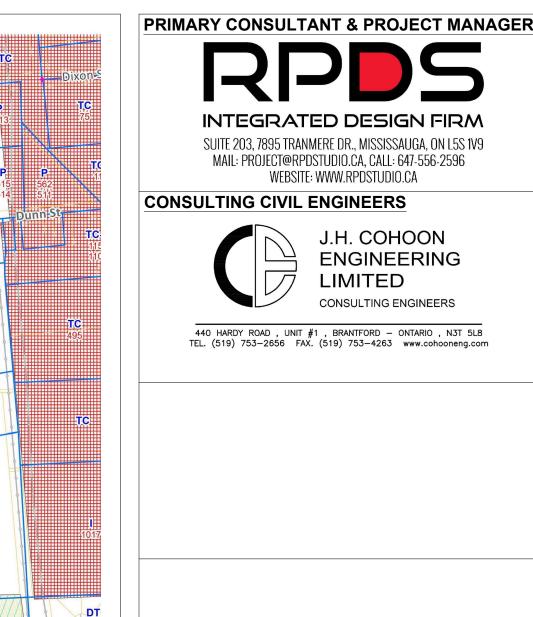

PREPARED BY:

RPDS

(INFORMATION


J.H. COHOON

ENGINEERING

LIMITED

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ENGINEERING

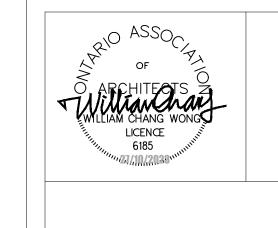

1.	27/10/2023	ISSUED FOR ZONING BY LAW AMENDMENT	
No.	Date	Version	Dwn
PR∩	IECT:		

STACKED TOWNHOMES **DEVELOPMENT**

5858 DUNN STREET, NIAGARA FALLS, ON L2G 2P1 CANADA


DRAWING TITLE:

COVER SHEET

AWN BY:	DATE:
ECKED BY:	SCALE


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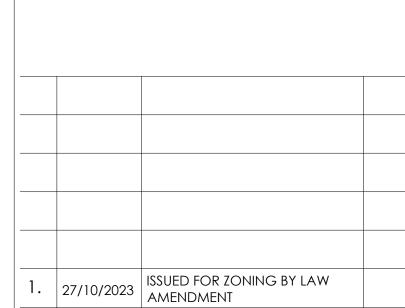
A-1.0

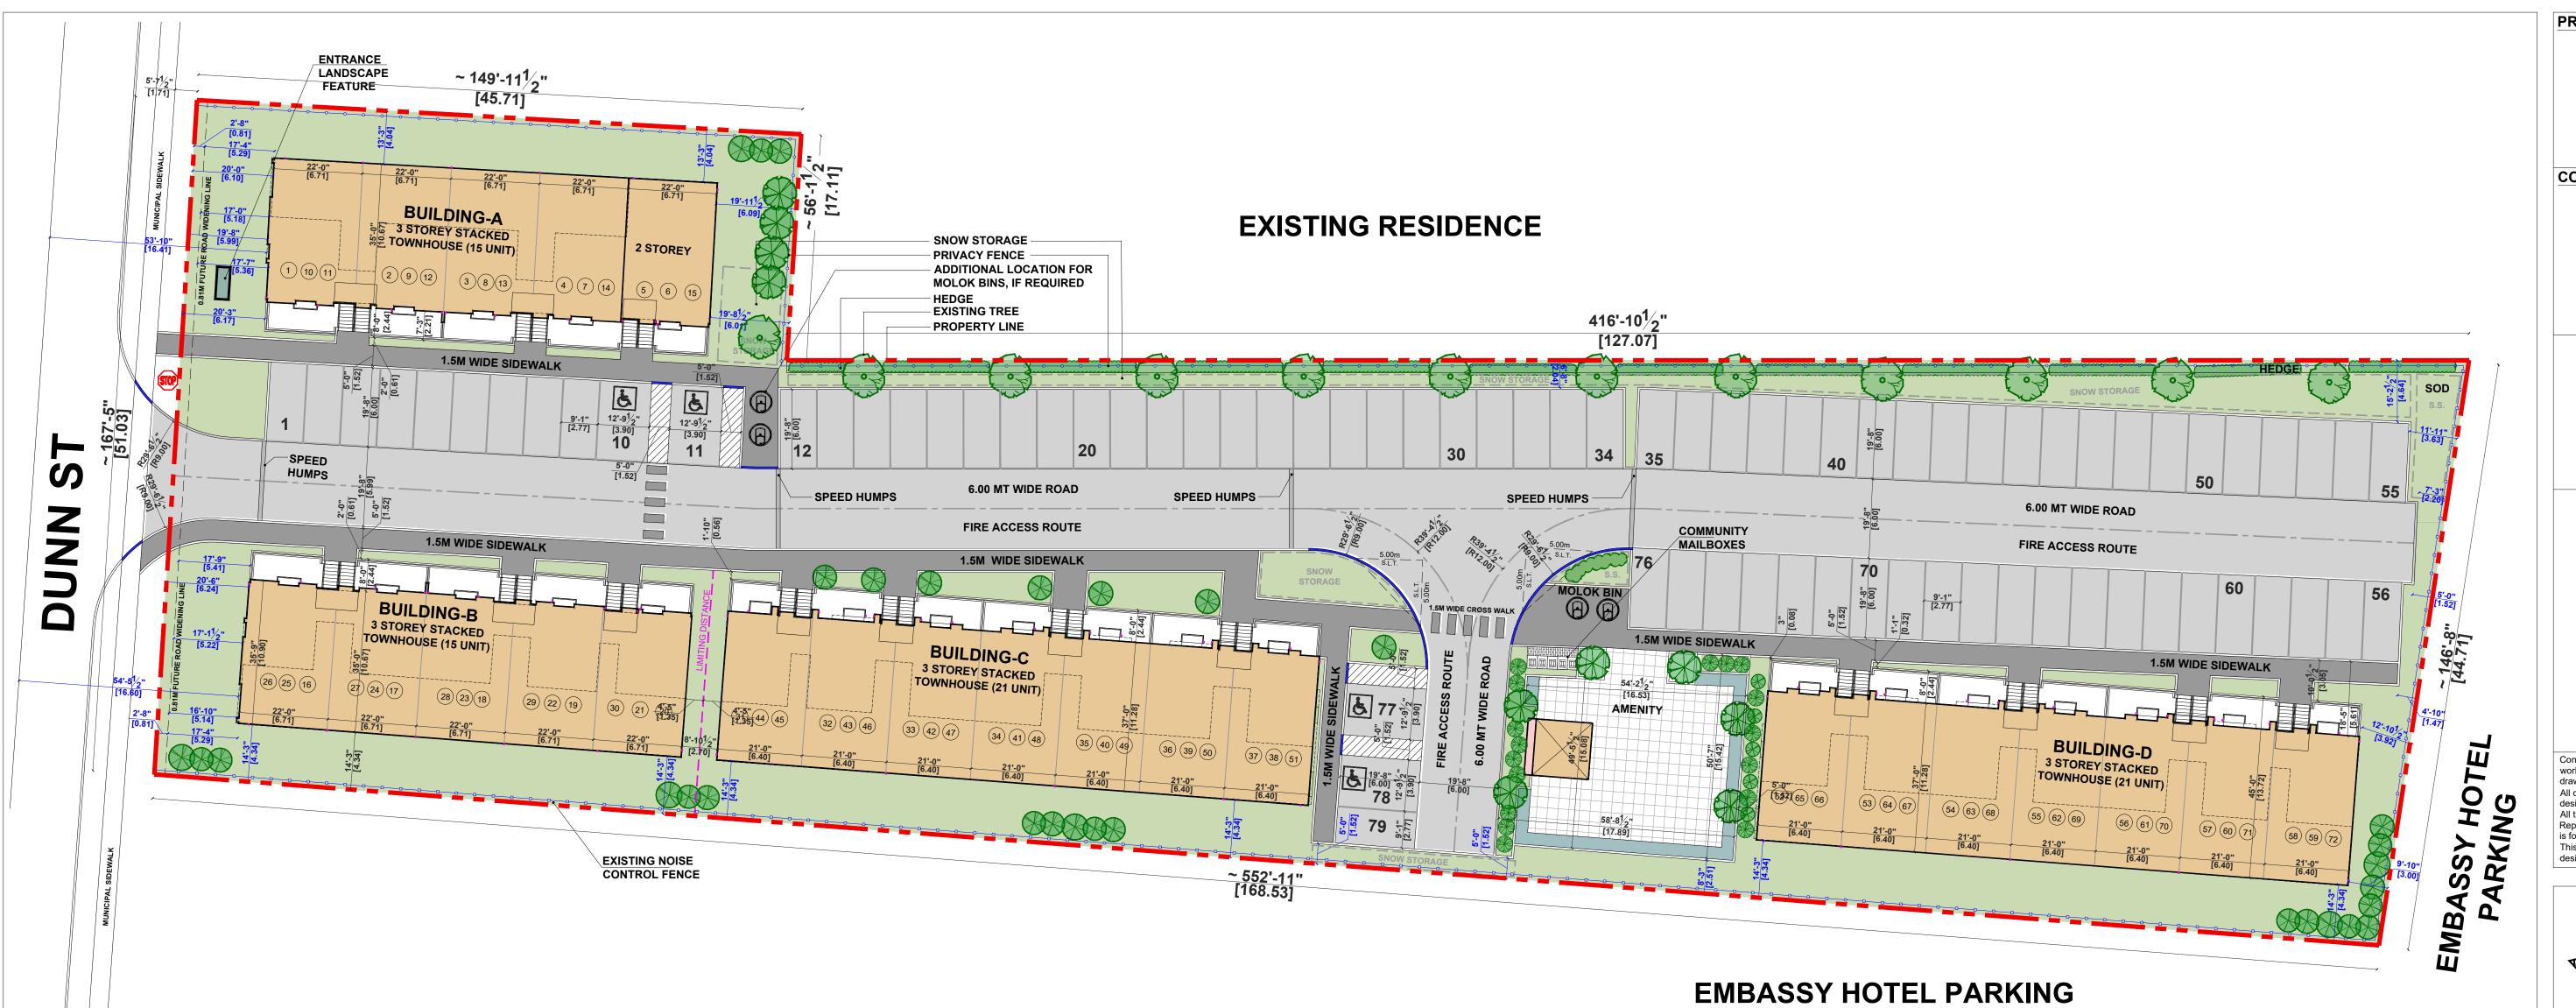

LEGEND :		
•	DOWNSPOUT	
S.S.	SNOW STORAGE	
S.L.T.	SIGHT LIGHT TRIANGLE	
	CONCRETE SIDEWALK	
	PAINTED LINES	
	PROPERTY LINE	
	SOD	
Ė	ACCESSIBLE PARKING SPACE	
-00	PRIVACY FENCE	
-00	EXISTING NOISE CONTROL FENCE	
	CURB CUT/ DEPRESSED SIDE WALK	

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No. Date

STACKED TOWNHOMES **DEVELOPMENT**

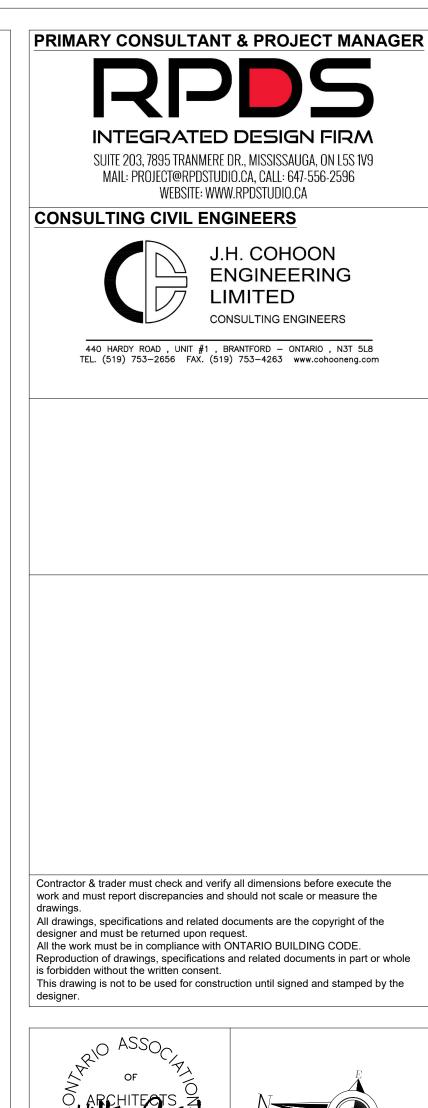5858 DUNN STREET, NIAGARA FALLS, ON L2G 2P1 CANADA

DRAWING TITLE:

SITE PLAN

DATE: DRAWN BY: CHECKED BY: SCALE: 1:250 DRAWING NO .: PROJECT NO.:

A-2.0

BUILDING	UNITS		
А	15		
В	15		
С	21		
D	21		
TOTAL UNITS	72		
REGULAR PARKING	75		
BARRIER FREE PARKING	4		
TOTAL PROPOSED PARKING	79 (1.10 PARKING / UNIT)		

LOT AREA =78577.72 SQ.FT (7300.11 SQ.MT.) - 100% LOT COVERAGE = 21855.57 SQ.FT (2030.45 SQ.MT.) - 27.81%