

_____DC DEPRESSED CURB

SIAMESE

DOOR

CONNECTION

FIRE HYDRANT

EXISTING BUILDING

TO BE DEMOLISHED

TACTILE SURFACE INDICATOR

BARRIER FREE PARKING

ENTRANCE AND / OR EXIT

NEW LIGHT STANDARD, REFER TO ELECTRICAL

TSI TACTILE WARNING SURFACE

EXTERIOR LIGHTING FIXTURE.

MOUNTED ON POLE OR

PROPOSED TREES AND SHRUBS


EX SAN LATERAL

A101 SCALE: 1:500

REFER TO ELECTRICAL

FR FIRE ROUTE ACCESS

BUILDING FACE

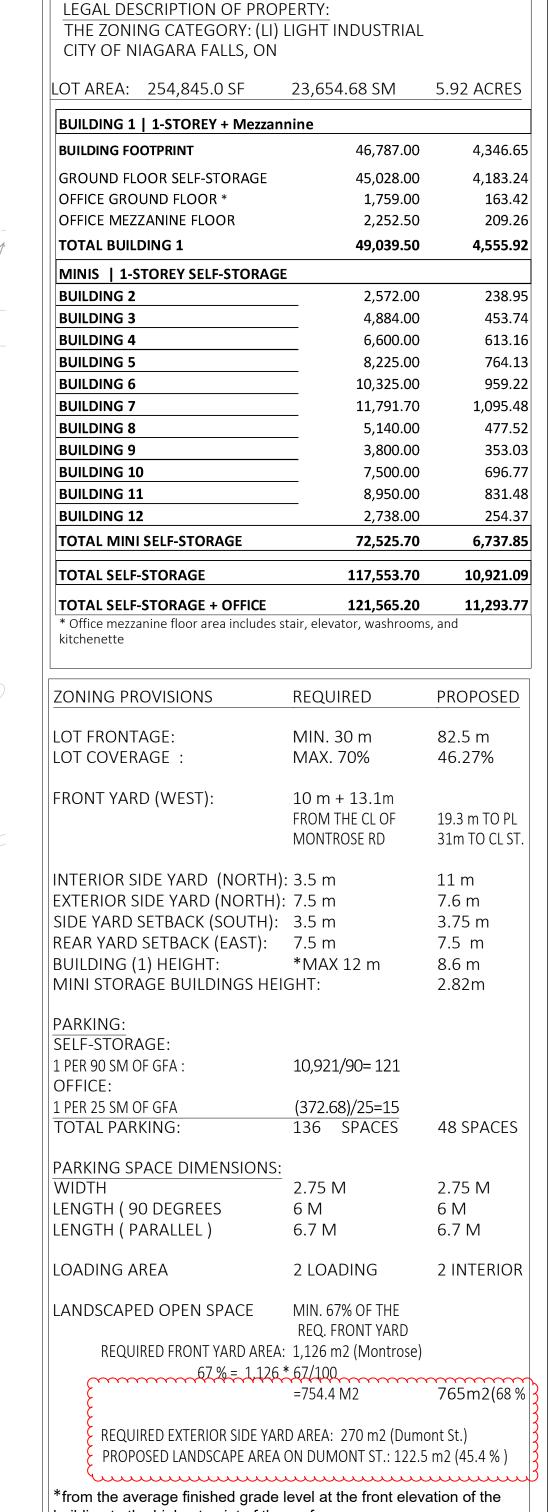

- SURFACE GARBAGE

ON CONCRETE PAD IN AN ENCLOSURE. REFER TO LANDSCAPE

²2,738 SF (254 m2) | F.F.E = 192.90 m

SITE STATISTICS

building to the highest point of the roof

© COPYRIGHT PROTECTED 2020, WPT ARCHITECTURE INC

ISSUED FOR SPA

GENERAL NOTES TYPICAL: CONTRACTOR IS RESPONSIBLE TO VERIFY ALL DRAWINGS, DIMENSIONS, DETAILS, SPECIFICATIONS AND DOCUMENTS, AND VERIFY SITE CONDITIONS, AND REPORT ALL ERRORS, OMISSIONS AND DISCREPANCIES TO THE ARCHITECT IN WRITING PRIOR TO PROCEEDING WITH THE WORK.

 DOCUMENTS ARE TO BE READ IN CONJUNCTION WITH ALL CONSULTANTS'

 DOCUMENTATION.

DOCUMENTATION.

DO NOT SCALE DRAWINGS. DO NOT USE DOCUMENTS FOR CONSTRUCTION UNLESS INDICATED AS "FOR CONSTRUCTION" AND STAMPED AND SIGNED BY THE ARCHITECT PROVINCIAL AND FEDERAL REGULATORY REQUIREMENTS.

ALL DOCUMENTS REMAIN THE PROPERTY OF THE CONSULTANTS AND MAY NOT BE USED OR REPRODUCED WITHOUT WRITTEN PERMISSION.

2023-II-30 ISSUED FOR SPA 4 2023-II-27 ISSUED FOR SPA 3 | 2023-09-10 | ISSUED FOR SPA 2 2023-08-25 FOR COORDINATION

YYYY-MM-DD REVISIONS 30 HANOVER DRIVE, UNIT 3 ST. CATHARINES, ON, L2W 1A3

QUASAR CONSULTING GROUP 250 ROWNTREE DAIRY RD. WOODBRIDGE, ON, L4L 9J7

TEL: 905 688 9400

TEL: 905 507 0800


TEL: 289 952 9404

STRUCTURAL:

9 LEAWOOD COURT ST. CATHARINES, ON, L2T 3R5

CLIENT LOGO:

PROVINCIAL CONSTRUCTION 4382 MONTROSE RD. NIAGARA FALLS, ON, L2H 1K2 TEL: 905 356 3769

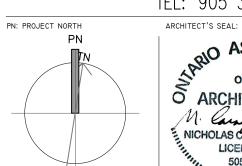



ARCHITECTURE

wpt@wptarchitecture.ca

WPT PROJECT #: | MUNICIPAL #: 2022-0086.01 CLIENT PROJECT #: CLIENT CONTRACT #:

PROJECT NAME AND LOCATION:

SELF-STORAGE 4382 MONTROSE ROAD NIAGARA FALLS, ONTARIO

> OVERALL SITE PLAN -KEY PLAN

SCALE: | SHEET #: DRAWN BY:

XGM/SB

GRAPHIC SCALE | Ïmmmi OVERALL SITE PLAN SITE PLAN BASED ON SURVEY BY SUDA AND MALESZYK SURVEYING INC., CAD FILE 21-209 UNDATED RECEIVED FROM CLIENT ON JUNE. 08, 2023

EX. FF ELEV = 192.85

BUILDING 1

F.F.E = 192.85 m

SELF-STORAGE

 \longrightarrow N 87° 03' 50" $\mathring{1}$

1- STOREY + Mezzannine

FOOTPRINT: 46,787 SF (4,346.65 m2)